

CODE COMPLIANCE

ALL WORK AND MATERIALS SHALL BE PERFORMED AND INSTALLED IN ACCORDANCE WITH THE CURRENT EDITIONS OF THE FOLLOWING CODES AS ADOPTED BY THE LOCAL GOVERNING AUTHORITIES. NOTHING IN THESE PLANS IS TO BE CONSTRUCTED TO PERMIT WORK NOT CONFORMING TO THESE CODES.

1. 2022 CALIFORNIA ADMINISTRATIVE CODE

2. 2022 CALIFORNIA BUILDING CODE

3. 2022 CALIFORNIA ELECTRIC CODE

4. 2022 CALIFORNIA MECHANICAL CODE

5. 2022 CALIFORNIA PLUMBING CODE

6. 2022 CALIFORNIA FIRE CODE

7. ANY LOCAL BUILDING CODE AMENDMENTS

8. CITY/COUNTY ORDINANCES

9. ANSI / TIA-222 STRUCTURAL CODE

10. NFPA 780 - LIGHTING PROTECTION CODE

HANDICAP REQUIREMENTS:
FACILITY IS UNMANNED AND NOT FOR HUMAN HABITATION, AND IS EXEMPTED FROM ACCESSIBILITY REQUIREMENTS IN ACCORDANCE WITH 2022 CALIFORNIA BUILDING CODE SECTION 11B-203.5.

THIS FACILITY IS UNMANNED AND NOT FOR HUMAN HABITATION. A TECHNICIAN WILL VISIT THE SITE AS REQUIRED FOR ROUTINE MAINTENANCE. THE PROJECT WILL NOT RESULT IN ANY SIGNIFICANT DISTURBANCE OR EFFECT ON DRAINAGE. NO SANITARY SEWER SERVICE, POTABLE WATER, OR TRASH DISPOSAL IS REQUIRED AND NO COMMERCIAL SIGNAGE IS NEW.

GENERAL NOTES

THIS FACILITY IS UNMANNED AND NOT FOR HUMAN HABITATION. A TECHNICIAN WILL VISIT THE SITE AS REQUIRED FOR ROUTINE MAINTENANCE. THE PROJECT WILL NOT RESULT IN ANY SIGNIFICANT DISTURBANCE OR EFFECT ON DRAINAGE. NO SANITARY SEWER SERVICE, POTABLE WATER, OR TRASH DISPOSAL IS REQUIRED AND NO COMMERCIAL SIGNAGE IS NEW.


IF CONTRACTOR ENCOUNTERS CONDITIONS IN FIELD, EITHER UNFORESEEN OR IN SOME MANNER IN CONFLICT WITH THESE DRAWINGS, THE CONTRACTOR SHALL NOTIFY THE REGISTERED DESIGN PROFESSIONAL OF SUCH CONDITIONS IN WRITING AND SHALL ACKNOWLEDGE ANY WORK DONE OUTSIDE OF JURISDICTIONAL PERMITTED PLANS IS DONE AT CONTRACTORS OWN RISK.

FOR "SPECIAL INSPECTIONS" SPECIFIC TO THIS PROJECT PURSUANT TO CBC SECTION 1704.3, SEE SHEET T-4, "STATEMENT OF SPECIAL INSPECTIONS"


SUBCONTRACTOR SHALL VERIFY ALL PLANS & EXISTING DIMENSIONS & CONDITIONS ON THE JOB SITE & SHALL IMMEDIATELY NOTIFY THE ENGINEER IN WRITING OF ANY DISCREPANCIES BEFORE PROCEEDING WITH THE WORK OR BE RESPONSIBLE FOR SAME.

FULL SIZE = 24"x36". ANY OTHER SIZE PRINT IS NOT ORIGINAL SCALE.

ALL INDICATED DIMENSIONS SHALL TAKE PRECEDENT OVER SCALED DIMENSIONS.

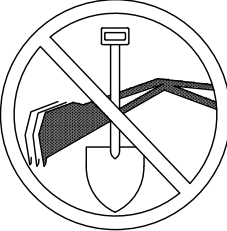

UNDERGROUND SERVICE ALERT
UTILITY NOTIFICATION CENTER OF CALIFORNIA
(800) 422-4133
WWW.CALIFORNIA811.ORG
CALL 2-14 WORKING DAYS UTILITY NOTIFICATION PRIOR TO CONSTRUCTION



SITE INFORMATION

PROPERTY OWNER: GOOD SHEPERD EVANGELICAL LUTHERAN CHURCH OF CLAREMONT

ADDRESS: 1700 N. TOWNE AVENUE
CLAREMONT, CA 91711
(909) 626-2714

COUNTY: LOS ANGELES

ZONING JURISDICTION: CITY OF CLAREMONT

ZONING DISTRICT: --

PARCEL NUMBER: 8303-010-043

OCCUPANCY GROUP: U

CONSTRUCTION TYPE: II-B

POWER COMPANY: SCE

TELEPHONE COMPANY: --

LEASE AREA: 706 SQ. FT.

TOWER OWNER: N/A

ADDRESS: --

TOWER CO SITE ID: N/A

TOWER APP NUMBER: N/A

LATITUDE (NAD 83): 34° 06' 52.80" N
34.114667°

LONGITUDE (NAD 83): 117° 44' 08.43" W
-117.735675°

PROJECT TEAM

PROJECT MANAGER:
AT&T
1452 EDINGER AVE, 3RD FLOOR
TUSTIN, CA 92780
CONTACT: TY LOGAN-BURKS
PHONE: (925) 549-4671
EMAIL: tl784a@att.com

SITE ACQUISITION:
EUKON
65 POST SUITE 1000
IRVINE, CA 92618
CONTACT: JON SILVA
PHONE: (714) 393-7963
EMAIL: jon.silva@eukongroup.com


A&E CONTACT:
EUKON
65 POST SUITE 1000
IRVINE, CA 92618
CONTACT: RICH BRUNET
PHONE: (949) 553-8566
EMAIL: rich.brunet@eukongroup.com

RF ENGINEER:
AT&T
1452 EDINGER AVE, 3RD FLOOR
TUSTIN, CA 92780
CONTACT: SANDEEP MANGAT
PHONE: (530) 540-4201
EMAIL: sm2840@att.com


ZONING:
EUKON
65 POST SUITE 1000
IRVINE, CA 92618
CONTACT: SONAL THAKUR
PHONE: (949) 565-6501
EMAIL: sonal.thakur@eukongroup.com

CONSTRUCTION:
AT&T
1452 EDINGER AVE, 3RD FLOOR
TUSTIN, CA 92780
CONTACT: DAVID TOVLIN
PHONE: (562) 243-5168
EMAIL: dt2777@att.com

VICINITY MAP

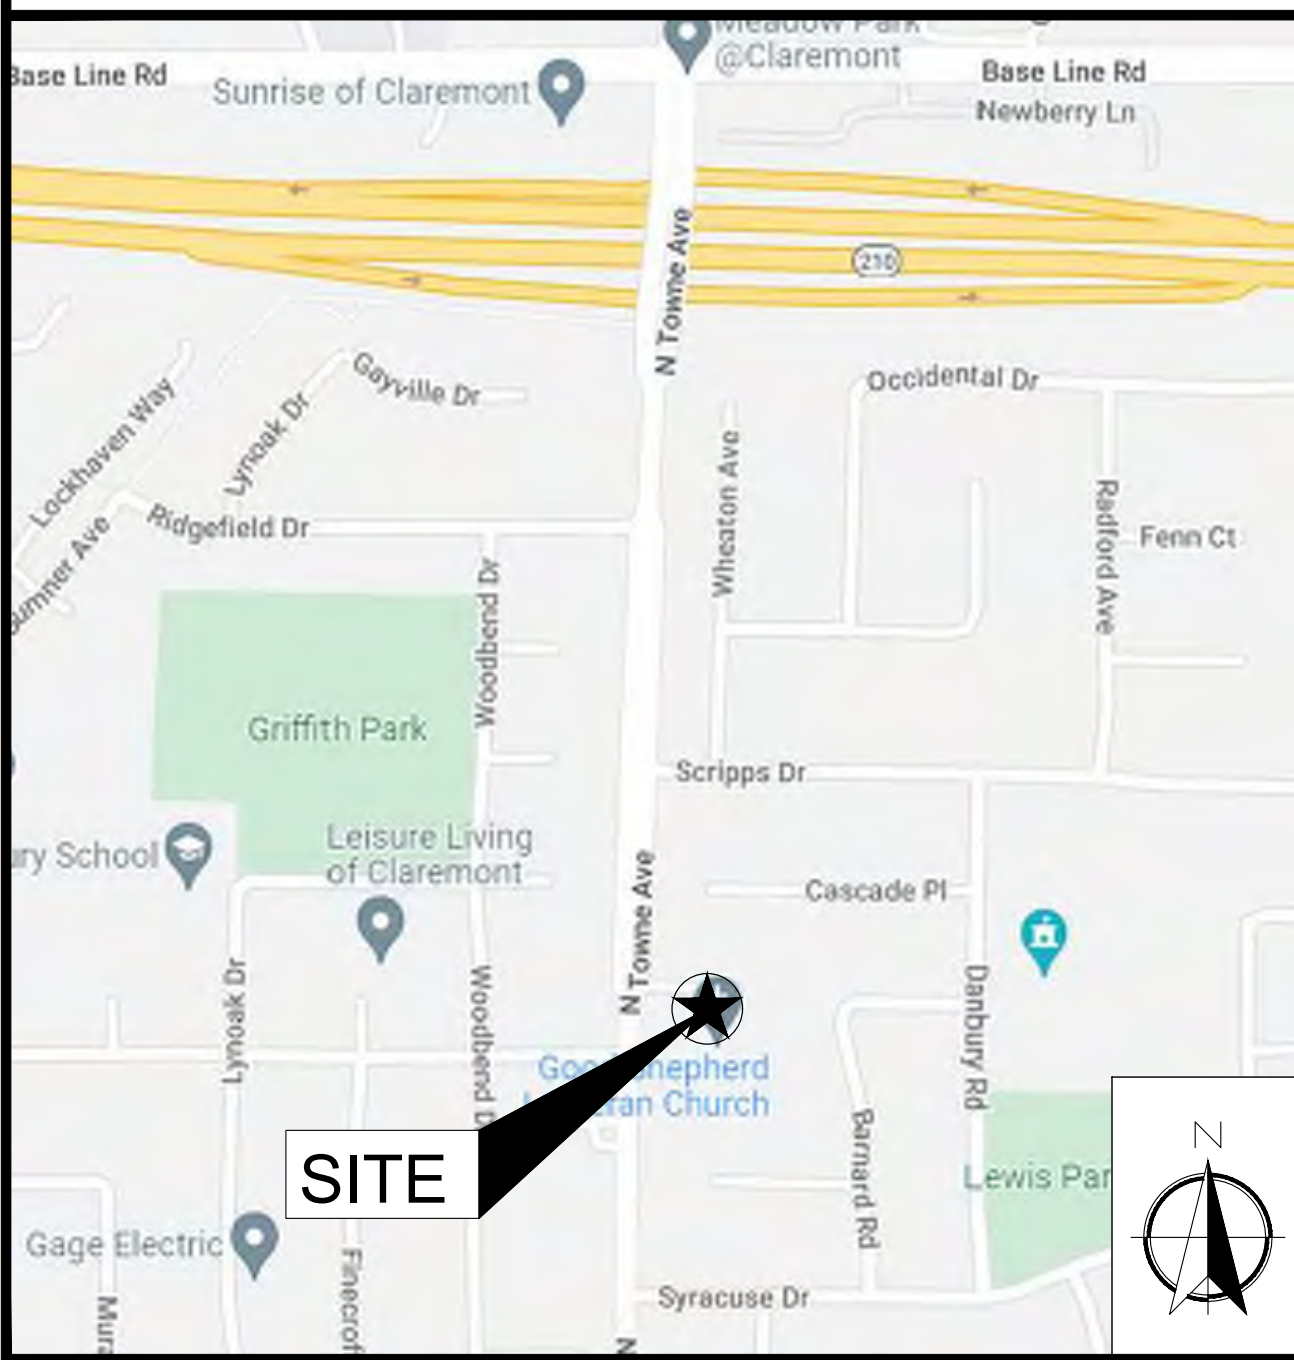

AERIAL VIEW



DRIVING DIRECTIONS

DIRECTIONS FROM AT&T OFFICE AT 1452 EDINGER AVE, TUSTIN, CA 92780

1. DEPART 1452 EDINGER AVE AND HEAD NORTH ON EDINGER AVE. TOWARDS I-5 SOUTH.

2. TURN LEFT ONTO NEWPORT AVE.

3. TURN RIGHT AND MERGE ONTO CA-55 N TOWARD SANTA ANA.

4. TAKE EXIT 107A FOR CA-57 N TOWARD POMONA.

5. TAKE EXIT 25B FOR CA-210 E/FOOTHILL FWY TOWARD SAN BERNARDINO.

6. TAKE EXIT 50 TOWARD TOWNE AVE.

7. USE RIGHT 2 LANES TO TURN RIGHT ONTO N TOWNE AVE.


8. SITE IS ON LEFT HAND SIDE

SITE NUMBER: CLL05463

PACE#: MRLOS094296

FA#: 12844550

USID: 317138

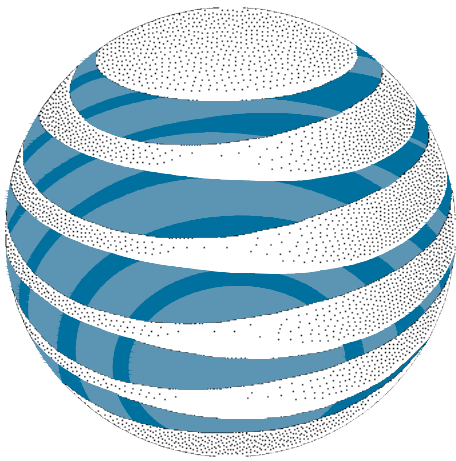

at&t

PROJECT: NEW SITE BUILD (NSB)

LTE-1C/2C/3C/4C/5C/6C/7C

SITE TYPE: FAUX EUCALYPTUS

SITE ADDRESS: 1700 N. TOWNE AVE.

CLAREMONT, CA. 91711

PROJECT DESCRIPTION

AT&T WIRELESS PROPOSES TO INSTALL A WIRELESS COMMUNICATIONS FACILITY. THE SCOPE WILL CONSIST OF THE FOLLOWING:

- INSTALL 62'-0" TALL FAUX EUCALYPTUS
- INSTALL (20) PANEL ANTENNAS
- INSTALL (12) RRUS AT ANTENNAS
- INSTALL (4) DC9 SURGE SUPPRESSORS
- INSTALL (1) 4' WIDE STEEL ACCESS DOOR
- INSTALL (1) PPC
- INSTALL (1) CAMLOCK
- INSTALL (1) POWER CABINET
- INSTALL (2) STACKED PURCELL CABINETS
- INSTALL (1) DC50 SURGE SUPPRESSOR
- INSTALL (1) TELCO BOX
- INSTALL (1) CIENA
- INSTALL (1) JOINT TELCO / POWER UTILITY TRENCH
- INSTALL (1) 200A METER PANEL
- INSTALL (1) 8'-0" HIGH CMU BLOCK WALL ENCLOSURE
- INSTALL (1) CONCRETE PAD
- INSTALL (2) EUCALYPTUS TREES
- INSTALL (44) SHRUBS

SHEET INDEX


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
TOWER DRAWINGS BY SCI

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at&t

1452 EDINGER AVE.
3RD FLOOR
TUSTIN, CA 92780



an SFC Communications, Inc. Company

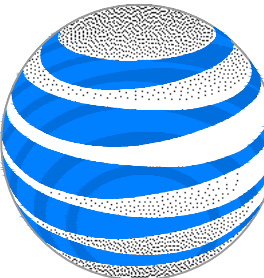65 POST, SUITE 1000
IRVINE, CA 92618
TEL: (949) 553-8566
www.eukongroup.com

NOT FOR CONSTRUCTION

IT IS A VIOLATION OF LAW FOR ANY PERSON, UNLESS THEY ARE ACTING UNDER THE DIRECTION OF THE LICENSED PROFESSIONAL ENGINEER, TO ALTER THIS DOCUMENT.

DRAWN BY: DW/AS

UTILITIES CHECKED BY: GD

A&E CHECKED BY: RB

CONSTRUCTION DRAWINGS

REV	DATE	DESCRIPTION
A	04/26/24	90% CONSTRUCTION DRAWINGS
B	08/29/24	JX COMMENTS
0	03/12/24	100% CONSTRUCTION DRAWINGS

PROJECT INFORMATION

CLL05463

1700 N. TOWNE AVE.
CLAREMONT, CA 91711

SHEET TITLE

TITLE SHEET

SHEET NUMBER

T-1

EUKON AT&T_90CD_MONOPOLE_TEMPLATE_V2_11-18-22

EUKON AT&T 90CD_MONOPOLE TEMPLATE_V2_11-18-22

	PROPERTY LINE / LEASE AREA
	CENTER LINE
	NEW POWER CABLE
	NEW FIBER CABLE
	NEW POWER AND FIBER CABLES
	NEW HYBRID CABLES
	NEW COAX CABLES
	OVERHEAD POWER CABLES
	OVERHEAD COMMUNICATIONS CABLES
	EXISTING POWER CABLES
	EXISTING COMMUNICATION CABLES
	EXISTING WATER PIPES
	EXISTING SEWER PIPES
	EXISTING STORM DRAIN PIPES
	EXISTING GAS PIPES
	EXISTING GASOLINE PIPES
	CHAIN-LINK FENCING

	GROUTED OR PLASTER
	BRICK
	MASONRY
	CONCRETE
	STEEL
	EARTH
	GRAVEL
	PLYWOOD
	SAND
	WOOD CONTINUOUS
	WOOD BLOCKING
	SPOT ELEVATION
	REVISION
	GRID REFERENCE
	DETAIL REFERENCE
	ELEVATION REFERENCE
	SECTION REFERENCE

	ELECTRICAL BOX
	TELEPHONE BOX
	ELECTRICAL METER
	SAFETY SWITCH (DISCONNECT)
	AUTOMATIC TRANSFER SWITCH
	CIRCUIT BREAKER
	ELECTRICAL SWITCH
	SMOKE DETECTOR
	TRANSFORMER
	UTILITY POLE
	POLE MOUNTED XFMR
	PAD MOUNTED XFMR
	GROUND ROD
	GROUND ROD WITH INSPECTION SLEEVE
	GROUND ROD WITH TEST INSPECTION SLEEVE
	EXOTHERMIC GROUND CONNECTION
	COMPRESSION GROUND CONNECTION
	CHEMICAL ELECTROLYTIC GROUNDING
	GROUNDING CONDUCTOR
	GROUND BAR

1. THE FACILITY IS AN UNOCCUPIED DIGITAL TELECOMMUNICATION FACILITY.
2. PLANS ARE NOT TO BE SCALED AND ARE INTENDED TO BE A DIAGRAMMATIC OUTLINE ONLY, UNLESS NOTED OTHERWISE. THE WORK SHALL INCLUDE FURNISHING MATERIALS, EQUIPMENT, APPURTENANCES AND LABOR NECESSARY TO COMPLETE ALL INSTALLATIONS AS INDICATED ON THE DRAWINGS.
3. PRIOR TO THE SUBMISSION OF BIDS, THE CONTRACTORS SHALL VISIT THE JOB SITE AND BE RESPONSIBLE FOR ALL CONTRACT DOCUMENTS, FIELD CONDITIONS AND DIMENSIONS, AND CONFIRMING THAT THE WORK MAY BE ACCOMPLISHED AS SHOWN PRIOR TO PROCEEDING WITH CONSTRUCTION. ANY DISCREPANCIES ARE TO BE BROUGHT TO THE ATTENTION OF THE IMPLEMENTATION ENGINEER AND ENGINEER PRIOR TO PROCEEDING WITH THE WORK.
4. THE CONTRACTOR SHALL OBTAIN, IN WRITING, AUTHORIZATION TO PROCEED BEFORE STARTING WORK ON ANY ITEM NOT CLEARLY DEFINED OR IDENTIFIED BY THE CONTRACT DOCUMENTS.
5. THE CONTRACTOR SHALL INSTALL ALL EQUIPMENT AND MATERIALS IN ACCORDANCE WITH MANUFACTURER'S RECOMMENDATIONS UNLESS SPECIFICALLY INDICATED OTHERWISE OR WHERE LOCAL CODES OR REGULATIONS TAKE PRECEDENCE.
6. ALL WORK PERFORMED AND MATERIALS INSTALLED SHALL BE IN STRICT ACCORDANCE WITH ALL APPLICABLE CODES, REGULATIONS AND ORDINANCES. CONTRACTOR SHALL GIVE ALL NOTICES AND COMPLY WITH ALL LAWS, ORDINANCES, RULES, REGULATIONS AND LAWFUL ORDERS OF ANY PUBLIC AUTHORITY REGARDING THE PERFORMANCE OF THE WORK. MECHANICAL AND ELECTRICAL SYSTEMS SHALL BE INSTALLED IN ACCORDANCE WITH ALL APPLICABLE MUNICIPAL AND UTILITY COMPANY SPECIFICATIONS, AND LOCAL AND STATE JURISDICTIONAL CODES, ORDINANCES AND APPLICABLE REGULATIONS.
7. THE GENERAL CONTRACTOR SHALL SUPERVISE AND DIRECT THE WORK, USING THE BEST SKILLS AND ATTENTION. THE CONTRACTOR SHALL BE SOLELY RESPONSIBLE FOR ALL CONSTRUCTION MEANS, METHODS, TECHNIQUES, SEQUENCES AND PROCEDURES AND FOR COORDINATING ALL PORTIONS OF THE WORK UNDER THE CONTRACT INCLUDING CONTACT AND COORDINATION WITH THE IMPLEMENTATION ENGINEER AND WITH THE LANDLORD'S AUTHORIZED REPRESENTATIVE.
8. SEAL PENETRATIONS THROUGH FIRE RATED AREAS WITH U.L. LISTED AND FIRE CODE APPROVED MATERIALS.
9. PROVIDE A PORTABLE FIRE EXTINGUISHER WITH A RATING OF NOT LESS THAN 2-A OR 2-A10BC WITHIN 75 FEET TRAVEL DISTANCE TO ALL PORTIONS OF THE PROJECT AREA DURING CONSTRUCTION.
10. DETAILS ARE INTENDED TO SHOW END RESULT OF DESIGN. MINOR MODIFICATIONS MAY BE REQUIRED TO SUIT JOB DIMENSIONS OR CONDITIONS, AND SUCH MODIFICATIONS SHALL BE INCLUDED AS PART OF THE WORK.
11. REPRESENTATIONS OF TRUE NORTH, OTHER THAN THOSE FOUND ON THE PLOT OF SURVEY DRAWING (SHEET LS1 OR SHEET C-1), SHALL NOT BE USED TO IDENTIFY OR ESTABLISH THE BEARING OF TRUE NORTH AT THE SITE. THE CONTRACTOR SHALL RELY SOLELY ON THE PLOT OF SURVEY DRAWING AND ANY SURVEYOR'S MARKINGS AT THE SITE FOR THE ESTABLISHMENT OF TRUE NORTH, AND SHALL NOTIFY THE ENGINEER PRIOR TO PROCEEDING WITH THE WORK IF ANY DISCREPANCY IS FOUND BETWEEN THE VARIOUS ELEMENTS OF THE WORKING DRAWINGS AND THE TRUE NORTH ORIENTATION AS DEPICTED ON THE CIVIL SURVEY. THE CONTRACTOR SHALL ASSUME SOLE LIABILITY FOR ANY FAILURE TO NOTIFY THE ENGINEER.
12. THE CONTRACTOR SHALL MAKE NECESSARY PROVISIONS TO PROTECT EXISTING IMPROVEMENTS, PAVING, CURBS, VEGETATION, GALVANIZED SURFACES, ETC., AND UPON COMPLETION OF WORK REPAIR ANY DAMAGE THAT OCCURRED DURING CONSTRUCTION TO THE SATISFACTION OF AT&T.
13. KEEP GENERAL AREA CLEAN, HAZARD FREE, AND DISPOSE OF ALL DIRT, DEBRIS, RUBBISH AND REMOVE EQUIPMENT NOT SPECIFIED AS REMAINING ON THE PROPERTY. LEAVE PREMISES IN CLEAN CONDITION AND FREE FROM PAINT SPOTS, DUST OR SMUDGES OF ANY NATURE.
14. PENETRATIONS OF ROOF MEMBRANES SHALL BE PATCHED/FLASHED AND MADE WATERTIGHT USING LIKE MATERIALS IN ACCORDANCE WITH NRCA ROOFING STANDARDS AND DETAILS. CONTRACTOR SHALL OBTAIN DETAILING CLARIFICATION FOR SITE-SPECIFIC CONDITIONS FROM ENGINEER, IF NECESSARY, BEFORE PROCEEDING.
15. BEFORE ORDERING AND/OR BEFORE FABRICATING/CONSTRUCTING/INSTALLING ANY ITEMS, VERIFY THE TYPES AND QUANTITIES.
16. CONTRACTOR SHALL PROVIDE SITE FOREMAN WITH A CELLULAR PHONE AND PAGER, AND KEEP SAME ON SITE WHENEVER PERSONNEL ARE ON SITE.
17. THE CONTRACTOR SHALL VERIFY ALL DIMENSIONS AND CONDITIONS ON THE SITE AND NOTIFY THE PROJECT MANAGER OF ANY DISCREPANCIES BEFORE STARTING ANY WORK.
18. CONTRACTOR TO PROVIDE COMPLETE SET OF AS BUILT DRAWINGS WITHIN 10 WORKING DAYS OF PROJECT COMPLETION.
19. CONTRACTOR IS TO EXCAVATE 6" BELOW EXISTING GRADE AND SPRAY WITH WEED CONTROL. REPLACE WITH CLASS II AGGREGATE BASE AND CRUSHED WASHED ROCK. AS SPECIFIED ON SITE PLAN.
20. CONTRACTOR SHALL PROVIDE TOILET FACILITY DURING ALL PHASES OF CONSTRUCTION.
21. PRIOR TO THE COMMENCEMENT OF CONSTRUCTION OR THE FABRICATION OF MATERIALS TO BE INSTALLED AT THE SITE, THE CONTRACTOR SHALL FIELD VERIFY ALL DIMENSIONS INCLUDING AS-BUILT DIMENSIONS OF EXISTING STRUCTURES OR STRUCTURAL ELEMENTS HAVING A BEARING ON THE SCOPE OF THE WORK TO BE PERFORMED. IF ANY DISCREPANCY IS FOUND BETWEEN THE VARIOUS ELEMENTS OF THE WORKING DRAWINGS AND THE DIMENSIONS OR CONDITIONS FOUND TO BE EXISTING IN THE FIELD, THE CONTRACTOR SHALL NOTIFY THE ENGINEER AND OBTAIN DESIGN RESOLUTION PRIOR TO PROCEEDING WITH THE PORTION(S) OF THE WORK AFFECTED. THE CONTRACTOR SHALL ASSUME SOLE LIABILITY FOR ANY FAILURE TO SO NOTIFY THE ENGINEER AND OBTAIN RESOLUTION BEFORE PROCEEDING.

NOTES FOR EXISTING AT&T CELL SITES:

1. PRIOR TO THE SUBMISSION OF BIDS, THE BIDDING SUBCONTRACTOR SHALL VISIT THE CELL SITE TO FAMILIARIZE WITH THE EXISTING CONDITIONS AND TO CONFIRM THAT THE WORK CAN BE ACCOMPLISHED AS SHOWN ON THE CONSTRUCTION DRAWINGS. ANY DISCREPANCY FOUND SHALL BE BROUGHT TO THE ATTENTION OF CONTRACTOR.
2. SUBCONTRACTOR SHALL VERIFY ALL EXISTING DIMENSIONS AND CONDITIONS PRIOR TO COMMENCING ANY WORK. ALL DIMENSIONS OF EXISTING CONSTRUCTION SHOWN ON THE DRAWINGS MUST BE VERIFIED. SUBCONTRACTOR SHALL NOTIFY THE CONTRACTOR OF ANY DISCREPANCIES PRIOR TO ORDERING MATERIAL OR PROCEEDING WITH CONSTRUCTION.
3. THE EXISTING CELL SITE IS IN FULL COMMERCIAL OPERATION. ANY CONSTRUCTION WORK BY SUBCONTRACTOR SHALL NOT DISRUPT THE EXISTING NORMAL OPERATION. ANY WORK ON EXISTING EQUIPMENT MUST BE COORDINATED WITH CONTRACTOR. ALSO, WORK SHOULD BE SCHEDULED FOR AN APPROPRIATE MAINTENANCE WINDOW USUALLY IN LOW TRAFFIC PERIODS AFTER MIDNIGHT.
4. SINCE THE CELL SITE IS ACTIVE, ALL SAFETY PRECAUTIONS MUST BE TAKEN WHEN WORKING AROUND HIGH LEVELS OF ELECTROMAGNETIC RADIATION. EQUIPMENT SHOULD BE SHUTDOWN PRIOR TO PERFORMING ANY WORK THAT COULD EXPOSE THE WORKERS TO DANGER. PERSONAL RF EXPOSURE MONITORS ARE ADVISED TO BE WORN TO ALERT OF ANY DANGEROUS EXPOSURE LEVELS.
5. SUBCONTRACTOR SHALL DETERMINE ACTUAL ROUTING OF CONDUIT, POWER AND T1 CABLES, GROUNDING CABLES AS SHOWN ON THE POWER, GROUNDING AND TELCO PLAN DRAWING. SUBCONTRACTOR SHALL UTILIZE EXISTING TRAYS AND/OR SHALL ADD NEW TRAYS AS NECESSARY. SUBCONTRACTOR SHALL CONFIRM THE ACTUAL ROUTING WITH THE CONTRACTOR.
6. SUBCONTRACTOR SHALL LEGALLY AND PROPERLY DISPOSE OF ALL SCRAP MATERIALS SUCH AS COAXIAL CABLES AND OTHER ITEMS REMOVED FROM THE EXISTING FACILITY. ANTENNAS REMOVED SHALL BE RETURNED TO THE OWNER'S DESIGNATED LOCATION.

LEGEND

7

A	AMPERE	(E)	EXISTING	LG.	LENGTH	SIM.	SIMILAR
A&E	ARCHITECTURE AND ENGINEERING	EA.	EACH	LPS	LOW PRESSURE SODIUM	S.N.	SOLID NEUTRAL
A.B.	ANCHOR BOLT	EGR.	EMERGENCY GENERATOR RECEPTACLE	LTE	LONG TERM EVOLUTION	SPEC.	SPECIFICATION(S)
ABV.	ABOVE	EL.	ELEVATION	MAS.	MASONRY	SQ.	SQUARE
AC	ALTERNATE CURRENT/AIR CONDITIONER	ELEC.	ELECTRICAL	MAX.	MAXIMUM	S.S.	STAINLESS STEEL
ACCA	ANTENNA CABLE COVER ASSEMBLY	ELEV.	ELEVATOR	M.B.	MACHINE BOLT	STD.	STANDARD
ADD'L	ADDITIONAL	EMT.	ELECTRICAL METALLIC TUBING	MECH.	MECHANICAL	STL.	STEEL
A.F.F.	ABOVE FINISHED FLOOR	E.N.	EDGE NAIL	MFR.	MANUFACTURER	STRUC.	STRUCTURAL
A.F.G.	ABOVE FINISHED GRADE	ENCL.	ENCLOSURE	MIN.	MINIMUM	SURF.	SURFACE
AIC	AMPERE INTERRUPTING CAPACITY	ENG.	ENGINEER	MISC.	MISCELLANEOUS	SW	SWITCH
ALUM.	ALUMINUM	EQ.	EQUAL	MLO	MAIN LUGS ONLY	TEL.	TELEPHONE
ALT.	ALTERNATE	ESR	EVALUATION SERVICE REPORT	MTD.	MOUNTED	TEMP.	TEMPORARY
ANT.	ANTENNA	EXP.	EXPANSION	MTG.	MOUNTING	THK.	THICK(NESS)
APPROX.	APPROXIMATE(LY)	EXT.	EXTERIOR	MTL.	METAL	TMA	TOWER MOUNTED AMPLIFIER (DC SUPPLY VOLTAGE)
ARCH.	ARCHITECT(URAL)	FAB.	FABRICATION(OR)	MTS.	MANUAL TRANSFER SWITCH	T.N.	TOE NAIL
AT.	AMPERE TRIP	FAC.	FACTOR	N	NEUTRAL	T.O.A.	TOP OF ANTENNA
AWG.	AMERICAN WIRE GAUGE	F/A	FIRE ALARM	(N)	NEW	T.O.C.	TOP OF CURB
BATT.	BATTERY	F.F.	FINISH FLOOR	NEMA	NATIONAL ELECTRICAL MANUFACTURERS ASSOC.	T.O.F.	TOP OF FOUNDATION
BD.	BOARD	F.G.	FINISH GRADE	NO.(#)	NUMBER	T.O.P.	TOP OF PLATE OR PARAPET
BLDG.	BUILDING	F.J.	FLOOR JOIST	N.T.S.	NOT TO SCALE	T.O.R.	TOP OF ROOF
BLK.	BLOCK	FIN.	FINISH(ED)	OBIF	OPTICAL BASEBAND INTERFACE	T.O.S.	TOP OF STEEL
BLKG.	BLOCKING	FLR.	FLOOR	OH	OVERHEAD	T.O.W.	TOP OF WALL
BM.	BEAM	FLUOR	FLUORESCENT	O.C.	ON CENTER	TYP.	TYPICAL
B.N.	BOUNDARY NAILING	FDN.	FOUNDATION	OPNG.	OPENING	U.G.	UNDER GROUND
BR.	BRANCH	F.O.C.	FACE OF CONCRETE	(P)	PROPOSED	U.L.	UNDERWRITERS LABORATORY INC.
BRKR.	BREAKER	F.O.M.	FACE OF MASONRY	P	POLE	UMTS	UNIVERSAL MOBIL TECH. SYS.
BTQW.	BARE TINNED COPPER WIRE	F.O.S.	FACE OF STUD	P/C	PRECAST CONCRETE	U.N.O.	UNLESS NOTED OTHERWISE
BTS.	BASE TRANSMISSION SYSTEM	F.O.W.	FACE OF WALL	PCS	PERSONAL COMMUNICATION SERVICES	V	VOLT
B.O.F.	BOTTOM OF FOOTING	FRP	FIBER REINFORCE POLYMER	PH	PHASE	VAC	VOLT ALTERNATING CURRENT
B/U	BACK-UP CABINET	F.S.	FINISH SURFACE	PLY.	PLYWOOD	V.I.F.	VERIFY IN FIELD
C	CONDUIT	FT.(')	FOOT (FEET)	PNLBD	PANELBOARD	W	WATT OR WIRE
CAB.	CABINET	FTG.	FOOTING	PPC	POWER PROTECTION CABINET	WD	WIDE(WIDTH)
CANT.	CANTILEVER(ED)	FU	FUSE	PRC	PRIMARY RADIO CABINET	W/	WITH
CB.	CIRCUIT BREAKER	G	GROUND	L.	PROPERTY OR PROPERTY LINE	W/O	WITHOUT
CDMA	CODE-DIVISION MULTIPLE ACCESS	GR	GROWTH (CABINET)	PRI	PRIMARY	WD.	WOOD
CDUK	CONSOLIDATION DISTRIBUTION UNIT KIT	GA.	GAUGE	P.S.F.	POUNDS PER SQUARE FOOT	W.P.	WEATHERPROOF
C.I.P.	CAST IN PLACE	GALV.	GALVANIZE(D)	P.S.I.	POUNDS PER SQUARE INCH	WT.	WEIGHT
CKT.	CIRCUIT	GEN.	GENERATOR	P.T.	PRESSURE TREATED	XFER	TRANSFER
CL.	CENTERLINE	G.F.C.I.	GROUND FAULT CIRCUIT INTERRUPTER	P.T.D.F.	PRESSURE TREATED DOUGLAS FUR	XFMR	TRANSFORMER
CLG.	CEILING	GLB.	(GLU-LAM) GLUE LAMINATED BEAM	PWR.	POWER	XLPE	CROSS-LINK POLYETHYLENE
CLR.	CLEAR	GND	GROUND	QTY.	QUANTITY		
CMU	CONCRETE MASONRY UNIT	GPS	GLOBAL POSITIONING SYSTEM	RAD.	RADIATION		
COL.	COLUMN	GROUND	GROUND	R	RADIUS		
CONC.	CONCRETE	GSM	GLOBAL SYSTEM MOBILE	RBS	RADIO BASE STATION		
CONN.	CONNECTION(OR)	HDBC	HARD DRAWN COPPER WIRE	RCPT.	RECEPTACLE		
CONST.	CONSTRUCTION	HDR.	HEADER	REF.	REFERENCE		
CONT.	CONTINUOUS	HGR.	HANGER	REINF.	REINFORCEMENT(ING)		
d	PENNY (NAILS)	HPS	HIGH PRESSURE SODIUM	REQD.	REQUIRED		
DBL.	DOUBLE	HT.	HEIGHT	RF	RADIO FREQUENCY		
DC	DIRECT CURRENT	ICC	INTERNATIONAL CODE COUNCIL	RGS.	RIGID GALVANIZED STEEL		
DEM.	DEMAND	ICGB.	ISOLATED COPPER GROUND BUS	R.J.	ROOF JOIST		
DEPT.	DEPARTMENT	ILC	INTEGRATED LEAD CENTER	R.R.	ROOF RAFTER		
D.F.	DOUGLAS FIR	IN.(")	INCH(ES)	RRU	REMOTE RADIO UNIT (RADIO TRANSCEIVER)		
DIA.	DIAMETER	INT.	INTERIOR	RX-AIT	RECEIVER AIR INTERFACE TRAY		
DIAG.	DIAGONAL	L.	LONG(ITUDINAL)	SAF	SAFETY		
DIM.	DIMENSION	LARR	LOS ANGELES RESEARCH REPORT	SAQ	SITE ACQUISITION		
DO	DITO (THE SAME)	LB.(#)	POUND(S)	SCH.	SCHEDULE		
DWG.	DRAWING(S)	LAG BOLTS	LAG BOLTS	SDBC	SOFT DRAWN BARE COPPER SEC SECONDARY		
DWL.	DOWEL(S)	L.F.	LINEAR FEET (FOOT)	SHT.	SHEET		

ABBREVIATIONS

5

GENERAL NOTES

1



1452 EDINGER AVE.
3RD FLOOR
TUSTIN, CA 92780



65 POST, SUITE 1000
IRVINE, CA 92618
TEL: (949) 553-8566
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CONSTRUCTION

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OF THE LICENSED PROFESSIONAL ENGINEER,
TO ALTER THIS DOCUMENT.

DRAWN BY:	UTILITIES CHECKED BY:	A&E CHECKED BY:
DW/AS	GD	RB

CONSTRUCTION
DRAWINGS

SUBMITTALS		
REV	DATE	DESCRIPTION
A	04/26/24	90% CONSTRUCTION DRAWINGS
B	08/29/24	JX COMMENTS
0	03/12/24	100% CONSTRUCTION DRAWINGS

PROJECT INFORMATION




CLL05463

1700 N. TOWNE AVE.
CLAREMONT, CA 91711

SHEET TITLE
GENERAL NOTES,
LEGEND, AND
ABBREVIATIONS

SHEET NUMBER


T-2

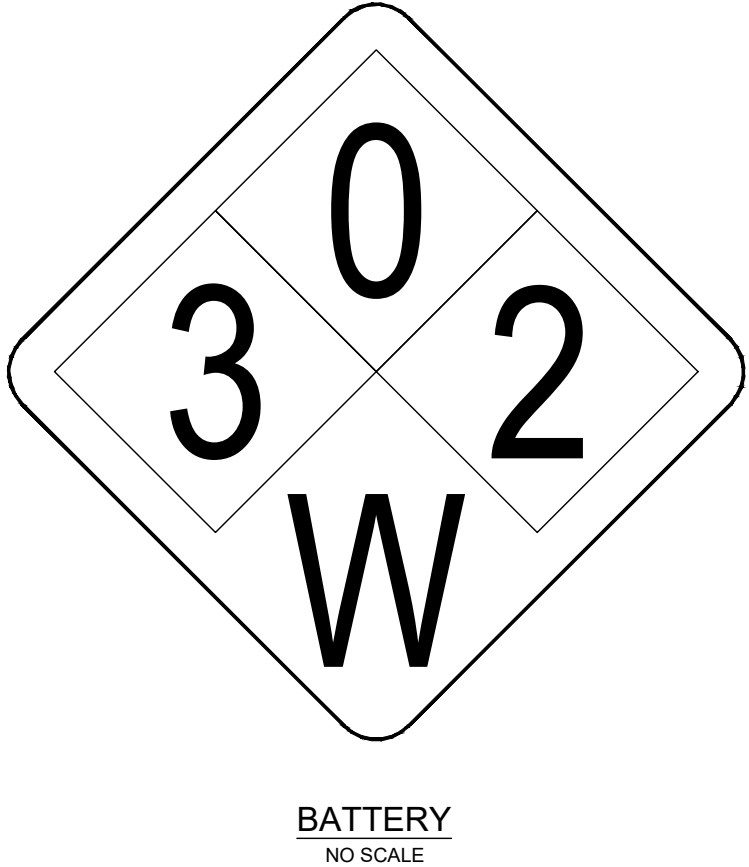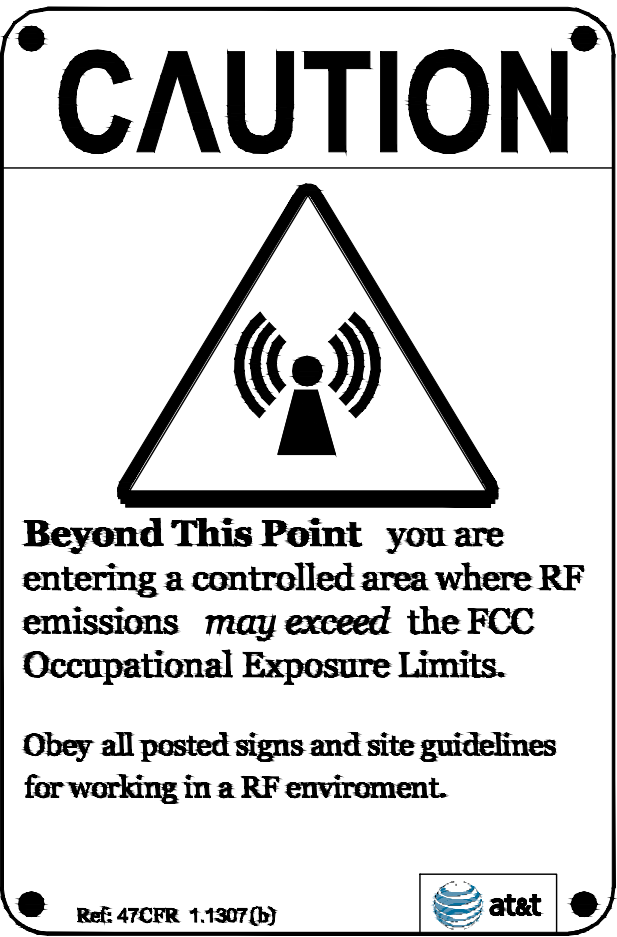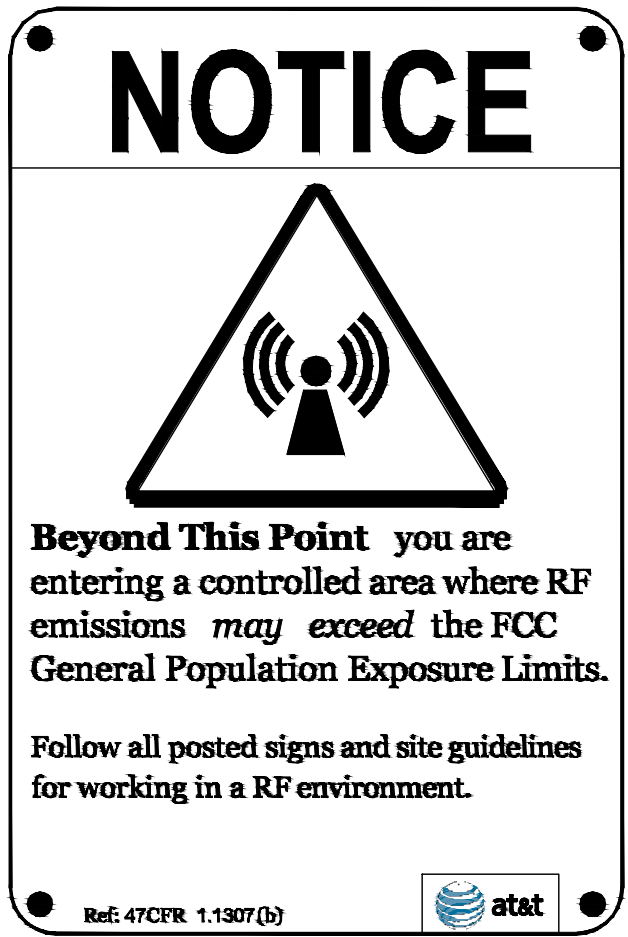

CAUTION SIGNS
NO SCALE




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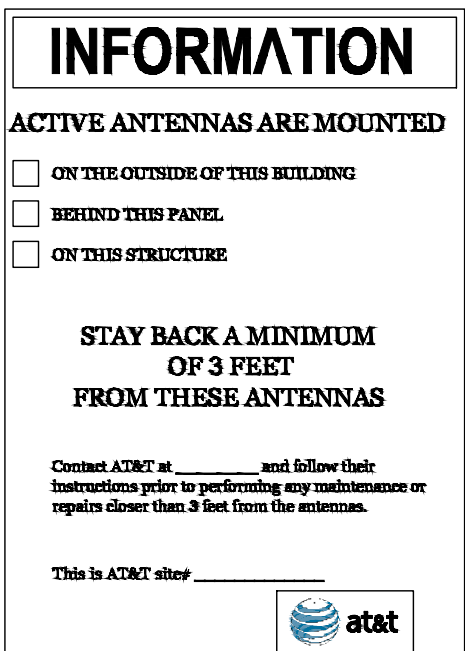
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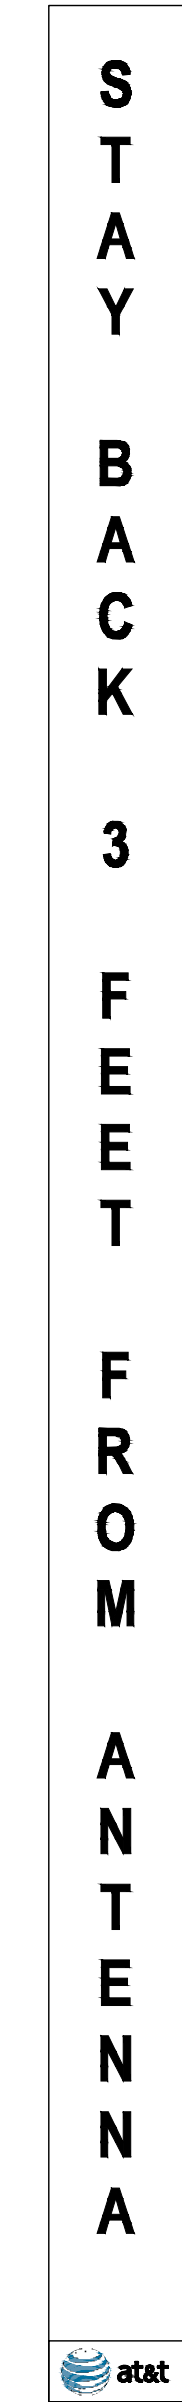
INFO SIGN #3
NO SCALE

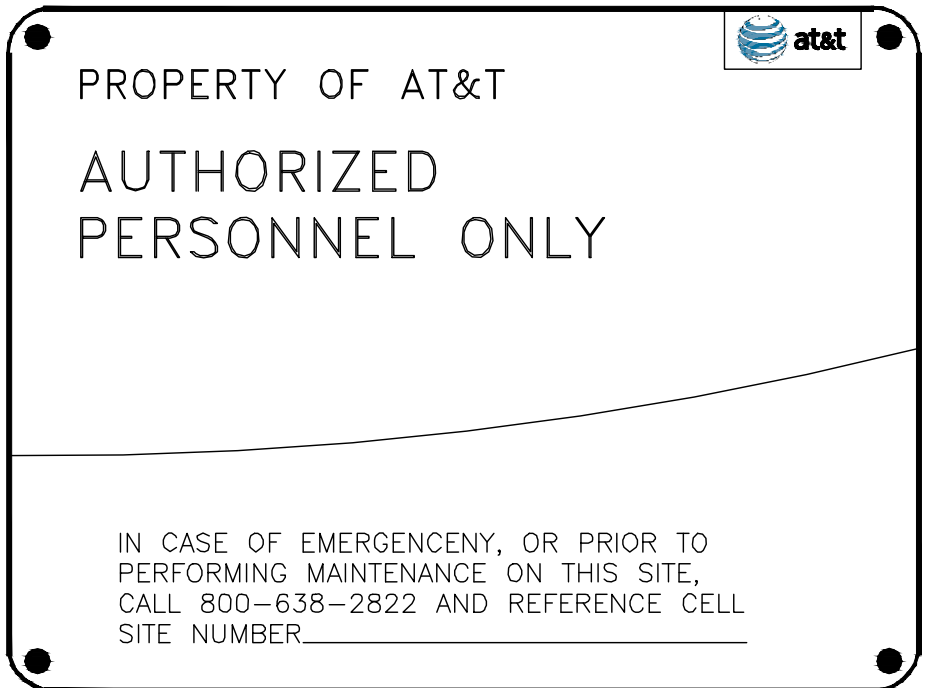

INFO SIGN #1
NO SCALE



INFO SIGN #2
NO SCALE

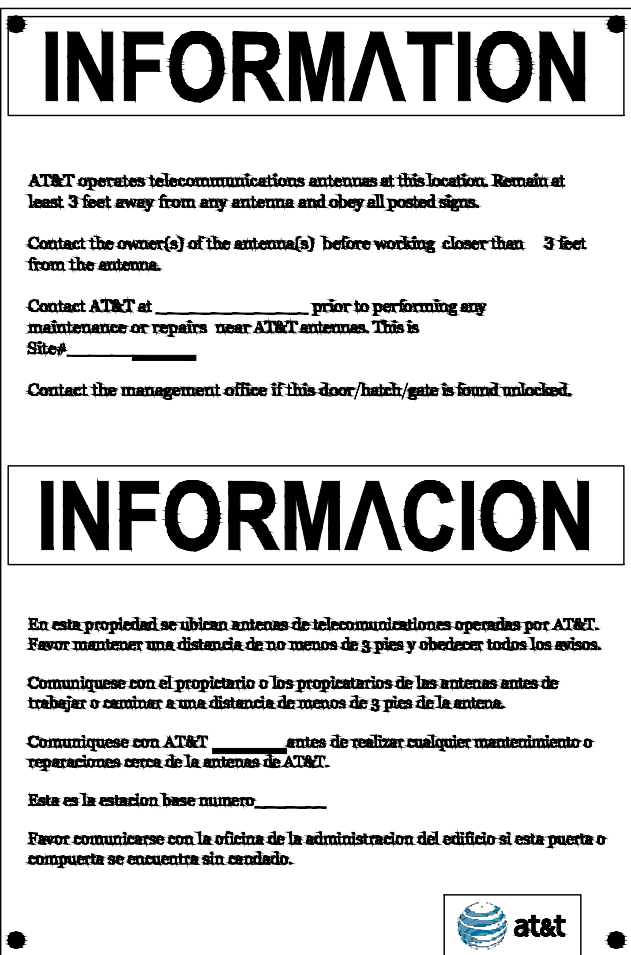

INFO SIGN #4
NO SCALE

GENERAL SIGNAGE GUIDELINES								
STRUCTURE TYPE	INFO SIGN #1	INFO SIGN #2	INFO SIGN #3	INFO SIGN #4	INFO SIGN #5	STRIPING	NOTICE SIGN	CAUTION SIGN
TOWERS								
MONOPOLE / MONOPINE / MONOPALM / FAUX EUCALYPTUS / BROADLEAF	ENTRANCE GATES, SHELTER DOORS OR ON THE OUTDOOR CABINETS	ON THE POLE, NO LESS THAN 3FT BELOW THE ANTENNA AND NO	ON BACKSIDE OF ANTENNAS	ON THE SIDE OF ANTENNAS	ON THE SHELTER DOOR OR ON ONE OUTDOOR EQUIPMENT CABINET	--	--	AT THE HEIGHT OF THE FIRST CLIMBING STEP, MIN. 9FT ABOVE GROUND
SCE TOWERS / TOWERS WITH HIGH VOLTAGE	ENTRANCE GATES, SHELTER DOORS OR ON THE OUTDOOR CABINETS	ON THE POLE, NO LESS THAN 3FT BELOW THE ANTENNA AND NO	ON BACKSIDE OF ANTENNAS	ON THE SIDE OF ANTENNAS	ON THE SHELTER DOOR OR ON ONE OUTDOOR EQUIPMENT CABINET	--	--	AT THE HEIGHT OF THE FIRST CLIMBING STEP, MIN. 9FT ABOVE GROUND
LIGHT POLES / FLAG POLES	ENTRANCE GATES, SHELTER DOORS OR ON THE OUTDOOR CABINETS	ON THE POLE, NO LESS THAN 3FT BELOW THE ANTENNA AND NO	ON BACKSIDE OF ANTENNAS	ON THE SIDE OF ANTENNAS	ON THE SHELTER DOOR OR ON ONE OUTDOOR EQUIPMENT CABINET	--	--	--
UTILITY WOOD POLES (JPA)	ENTRANCE GATES, SHELTER DOORS OR ON THE OUTDOOR CABINETS	ON THE POLE, NO LESS THAN 3FT BELOW THE ANTENNA AND NO	ON BACKSIDE OF ANTENNAS	ON THE SIDE OF ANTENNAS	ON THE SHELTER DOOR OR ON ONE OUTDOOR EQUIPMENT CABINET	--	IF GP MAX VALUE OF MPE AT ANTENNA LEVEL IS: 0-99%: NOTICE SIGN; OVER 99%: CAUTION SIGN AT NO LESS THAN 3FT BELOW ANTENNA AND 9FT ABOVE GROUND	
MICROCELLS MOUNTED ON NON-JPA POLES	ENTRANCE GATES, SHELTER DOORS OR ON THE OUTDOOR CABINETS	ON THE POLE, NO LESS THAN 3FT BELOW THE ANTENNA AND NO	ON BACKSIDE OF ANTENNAS	ON THE SIDE OF ANTENNAS	ON THE SHELTER DOOR OR ON ONE OUTDOOR EQUIPMENT CABINET		NOTICE OR CAUTION SIGN AT NO LESS THAN 9FT ABOVE GROUND; ONLY IF THE EXPOSURE EXCEEDS 90% OF THE GENERAL PUBLIC EXPOSURE AT 6FT ABOVE GROUND	
ROOFTOPS								
AT ALL ACCESS POINTS TO THE ROOF	X							
ON ANTENNAS	X		X	X				
CONCEALED ANTENNAS	X	X						
ANTENNAS MOUNTED FACING OUTSIDE THE BUILDING	X	X						
ANTENNAS ON SUPPORT STRUCTURE	X	X						
ROOF VIEW GRAPH:								
RADIATION AREA IS WITHIN 3FT FROM ANTENNA	X	ADJACENT TO EACH ANTENNA				DIAGONAL, YELLOW STRIPING AS TO ROOF VIEW GRAPH	EITHER NOTICE OR CAUTION SIGN (BASED ON ROOFVIEW RESULTS) AT ANTENNAS/BARRIER	
RADIATION AREA IS BEYOND 3FT FROM ANTENNA	X	ADJACENT TO EACH ANTENNA						
CHURCH STEEPLES	ACCESS TO STEEPLE	ADJACENT TO ANTENNAS IF ANTENNAS ARE CONCEALED	ON BACKSIDE OF ANTENNAS	ON THE SIDE OF ANTENNAS	ON THE SHELTER DOOR OR ON ONE OUTDOOR EQUIPMENT CABINET	--	--	Caution sign at the antennas
WATER TOWERS	ACCESS TO LADDER	ADJACENT TO ANTENNAS IF ANTENNAS ARE CONCEALED	ON BACKSIDE OF ANTENNAS	ON THE SIDE OF ANTENNAS	ON THE SHELTER DOOR OR ON ONE OUTDOOR EQUIPMENT CABINET	--	--	Caution sign beside info sign #1, min. 9ft above ground
NOTES FOR ROOFTOP SITES:								
1. EITHER NOTICE OR CAUTION SIGNS NEED TO BE POSTED AT EACH SECTOR AS CLOSE AS POSSIBLE TO: THE OUTER EDGE OF THE STRIPED OFF AREA OF THE OUTER ANTENNAS OF THE SECTOR.								
2. IF ROOFVIEW SHOWS: ONLY BLUE = NOTICE SIGN, BLUE AND YELLOW = CAUTION SIGN, ONLY YELLOW = CAUTION SIGN TO BE INSTALLED.								
3. SHOULD THE REQUIRED STRIPING AREA INTERFERE WITH ANY STRUCTURES OR EQUIPMENT (A/C, VENTS, ROOF HATCH, DOORS, OTHER ANTENNAS, DISHES, ETC.).								
PLEASE NOTIFY AT&T TO MODIFY THE STRIPING AREA, PRIOR TO STARTING THE WORK.								

SIGNAGE GUIDELINES CHART



1452 EDINGER AVE.
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DRAWN BY:	UTILITIES CHECKED BY:	A&E CHECKED BY:
DW/AS	GD	RB

CONSTRUCTION DRAWINGS

SUBMITTALS		
REV	DATE	DESCRIPTION
A	04/26/24	90% CONSTRUCTION DRAWINGS
B	08/29/24	JX COMMENTS
0	03/12/24	100% CONSTRUCTION DRAWINGS

PROJECT INFORMATION

CLL05463

1700 N. TOWNE AVE.
CLAREMONT, CA 91711

SHEET TITLE

GENERAL SIGNAGE

SHEET NUMBER

T-3



1452 EDINGER AVE.
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TO ALTER THIS DOCUMENT.

DRAWN BY:	UTILITIES CHECKED BY:	A&E CHECKED BY:
-----------	--------------------------	--------------------

DW/AS	GD	RB
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CONSTRUCTION DRAWINGS

SUBMITTALS

[illegible]

PROJECT INFORMATION

CLL05463

1700 N. TOWNE AVE.
CLAREMONT, CA 91711

SHEET TITLE
STATEMENT OF
SPECIAL
INSPECTIONS

SHEET NUMBER

T-4

STATEMENT OF SPECIAL INSPECTIONS

NO.	DESCRIPTION OF TYPE OF INSPECTION REQUIRED, LOCATION, REMARKS.	DESIGN STRENGTH	FREQUENCY
1	ANCHORS:		
	ADHESIVE AND EXPANSION ANCHORS IN CONCRETE OR MASONRY, HILTI KWIK BOLT TZ2 EXPANSION ANCHOR, PER ICC REPORT ESR-4266.		PERIODIC
	ADHESIVE AND EXPANSION ANCHORS IN CONCRETE OR MASONRY. INSPECTOR SHALL VERIFY ANCHOR TYPE, ANCHOR DIMENSIONS,		
	CONCRETE TYPE, THICKNESS AND COMPRESSIVE STRENGTH, HOLED DIMENSTIONS, HOLE CLEANING PROCEDURES, ANCHOR SPACING,		
	EDGE DISTANCES, ANCHOR EMBEDMENT, AND TIGHTENING TORQUE.		
2	CONCRETE:		
A	CONTINUOUS INSPECTION AND TEST CYLINDERS FOR STRUCTURAL CONCRETE EXCEPT FOUNDATION CONCRETE OF 2500 PSI OR LESS		CONTINUOUS
	AND SPECIFIED EXCEPTIONS PER SECTION 1705.3 (TABLE 1705.3).		
B	CONTINUOUS SPECIAL INSPECTION OF DRILLING OPERATION FOR PIER FOUNDATIONS.		
C	CONTINUOUS SPECIAL INSPECTION TO VERIFY LOCATION, PLUMBNESS, DIAMETER, AND LENGTH OF PIER FOUNDATIONS.		
D	CONTINUOUS SPECIAL INSPECTION OF ANCHOR BOLTS PRIOR TO AND DURING CONCRETE PLACEMENT.		
E	CONTINUOUS SPECIAL INSPECTION OF CONCRETE PLACEMENT.		
F	CONTINUOUS SPECIAL INSPECTION OF DRILLING OPERATION FOR PIER FOUNDATIONS.		
3	REINFORCING STEEL:		
A	PLACING OF REINFORCING PER SECTION 1705.3 (TABLE 1705.3).		
B	PERIODIC SPECIAL INSPECTION OF PLACEMENT OF REINFORCEMENT STEEL		PERIODIC
4	HIGH STRENGTH BOLTING:		
A	PERIODIC SPECIAL INSPECTION OF HIGH-STRENGTH BOLTING		PERIODIC
5	MASONRY:		
A	LEVEL 1 SPECIAL INSPECTION IS REQUIRED FOR MASONRY IN ACCORDANCE WITH CODE SECTION 1705.4.		PERIODIC
6	WELDING:		
	NO FIELD WELDING SHALL BE PERMITTED. STEEL FABRICATION SHALL BE DONE ON THE PREMISES OF A FABRICATOR REGISTERED		N/A
	AND APPROVED TO PERFORM SUCH WORK WITHOUT SPECIAL INSPECTION.		

SPECIAL INSPECTION NOTES:

1. THE SPECIAL INSPECTIONS IDENTIFIED ON PLANS ARE, IN ADDITION TO, AND NOT A SUBSTITUTE FOR, THOSE INSPECTIONS REQUIRED TO BE PERFORMED BY A CITY'S BUILDING INSPECTOR.
2. CONTINUOUS INSPECTION IS ALWAYS REQUIRED DURING THE PERFORMANCE OF THE WORK UNLESS OTHERWISE SPECIFIED. WHEN WORK IN MORE THAN ONE CATEGORY OF WORK REQUIRING SPECIAL INSPECTION IS TO BE PERFORMED SIMULTANEOUSLY, OR THE GEOTECHNICAL WORK IS SUCH THAT IT CAN BE OBSERVED CONTINUOUSLY OBSERVED IN ACCORDANCE WITH THE PROVISIONS OF CBC SECTION 1704, IT IS THE AGENT'S RESPONSIBILITY TO EMPLOY A SUFFICIENT NUMBER OF INSPECTORS TO ASSURE THAT ALL THE WORK IS INSPECTED IN ACCORDANCE WITH THOSE PROVISIONS.
3. THE SPECIAL INSPECTORS MUST BE CERTIFIED BY THE AUTHORITY HAVING JURISDICTION, IN THE CATEGORY OF WORK REQUIRED TO HAVE SPECIAL INSPECTION.
4. IT IS THE RESPONSIBILITY OF THE CONTRACTOR TO NOTIFY THE SPECIAL INSPECTOR OR INSPECTION AGENCY AT LEAST ONE WORKING DAY PRIOR TO PERFORMING ANY WORK THAT REQUIRES SPECIAL INSPECTION.
5. NOTICE TO THE CONTRACTOR: BY USING THIS PERMITTED CONSTRUCTION DRAWINGS FOR CONSTRUCTION/INSTALLATION OF THE WORK SPECIFIED HEREIN, YOU AGREE TO COMPLY WITH THE REQUIREMENTS OF THE AUTHORITY HAVING JURISDICTION FOR SPECIAL INSPECTIONS, STRUCTURAL OBSERVATIONS, CONSTRUCTION MATERIAL TESTING AND OFF-SITE FABRICATION OF BUILDING COMPONENTS, CONTAINED IN THE STATEMENT OF SPECIAL INSPECTIONS AND, AS REQUIRED BY THE CALIFORNIA CONSTRUCTION CODES.
6. NOTICE TO THE CONTRACTOR/BUILDER/INSTALLER/SUB-CONTRACTOR/ OWNER-BUILDER: BY USING THIS PERMITTED CONSTRUCTION DRAWINGS FOR CONSTRUCTION/INSTALLATION OF THE WORK SPECIFIED HEREIN, YOU ACKNOWLEDGE AND ARE AWARE OF, THE REQUIREMENTS CONTAINED IN THE STATEMENT OF SPECIAL INSPECTIONS. YOU AGREE TO COMPLY WITH THE REQUIREMENTS OF THE AUTHORITY HAVING JURISDICTION FOR SPECIAL INSPECTIONS, STRUCTURAL OBSERVATIONS, CONSTRUCTION MATERIAL TESTING AND OFF-SITE FABRICATION OF BUILDING COMPONENTS, CONTAINED IN THE STATEMENT OF SPECIAL INSPECTIONS AND, AS REQUIRED BY THE CALIFORNIA CONSTRUCTION CODES.
7. THE CONSTRUCTION MATERIALS TESTING LABORATORY MUST BE APPROVED BY THE AUTHORITY HAVING JURISDICTION, FOR TESTING OF MATERIALS, SYSTEMS, COMPONENTS AND, EQUIPMENTS.
8. WORK REQUIRING SPECIAL INSPECTION THAT IS INSTALLED OR COVERED WITHOUT THE APPROVAL OF THE CITY INSPECTOR IS SUBJECT TO REMOVAL OR EXPOSURE AT NO COST TO THE GOVERNING JURISDICTION.



APN
8303-010-043

SITE ADDRESS
1700 N. TOWNE AVE., CLAREMONT, CA 91711

TITLE REPORT

TITLE REPORT WAS PREPARED BY COMMONWEALTH LAND TITLE INSURANCE COMPANY WITH ORDER NUMBER 92017324-920-CMM-CM8 AND GUARANTEE NUMBER CA-SFXFC-IMP-81G28-1-22-92017324 DATED FEBRUARY 23, 2022.

BASIS OF BEARING
BEARINGS SHOWN HEREON ARE BASED UPON U.S. STATE PLANE NAD83 COORDINATE SYSTEM CALIFORNIA STATE PLANE COORDINATE ZONE FIVE DETERMINED BY GPS OBSERVATIONS.

BENCHMARK
ELEVATIONS ARE BASED ON CRTN (CSRC) NETWORK BROADCAST COORDINATES.

FLOODZONE
SITE IS LOCATED IN FLOOD ZONE "X" AS PER F.I.R.M. MAP NO. 06037C1750F EFFECTIVE DATE 09/26/2008.

- NOTES:
- THIS IS NOT A BOUNDARY SURVEY. THIS IS A SPECIALIZED TOPOGRAPHIC MAP. THE PROPERTY LINES AND EASEMENTS SHOWN HEREON ARE FROM RECORD INFORMATION AS NOTED HEREON. CELLSITE CONCEPTS TRANSLATED THE TOPOGRAPHIC SURVEY TO RECORD INFORMATION USING FOUND MONUMENTS SHOWN HEREON. THE LOCATION OF PROPERTY LINES SHOWN HEREON ARE APPROXIMATE AND FOR INFORMATIONAL PURPOSES ONLY. THEY ARE NOT TO BE RELIED UPON AS THE ACTUAL BOUNDARY LINES.
 - ANY CHANGES MADE TO THE INFORMATION ON THIS PLAN, WITHOUT THE WRITTEN CONSENT OF CELLSITE CONCEPTS, RELIEVES CELLSITE CONCEPTS OF ANY AND ALL LIABILITY.
 - THE HEIGHTS AND ELEVATIONS FOR THE TREES, BUSHES AND OTHER LIVING PLANTS SHOWN HEREON, SHOULD BE CONSIDERED APPROXIMATE (+/-) AND ONLY FOR THE DATE OF THIS SURVEY. THEY ARE PROVIDED AS A GENERAL REFERENCE AND SHOULD NOT BE USED FOR DESIGN PURPOSES.
 - WRITTEN DIMENSIONS SHALL TAKE PREFERENCE OVER SCALED & SHALL BE VERIFIED ON THE JOB SITE. ANY DISCREPANCY SHALL BE BROUGHT TO THE NOTICE OF THE SURVEYOR PRIOR TO COMMENCEMENT OF ANY WORK.
 - FIELD SURVEY COMPLETED ON FEBRUARY 23, 2022.

LEGAL DESCRIPTION
ALL THAT CERTAIN REAL PROPERTY SITUATED IN THE CITY OF CLAREMONT, COUNTY OF LOS ANGELES, STATE OF CALIFORNIA, DESCRIBED AS FOLLOWS:

PARCEL 2 OF PARCEL MAP NO. 14693, IN THE CITY OF CLAREMONT, COUNTY OF LOS ANGELES, STATE OF CALIFORNIA, AS PER PLAT RECORDED IN BOOK 151, PAGES 19 AND 20 OF PARCEL MAPS, IN THE OFFICE OF THE COUNTY RECORDER OF SAID COUNTY.

APN: 8303-010-043

SCHEDULE B (EXCEPTIONS)


ITEMS A & B ARE TAX RELATED
ITEMS C & D ARE LIENS RELATED
ITEM 1 & 7 ARE RIGHTS RELATED
ITEM 5 IS DEEDS RELATED
ITEM 6 IS ADVISORY RELATED

EASEMENTS:

ITEM 2, & 3 ARE NOT PLOTTED. THE EXACT LOCATION AND EXTENT OF SAID EASEMENT ARE NOT DISCLOSED OF RECORD.

4. EASEMENT(S) FOR THE PURPOSE(S) SHOWN BELOW AND RIGHTS INCIDENTAL THERETO AS SET FORTH IN A DOCUMENT:
PURPOSE: PUBLIC UTILITIES
RECORDING DATE: MAY 20, 1966
RECORDING NO: 4247 OF OFFICIAL RECORDS
AFFECTS: A PORTION OF SAID LAND

PROPERTY LINES DERIVED FROM
PARCEL MAP NO. 14693 BK. 151 PG. 19-20 DATED APRIL 09, 1982
TRACT NO. 26169 BK. 664 PG. 43-44 DATED DECEMBER 07, 1960
TRACT NO. 22450 BK. 720 PG. 97-99 DATED APRIL 28, 1964

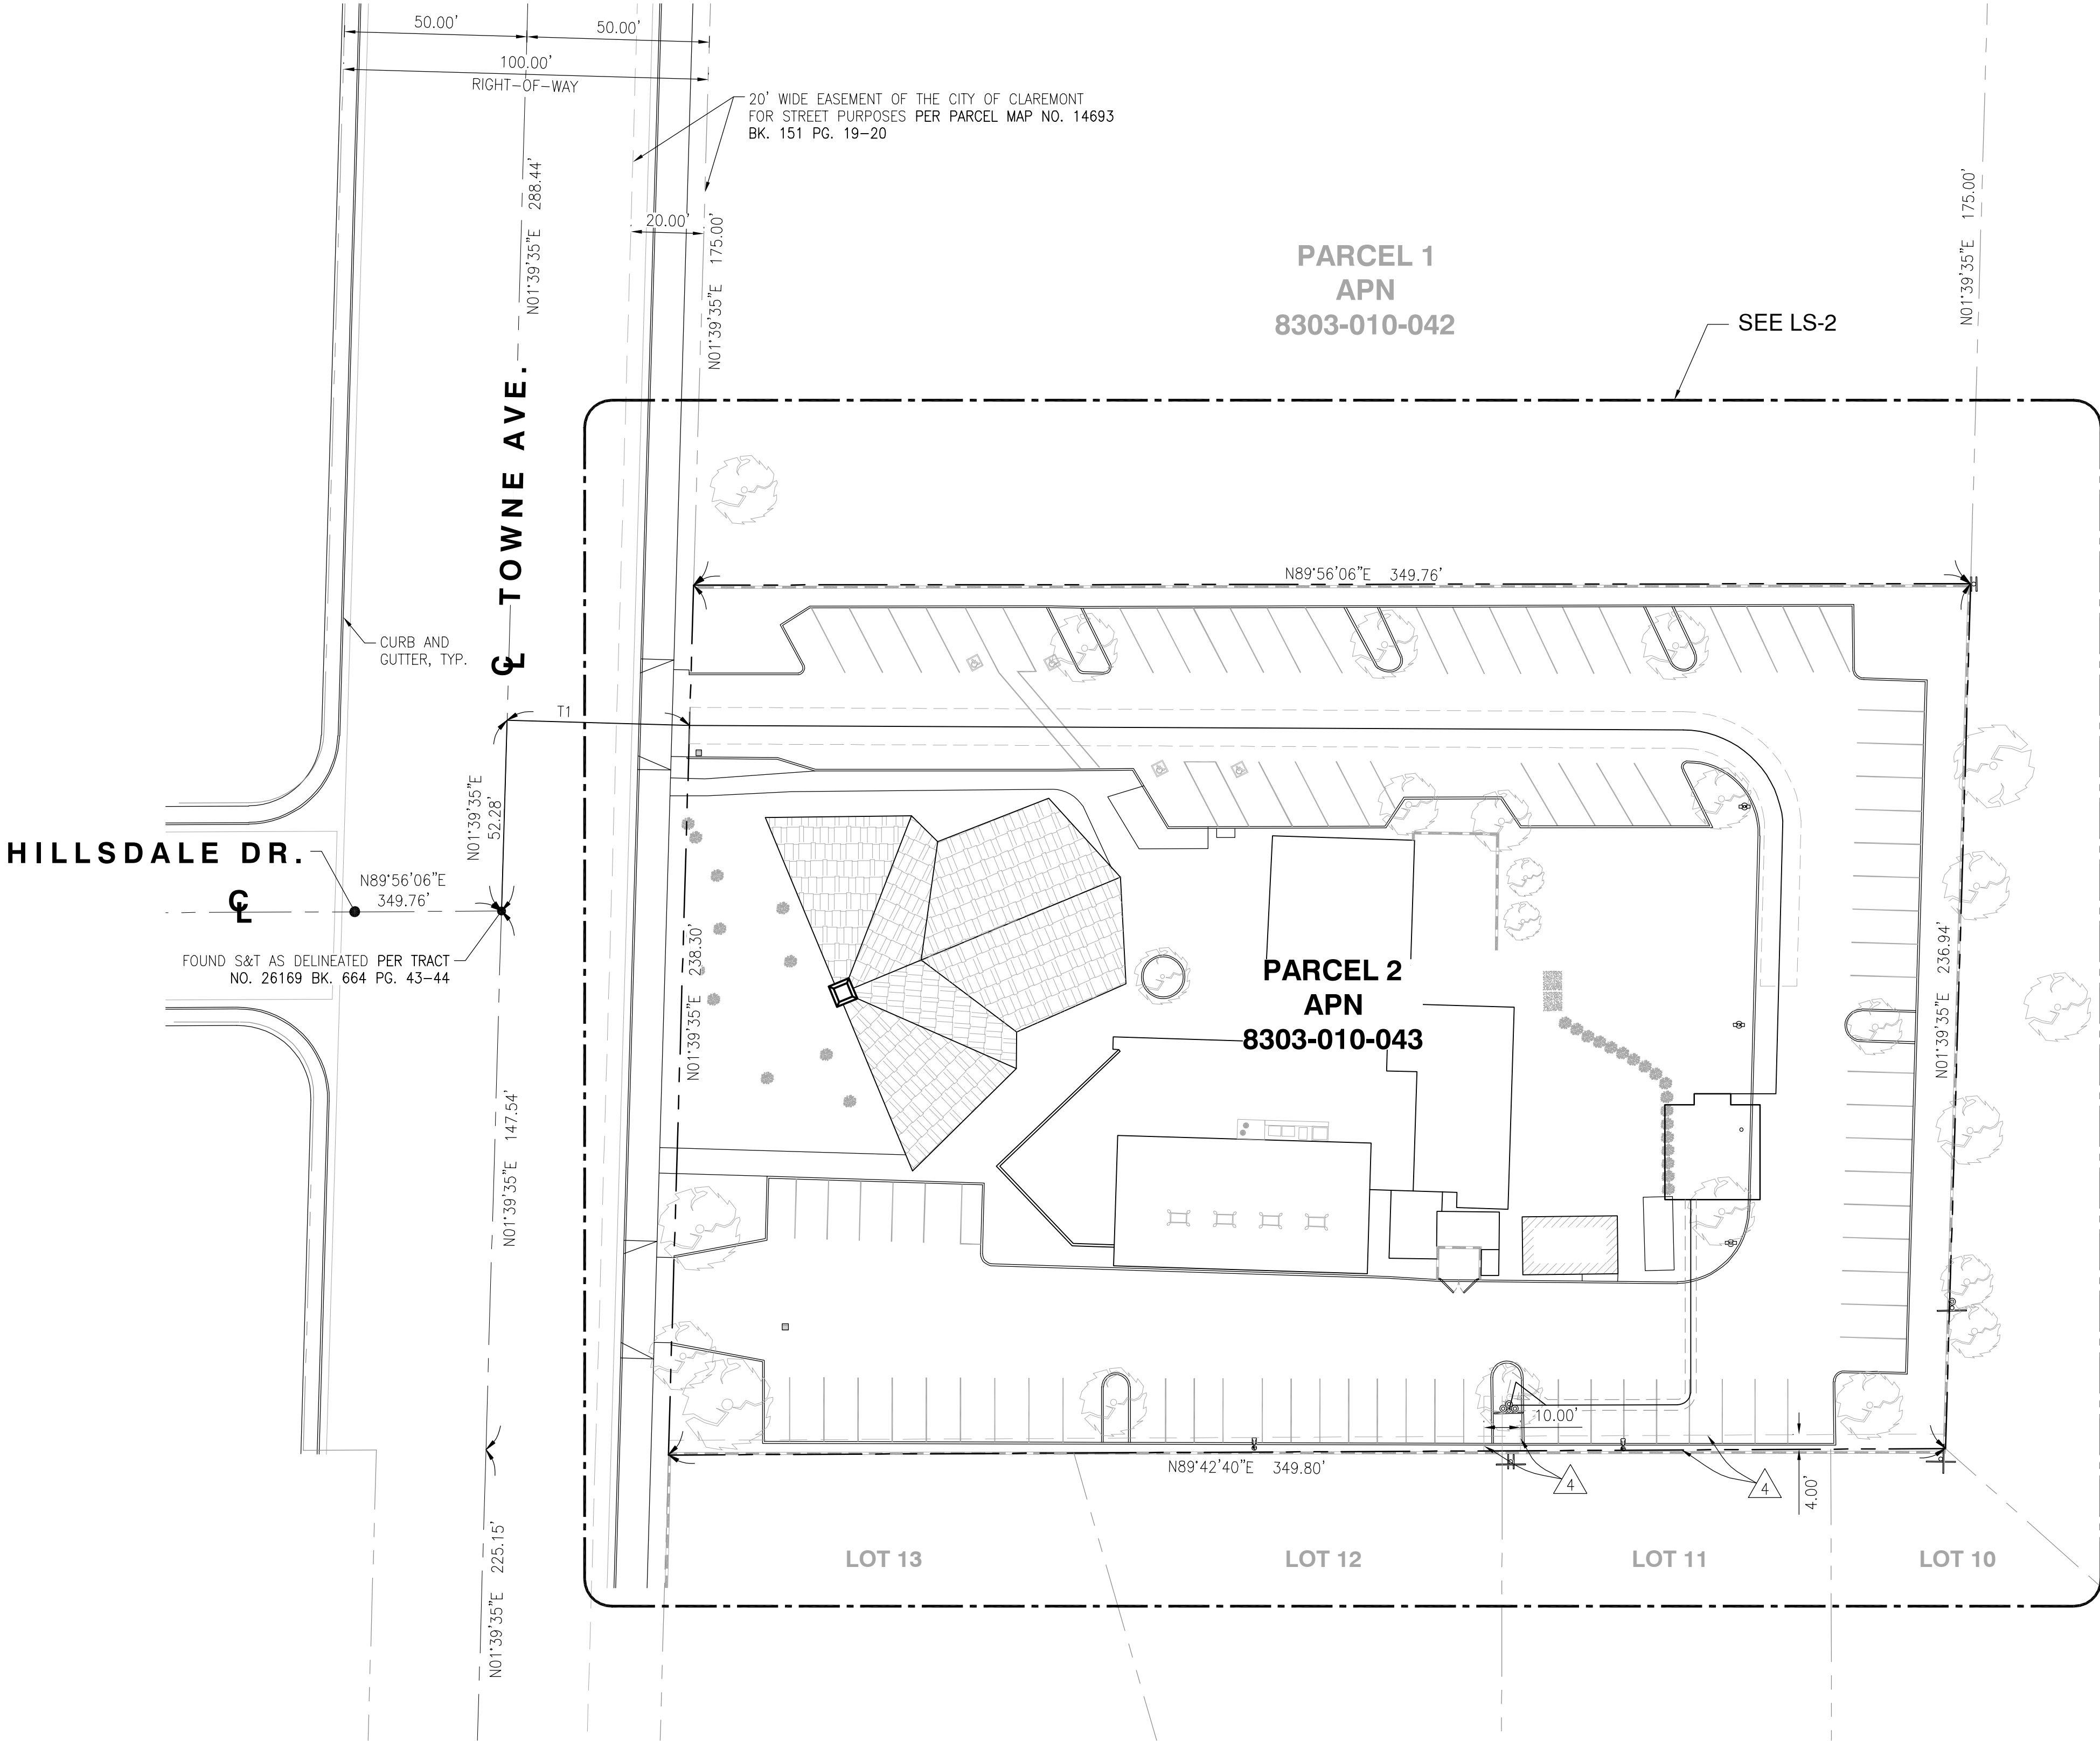

LINE TABLE		
NO.	LENGTH	BEARING
T1	50.00'	S88°20'25"E

LEGENDS

--- CENTER LINE
--- PROPERTY LINE
--- EASEMENT LINE



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an SFC Communications, Inc. Company

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REV	DATE	DESCRIPTION
6	04/07/2025	REVISED LEGAL DESCRIPTION
5	04/24/2023	REVISED LEASE AREA LOCATION
4	02/10/2023	LEGAL DESCRIPTION UPDATE
3	12/19/2022	ADDITIONAL SURVEY POINTS
2	04/11/2022	FINAL SURVEY
1	03/02/2022	PRELIMINARY SURVEY

ISSUED DATE:
APRIL 07, 2025

ISSUED FOR:
FINAL SURVEY

LICENSURE:



PROJECT INFORMATION:
CLL05463
1700 N. TOWNE AVE.,
CLAREMONT, CA 91711

DRAWN BY: KF
CHECKED BY: RH

SHEET TITLE:
TOPOGRAPHIC
SURVEY

SHEET NUMBER:
LS-1

LEGENDS

	CENTER LINE
	PROPERTY LINE
	EASEMENT LINE
	CMU WALL
	FLOW LINE
	EXISTING GRADE
	TOP OF CURB
	LIP OF GUTTER
	FINISH SURFACE
	TOP OF TREE
	TOP OF UTILITY POLE
	TOP OF LIGHT POLE
	TOP OF ROOF
	TOP OF CROSS
	UTILITY POLE
	UTILITY POLE
	TREE
	BUSH

COORDINATES

NEW AT&T FAUX-EUCALYPTUS

LATITUDE:	34°06'52.80"N (34.114667)
LONGITUDE:	117°44'08.43"W (-117.735675)

NEW AT&T EQUIPMENT LEASE AREA

LATITUDE:	34°06'52.91"N (34.114697)
LONGITUDE:	117°44'08.43"W (-117.735675)

TIE LINE TABLE		
NO.	LENGTH	BEARING
T2	12.35'	N90°00'00"W

ACCESS ROUTE CURVE TABLE			
NO.	DELTA	RADIUS	ARC LENGTH
A1	84°23'15"	27.49'	40.49'


LEASE AREA LINE TABLE		
NO.	LENGTH	BEARING
B1	10.00'	N90°00'00"W
B2	3.00'	S00°00'00"W
B3	8.00'	N90°00'00"W
B4	26.00'	S00°00'00"W
B5	7.04'	S90°00'00"E
B6	18.96'	S90°00'00"E
B7	26.00'	N00°00'00"E
B8	8.00'	N90°00'00"W
B9	3.00'	N00°00'00"E

UTILITY EASEMENT LINE TABLE		
NO.	LENGTH	BEARING
E1	36.00'	S89°56'05"W
E2	9.14'	S90°00'00"W
E3	10.36'	N52°15'49"W
E4	7.99'	S13°53'41"W

UTILITY EASEMENT CURVE TABLE			
NO.	DELTA	RADIUS	ARC LENGTH
F1	84°06'20"	3.71'	5.45'

PROPERTY LINES DERIVED FROM
PARCEL MAP NO. 14693 BK. 151 PG. 19-20
TRACT NO. 26169 BK. 664 PG. 43-44
TRACT NO. 22450 BK. 720 PG. 97-99

DATED APRIL 09, 1982
DATED DECEMBER 07, 1960
DATED APRIL 28, 1964

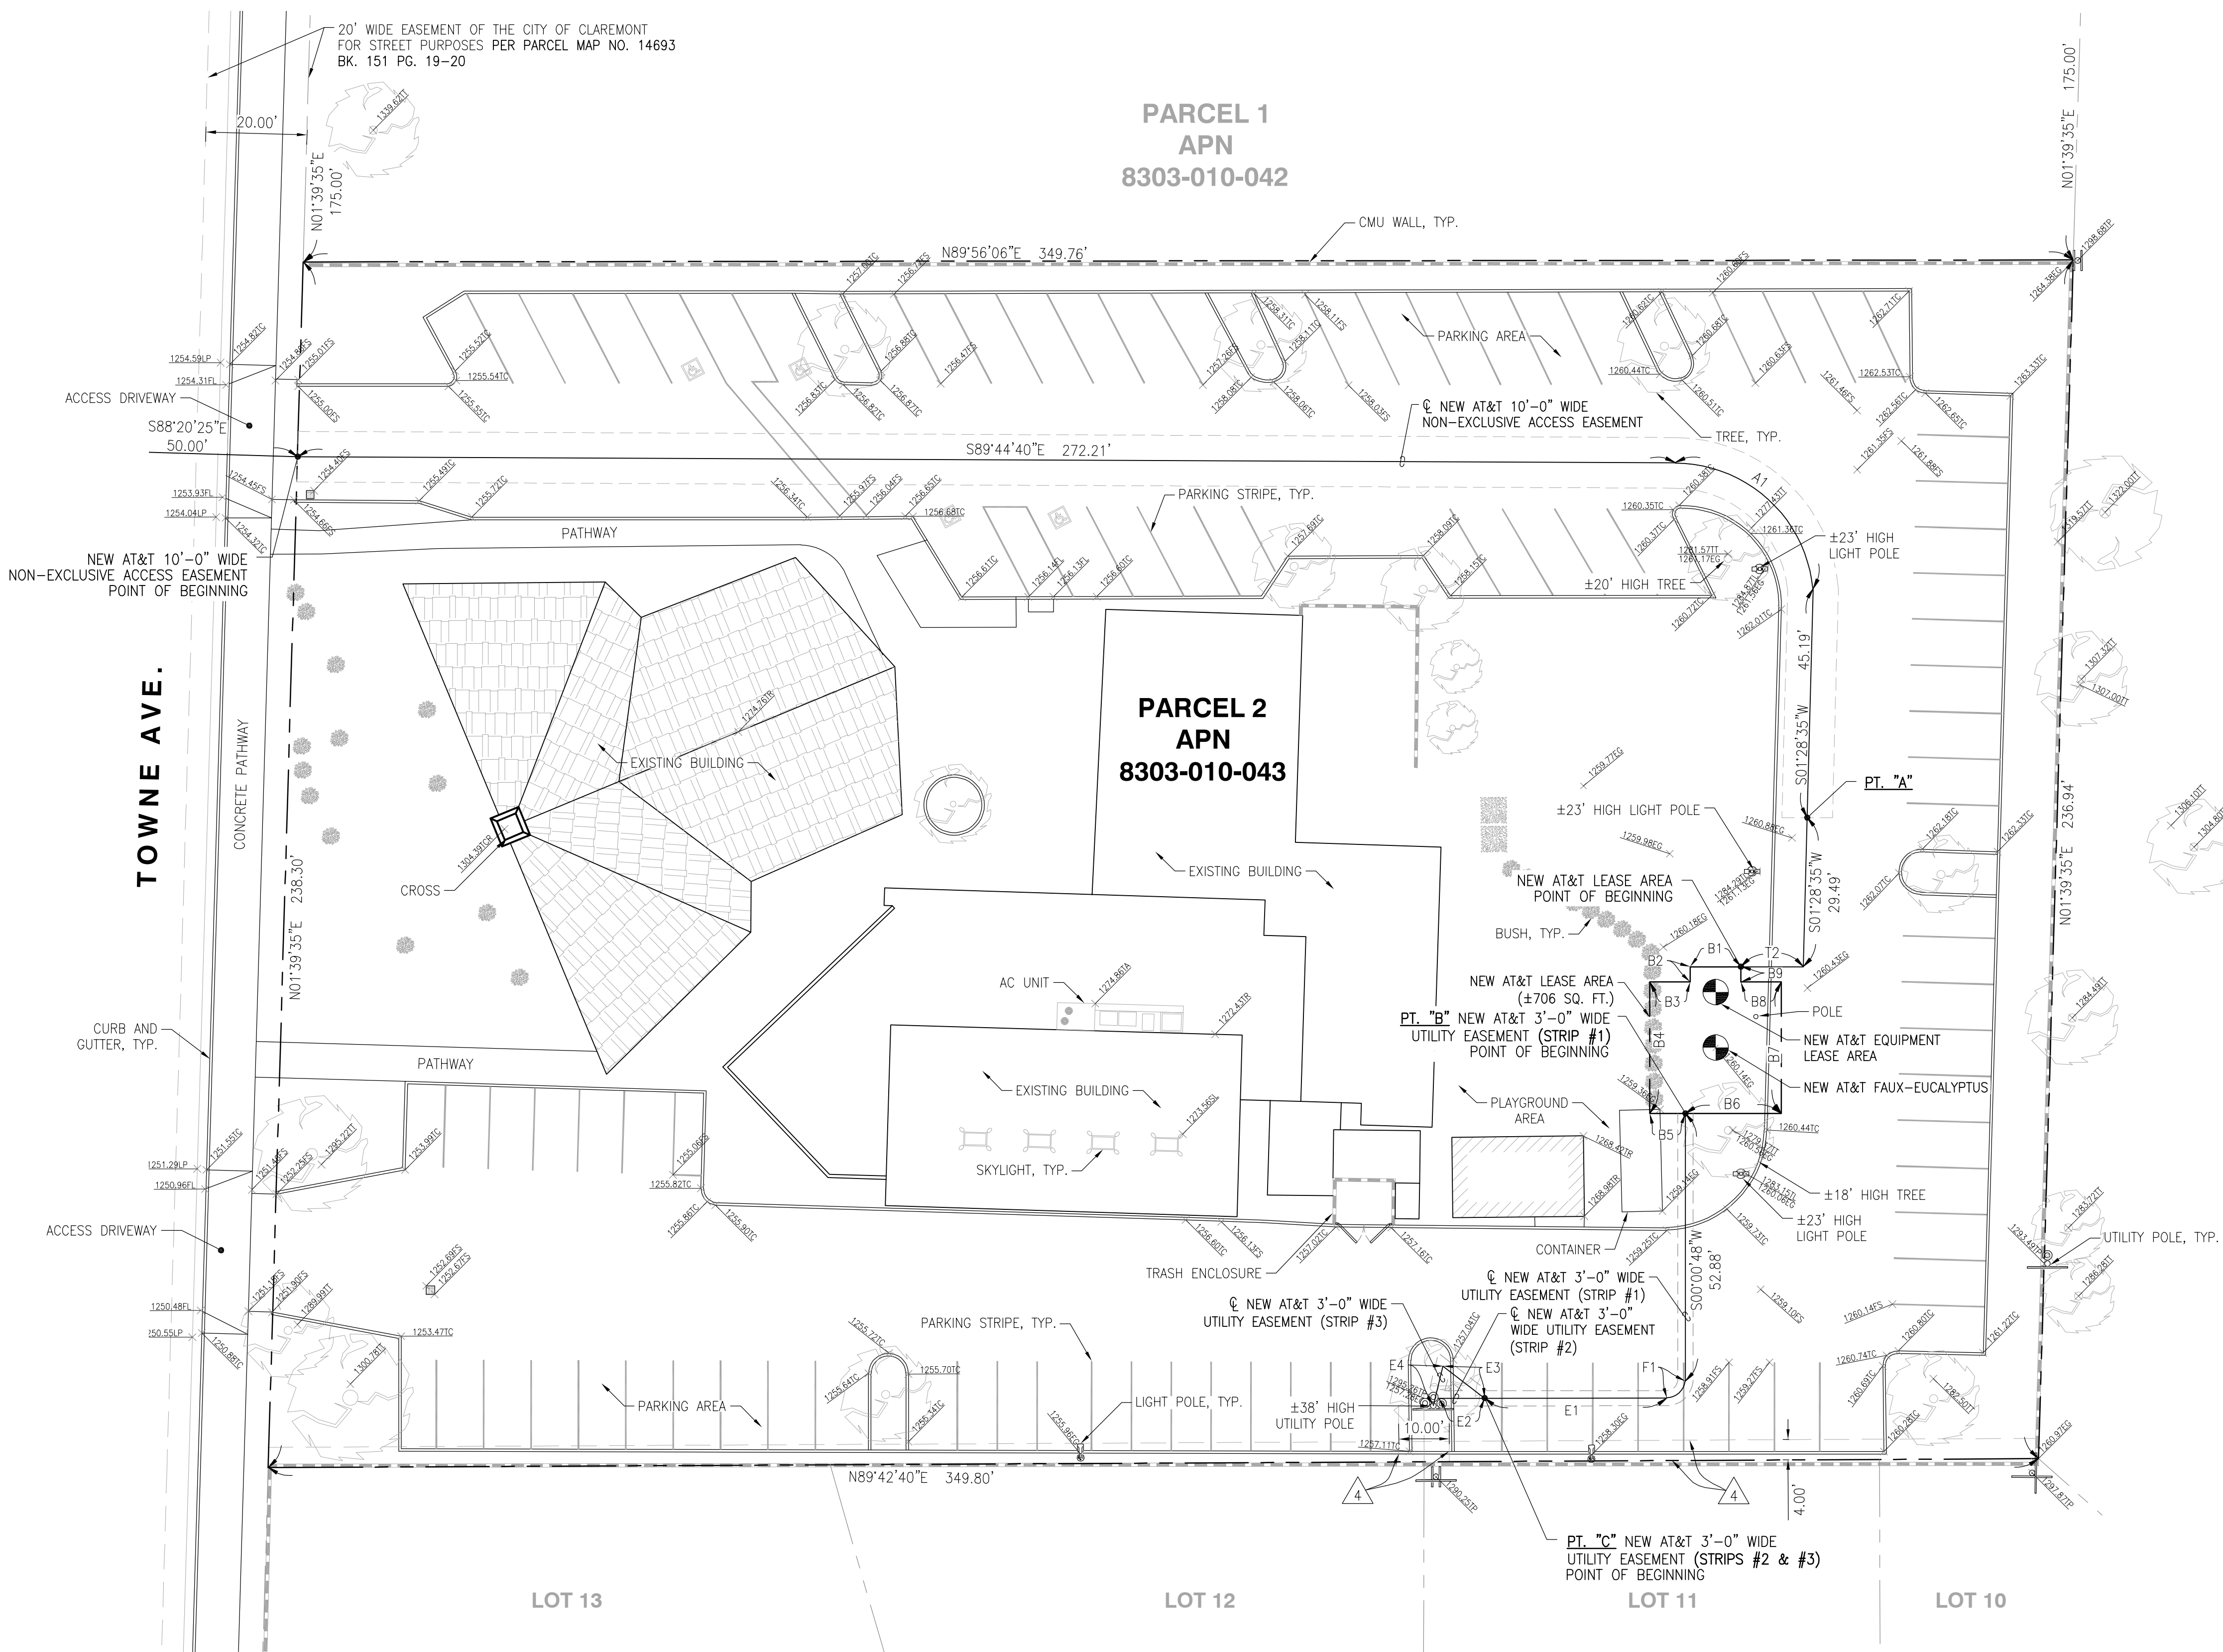

REV	DATE	DESCRIPTION
6	04/07/2025	REVISED LEGAL DESCRIPTION
5	04/24/2023	REVISED LEASE AREA LOCATION
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1	03/02/2022	PRELIMINARY SURVEY

ISSUED DATE:

APRIL 07, 2025

ISSUED FOR:

FINAL SURVEY

LICENSURE:



PROJECT INFORMATION:

CLL05463

1700 N. TOWNE AVE.,
CLAREMONT, CA 91711

DRAWN BY: KF

CHECKED BY: RH

SHEET TITLE:

TOPOGRAPHIC
SURVEY

SHEET NUMBER:

LS-2

10 FEET WIDE NON-EXCLUSIVE ACCESS EASEMENT CENTERLINE DESCRIPTION:

ALL THAT CERTAIN REAL PROPERTY SITUATED IN THE CITY OF CLAREMONT, COUNTY OF LOS ANGELES, STATE OF CALIFORNIA, DESCRIBED AS FOLLOWS:

PARCEL 2, IN THE CITY OF CLAREMONT, COUNTY OF LOS ANGELES, STATE OF CALIFORNIA, AS SHOWN ON PLAT RECORD OF IN BOOK 151, PAGE 19 AND 20 OF PARCEL MAPS, IN THE OFFICE OF THE COUNTY RECORDER OF SAID COUNTY.

A STRIP OF LAND FOR NON-EXCLUSIVE ACCESS EASEMENT PURPOSES FOR THE LAND REFERRED TO HEREIN SITUATED IN THE CITY OF CLAREMONT, COUNTY OF LOS ANGELES, STATE OF CALIFORNIA, AND IS DESCRIBED AS FOLLOWS:

AN EASEMENT TEN (10.00) FEET IN WIDTH LYING FIVE (5.00) FEET ON EACH SIDE OF THE FOLLOWING DESCRIBED CENTERLINE TO WIT:

COMMENCING AT THE CENTERLINE INTERSECTION OF TOWNE AVENUE AND HILLSDALE DRIVE, AS SHOWN ON THAT TRACT NO. 26169 AS PER MAP FILED IN BOOK 664 PAGES 43 THROUGH 44 OF MAPS IN THE OFFICE OF THE COUNTY RECORDER OF LOS ANGELES COUNTY; THENCE NORTHERLY ALONG THE SAID CENTERLINE OF TOWNE AVENUE, NORTH 01°39'35" EAST A DISTANCE OF 52.28 FEET; THENCE EASTERLY LEAVING SAID CENTERLINE OF TOWNE AVENUE, SOUTH 88°20'25" EAST A DISTANCE OF 50.00 FEET TO THE WESTERLY LINE OF SAID PARCEL 2, ALSO BEING THE POINT OF BEGINNING OF THIS CENTERLINE DESCRIPTION;

THENCE LEAVING SAID WESTERLY LINE OF SAID PARCEL 2, SOUTH 89°44'40" EAST A DISTANCE OF 272.21 FEET TO THE BEGINNING OF A TANGENT CURVE CONCAVE TO THE SOUTHWEST HAVING A RADIUS OF 27.49 FEET; THENCE SOUTHEASTERLY, 40.49 FEET ALONG SAID CURVE THROUGH A CENTRAL ANGLE OF 84°23'15"; THENCE SOUTH 01°28'35" WEST A DISTANCE OF 45.19 FEET TO A POINT REFERRED TO HEREINAFTER AS POINT "A" ALSO BEING THE TERMINUS POINT OF THIS CENTERLINE DESCRIPTION.

THE SIDE LINES OF SAID TEN (10.00) FEET WIDE ACCESS EASEMENT IS TO BE EXTENDED AND/OR SHORTENED TO TERMINATE IN THE LANDS OF THE GRANTOR AND SHALL BE JOINED AT ALL ANGLE POINTS.

SUBJECT TO ALL EASEMENTS AND/OR RIGHT-OF-WAY RECORDS.

SEE NON-EXCLUSIVE ACCESS EASEMENT ON SHEET LS-2.

NEW AT&T LEASE AREA DESCRIPTION

ALL THAT CERTAIN REAL PROPERTY SITUATED IN THE CITY OF CLAREMONT, COUNTY OF LOS ANGELES, STATE OF CALIFORNIA, DESCRIBED AS FOLLOWS:

PARCEL 2, IN THE CITY OF CLAREMONT, COUNTY OF LOS ANGELES, STATE OF CALIFORNIA, AS SHOWN ON PLAT RECORD OF IN BOOK 151, PAGE 19 AND 20 OF PARCEL MAPS, IN THE OFFICE OF THE COUNTY RECORDER OF SAID COUNTY.

A STRIP OF LAND FOR AT&T LEASE AREA PURPOSES FOR THE LAND REFERRED TO HEREIN SITUATED IN THE CITY OF CLAREMONT, COUNTY OF LOS ANGELES, STATE OF CALIFORNIA, AND IS DESCRIBED AS FOLLOWS TO WIT:

BEGINNING AT SAID POINT "A";
THENCE SOUTH 01°28'35" WEST, A DISTANCE OF 29.49 FEET;
THENCE NORTH 90°00'00" WEST, A DISTANCE OF 12.35 FEET TO THE POINT OF BEGINNING OF THIS NEW AT&T LEASE AREA DESCRIPTION;
THENCE NORTH 90°00'00" WEST, A DISTANCE OF 10.00 FEET;
THENCE SOUTH 00°00'00" WEST, A DISTANCE OF 3.00 FEET;
THENCE NORTH 90°00'00" WEST, A DISTANCE OF 8.00 FEET;
THENCE SOUTH 00°00'00" WEST, A DISTANCE OF 26.00 FEET;
THENCE SOUTH 90°00'00" EAST, A DISTANCE OF 7.04 FEET TO A POINT REFERRED TO HEREINAFTER AS POINT "B";
THENCE SOUTH 90°00'00" EAST, A DISTANCE OF 18.96 FEET;
THENCE NORTH 00°00'00" EAST, A DISTANCE OF 26.00 FEET;
THENCE NORTH 90°00'00" WEST, A DISTANCE OF 8.00 FEET;
THENCE NORTH 00°00'00" EAST, A DISTANCE OF 3.00 FEET TO THE POINT OF BEGINNING OF THIS NEW AT&T LEASE AREA DESCRIPTION.

CONTAINING 706 SQUARE FEET MORE OR LESS.

SUBJECT TO ALL EASEMENTS AND/OR RIGHT-OF-WAY RECORDS.

SEE NEW AT&T LEASE AREA ON SHEET LS-2.

3 FEET WIDE UTILITY EASEMENT CENTERLINE DESCRIPTION (STRIP #1):

ALL THAT CERTAIN REAL PROPERTY SITUATED IN THE CITY OF CLAREMONT, COUNTY OF LOS ANGELES, STATE OF CALIFORNIA, DESCRIBED AS FOLLOWS:

PARCEL 2, IN THE CITY OF CLAREMONT, COUNTY OF LOS ANGELES, STATE OF CALIFORNIA, AS SHOWN ON PLAT RECORD OF IN BOOK 151, PAGE 19 AND 20 OF PARCEL MAPS, IN THE OFFICE OF THE COUNTY RECORDER OF SAID COUNTY.

A STRIP OF LAND FOR UTILITY EASEMENT PURPOSES FOR THE LAND REFERRED TO HEREIN SITUATED IN THE CITY OF CLAREMONT, COUNTY OF LOS ANGELES, STATE OF CALIFORNIA AND IS DESCRIBED AS FOLLOWS:

AN EASEMENT FOR FIBER AND POWER UTILITIES THREE (3.00) FEET IN WIDTH LYING ONE AND A HALF (1.50) FEET ON EACH SIDE OF THE FOLLOWING DESCRIBED CENTERLINE TO WIT:

BEGINNING AT SAID POINT "B";
THENCE SOUTH 00°00'48" WEST, A DISTANCE OF 52.88 FEET TO THE BEGINNING OF A NON-TANGENT CURVE CONCAVE TO THE NORTHWEST HAVING A RADIUS OF 3.71 FEET AND TO WHICH SAID BEGINNING A RADIAL LINE BEARS SOUTH 84°21'27" EAST; THENCE SOUTHWESTERLY, 5.45 FEET ALONG SAID CURVE THROUGH A CENTRAL ANGLE OF 84°06'20"; THENCE SOUTH 89°56'05" WEST, A DISTANCE OF 36.00 FEET TO A POINT REFERRED TO HEREINAFTER AS POINT "C", ALSO BEING THE TERMINUS POINT OF THIS CENTERLINE DESCRIPTION.

THE SIDE LINES OF SAID THREE (3.00) FEET WIDE UTILITY EASEMENT IS TO BE EXTENDED AND/OR SHORTENED TO TERMINATE IN THE LANDS OF THE GRANTOR AND SHALL BE JOINED AT ALL ANGLE POINTS.

SUBJECT TO ALL EASEMENTS AND/OR RIGHT-OF-WAY RECORDS.

SEE UTILITY EASEMENT (STRIP #1) ON SHEET LS-2.

3 FEET WIDE UTILITY EASEMENT CENTERLINE DESCRIPTION (STRIP #2):

ALL THAT CERTAIN REAL PROPERTY SITUATED IN THE CITY OF CLAREMONT, COUNTY OF LOS ANGELES, STATE OF CALIFORNIA, DESCRIBED AS FOLLOWS:

PARCEL 2, IN THE CITY OF CLAREMONT, COUNTY OF LOS ANGELES, STATE OF CALIFORNIA, AS SHOWN ON PLAT RECORD OF IN BOOK 151, PAGE 19 AND 20 OF PARCEL MAPS, IN THE OFFICE OF THE COUNTY RECORDER OF SAID COUNTY.

A STRIP OF LAND FOR UTILITY EASEMENT PURPOSES FOR THE LAND REFERRED TO HEREIN SITUATED IN THE CITY OF CLAREMONT, COUNTY OF LOS ANGELES, STATE OF CALIFORNIA AND IS DESCRIBED AS FOLLOWS:

AN EASEMENT FOR POWER UTILITIES THREE (3.00) FEET IN WIDTH LYING ONE AND A HALF (1.50) FEET ON EACH SIDE OF THE FOLLOWING DESCRIBED CENTERLINE TO WIT:

BEGINNING AT SAID POINT "C";
THENCE SOUTH 90°00'00" WEST, A DISTANCE OF 9.14 FEET TO THE TERMINUS POINT OF THIS CENTERLINE DESCRIPTION.

THE SIDE LINES OF SAID THREE (3.00) FEET WIDE UTILITY EASEMENT IS TO BE EXTENDED AND/OR SHORTENED TO TERMINATE IN THE LANDS OF THE GRANTOR AND SHALL BE JOINED AT ALL ANGLE POINTS.

SUBJECT TO ALL EASEMENTS AND/OR RIGHT-OF-WAY RECORDS.

SEE UTILITY EASEMENT (STRIP #2) ON SHEET LS-2.

3 FEET WIDE UTILITY EASEMENT CENTERLINE DESCRIPTION (STRIP #3):

ALL THAT CERTAIN REAL PROPERTY SITUATED IN THE CITY OF CLAREMONT, COUNTY OF LOS ANGELES, STATE OF CALIFORNIA, DESCRIBED AS FOLLOWS:

PARCEL 2, IN THE CITY OF CLAREMONT, COUNTY OF LOS ANGELES, STATE OF CALIFORNIA, AS SHOWN ON PLAT RECORD OF IN BOOK 151, PAGE 19 AND 20 OF PARCEL MAPS, IN THE OFFICE OF THE COUNTY RECORDER OF SAID COUNTY.

A STRIP OF LAND FOR UTILITY EASEMENT PURPOSES FOR THE LAND REFERRED TO HEREIN SITUATED IN THE CITY OF CLAREMONT, COUNTY OF LOS ANGELES, STATE OF CALIFORNIA AND IS DESCRIBED AS FOLLOWS:

AN EASEMENT FOR FIBER UTILITIES THREE (3.00) FEET IN WIDTH LYING ONE AND A HALF (1.50) FEET ON EACH SIDE OF THE FOLLOWING DESCRIBED CENTERLINE TO WIT:

BEGINNING AT SAID POINT "C";
THENCE NORTH 52°15'49" WEST, A DISTANCE OF 10.36 FEET;
THENCE SOUTH 13°53'41" WEST, A DISTANCE OF 7.99 FEET TO THE TERMINUS POINT OF THIS CENTERLINE DESCRIPTION.

THE SIDE LINES OF SAID THREE (3.00) FEET WIDE UTILITY EASEMENT IS TO BE EXTENDED AND/OR SHORTENED TO TERMINATE IN THE LANDS OF THE GRANTOR AND SHALL BE JOINED AT ALL ANGLE POINTS.

SUBJECT TO ALL EASEMENTS AND/OR RIGHT-OF-WAY RECORDS.

SEE UTILITY EASEMENT (STRIP #3) ON SHEET LS-2.



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6	04/07/2025	REVISED LEGAL DESCRIPTION
5	04/24/2023	REVISED LEASE AREA LOCATION
4	02/10/2023	LEGAL DESCRIPTION UPDATE
3	12/19/2022	ADDITIONAL SURVEY POINTS
2	04/11/2022	FINAL SURVEY
1	03/02/2022	PRELIMINARY SURVEY
REV	DATE	DESCRIPTION

ISSUED DATE:

APRIL 07, 2025

ISSUED FOR:

FINAL SURVEY

LICENSURE:



PROJECT INFORMATION:

CLL05463

1700 N. TOWNE AVE.,
CLAREMONT, CA 91711

DRAWN BY: KF

CHECKED BY: RH



SHEET TITLE:

TOPOGRAPHIC
SURVEY

SHEET NUMBER:

LS-3

1. THIS SITE PLAN IS NOT INTENDED TO BE A LAND SURVEY.

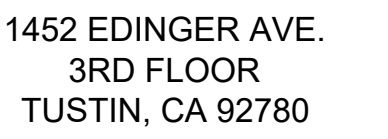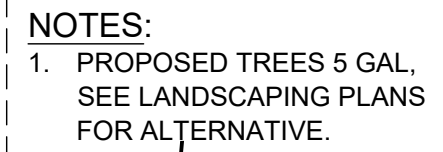

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CONSTRUCTION DRAWINGS

PROJECT INFORMATION

1700 N. TOWNE AVE.
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SITE PLAN

A-1

SITE PLAN

1

NOTES:
1. THIS SITE PLAN IS NOT INTENDED TO BE A LAND SURVEY.

NOTES:
1. PROPOSED TREES 5 GAL,
SEE LANDSCAPING PLANS
FOR ALTERNATIVE.



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DRAWN BY:	UTILITIES CHECKED BY:	A&E CHECKED BY:
DW/AS	GD	RB

CONSTRUCTION DRAWINGS

SUBMITTALS

[illegible]

PROJECT INFORMATION

CLL05463



1700 N. TOWNE AVE.
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SHEET TITLE

ENLARGED
SITE PLAN

SHEET NUMBER

A-1.1

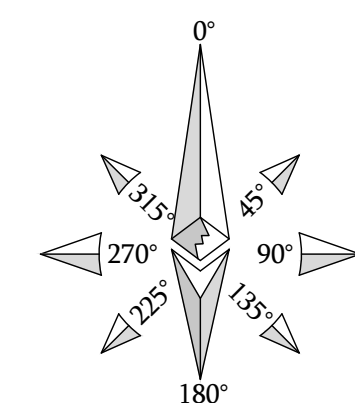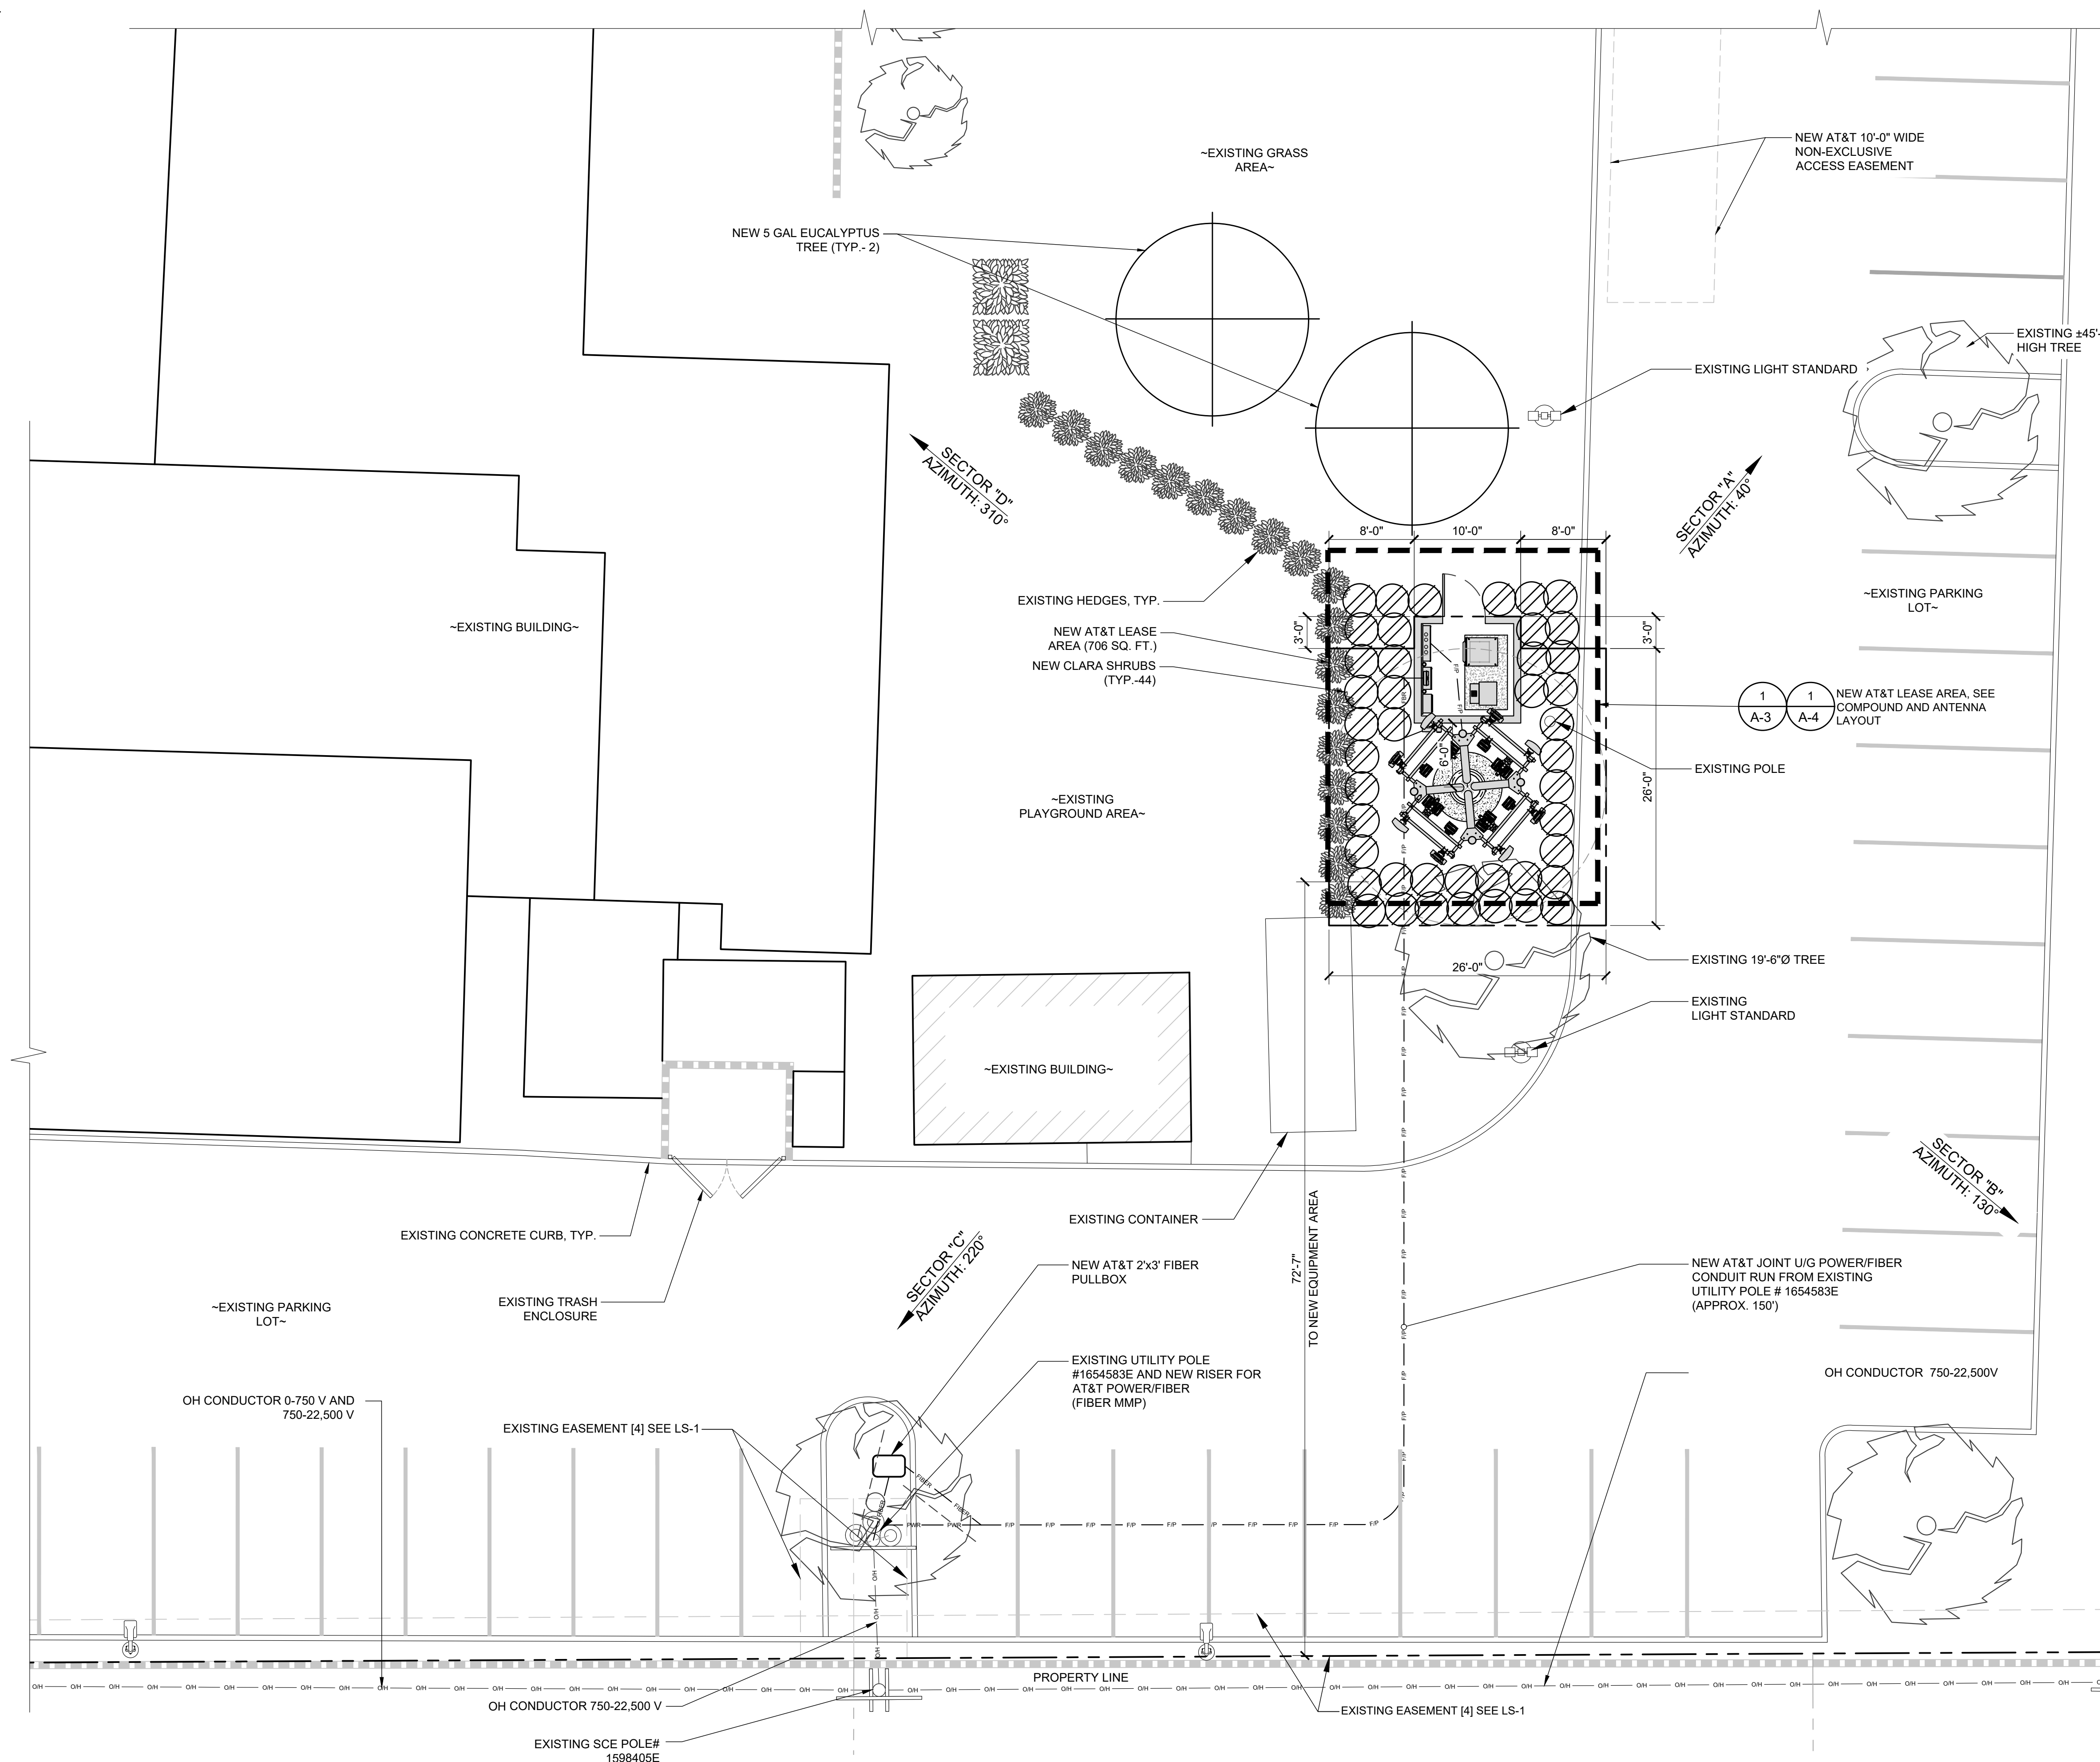


SCALE	8'	0	4'	8'	16'	32'
1/8"=1'-0"						

1

EUKON_AT&T_90CD_MONOPOLE TEMPLATE_V2_11-18-22

ENLARGED SITE PLAN

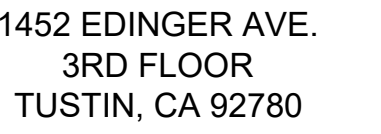

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DW/AS	GD	RB

CONSTRUCTION DRAWINGS

SUBMITTALS

[illegible]

PROJECT INFORMATION

CLL05463

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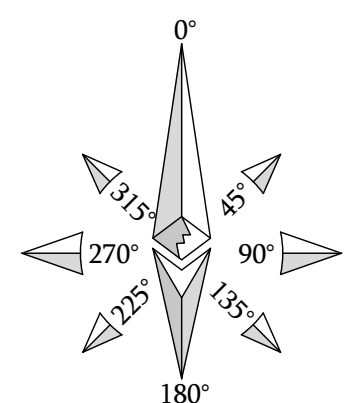
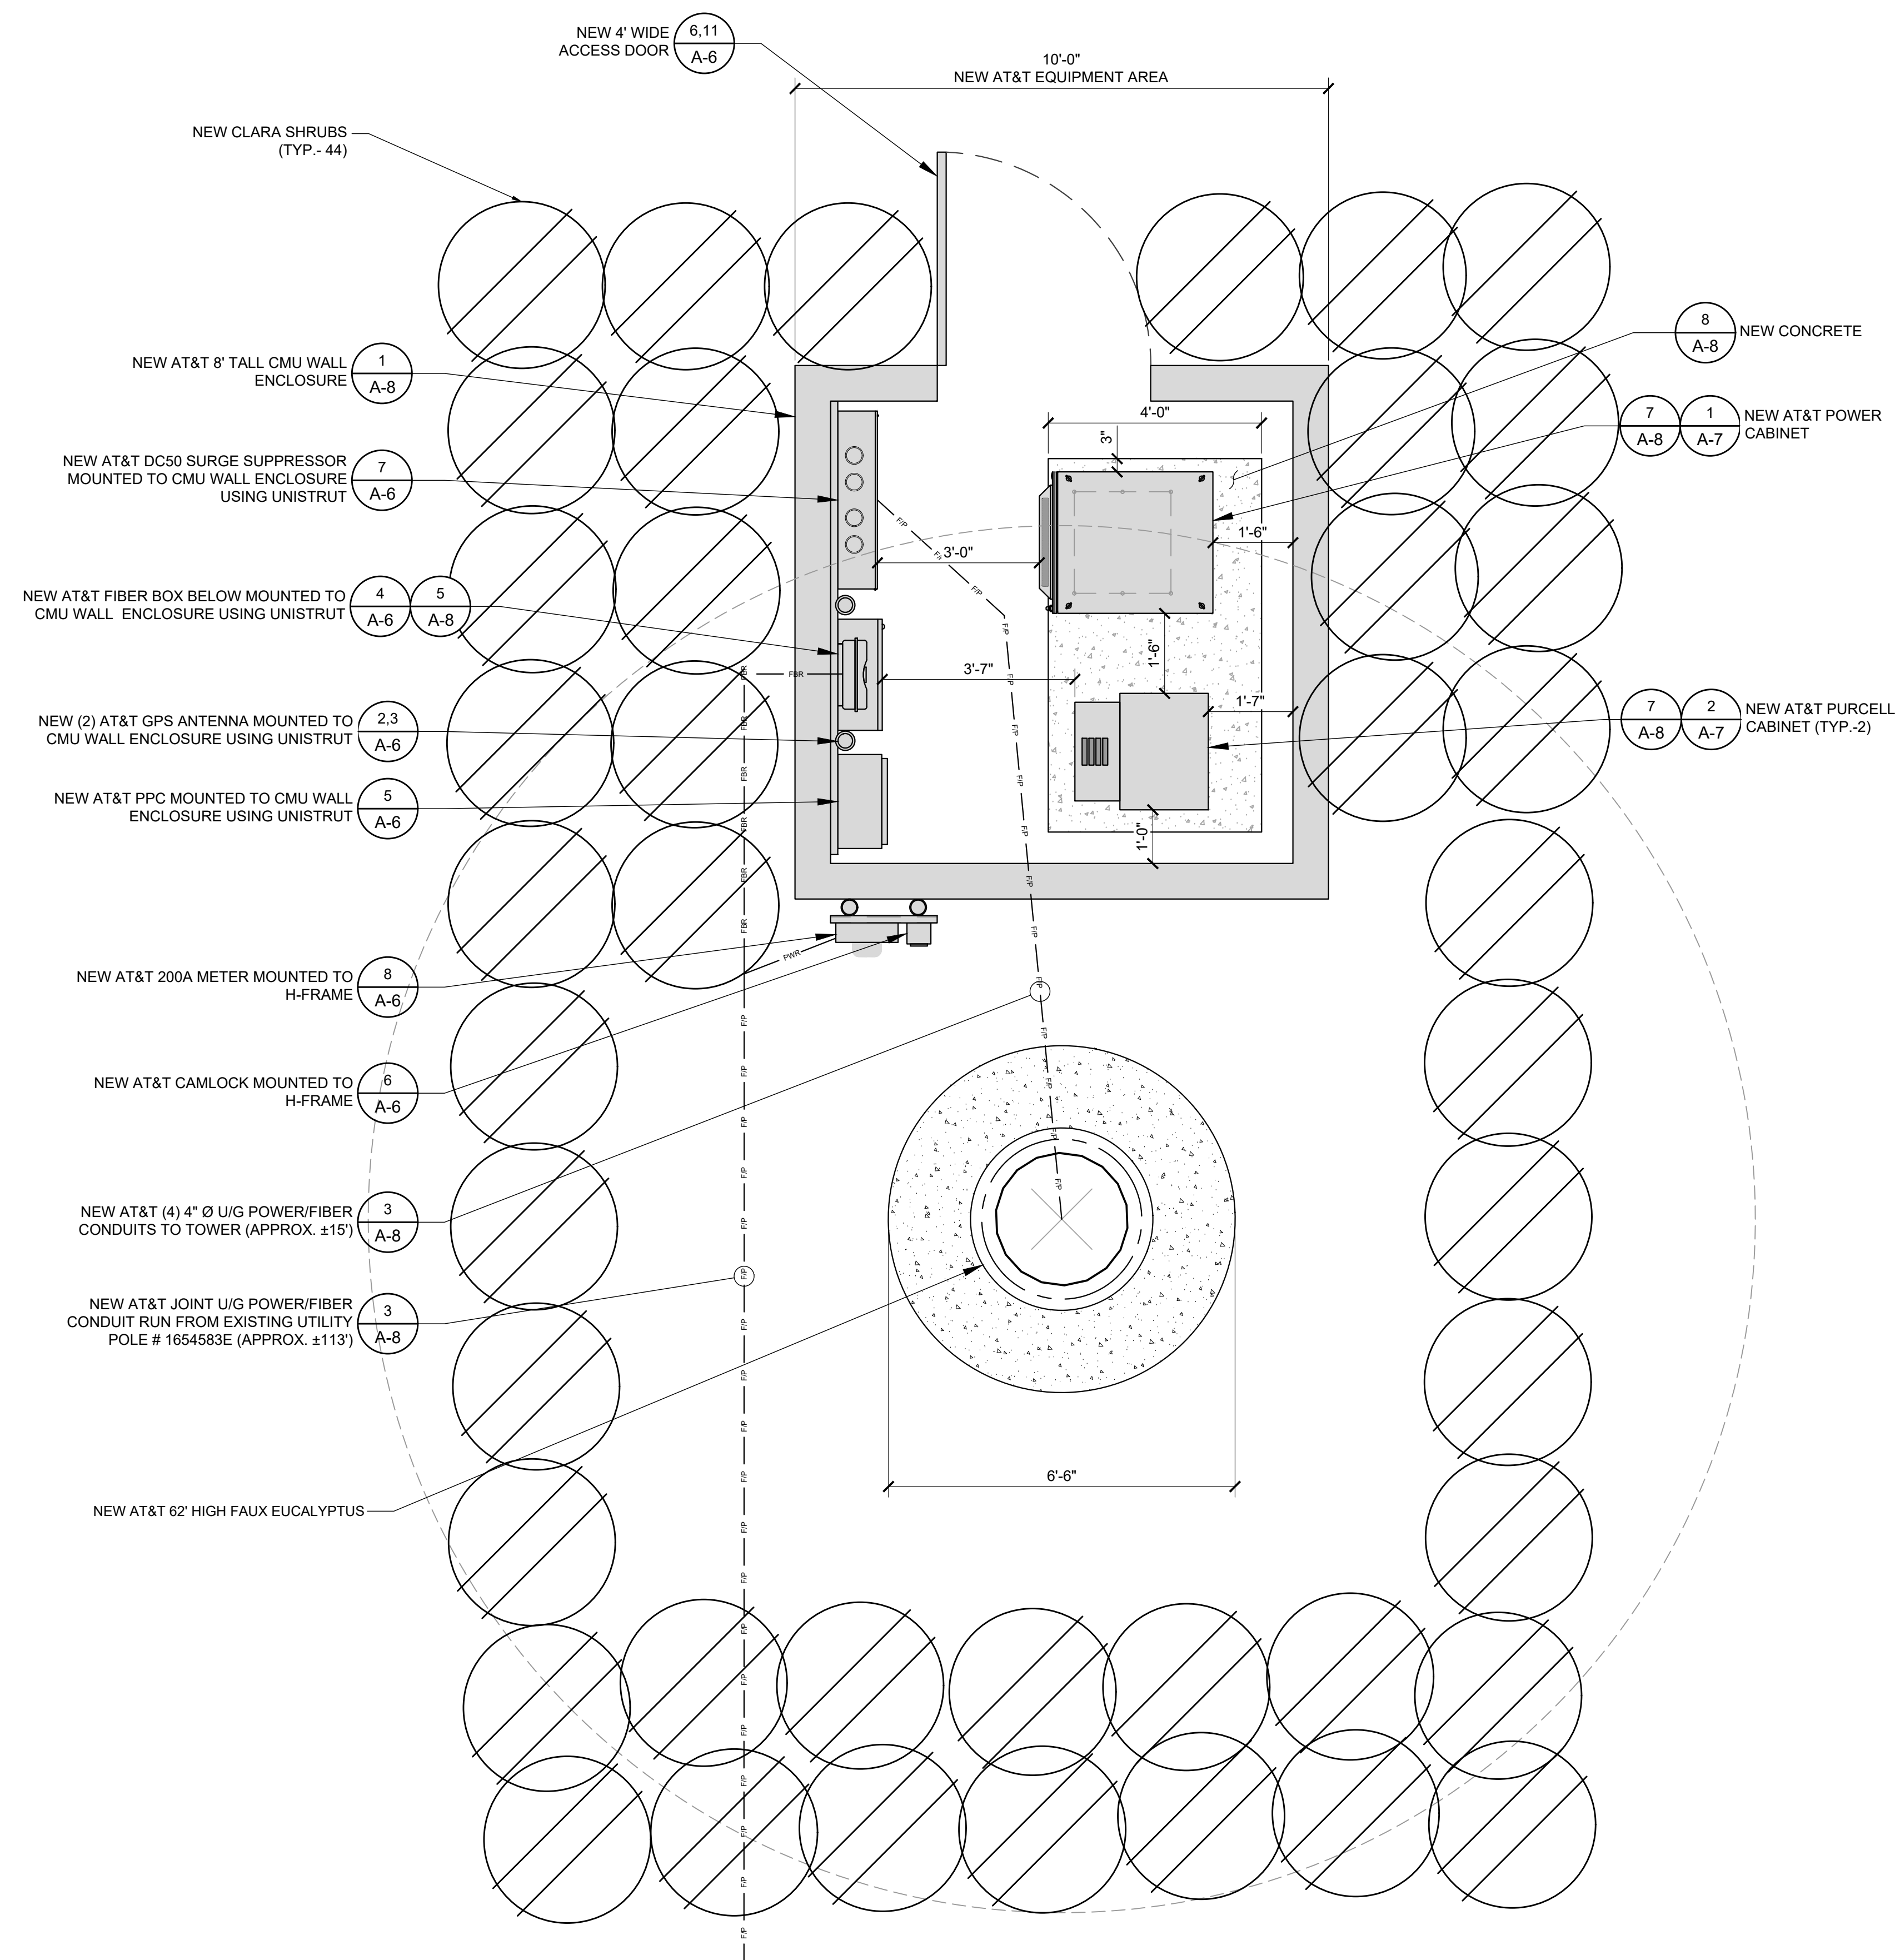
SHEET TITLE

EQUIPMENT PLAN

SHEET NUMBER

A-2

NOTES:
1. PROPOSED TREES 5 GAL,
SEE LANDSCAPING PLANS
FOR ALTERNATIVE.



EQUIPMENT PLAN

SCALE
1/2"=1'-0"



1



	ANTENNA SCHEDULE (VERIFY WITH CURRENT RFDS)							
	SECTOR	TECHNOLOGY	ANTENNA MODEL	ANTENNA SIZE	ANTENNA AZIMUTH	RAD CENTER	TRANSMISSION CABLE	
							LENGTH	QTY.
ALPHA SECTOR	A1	LTE	CCI TPA-45R-KU8AA-K	8'-0"	40°	53'-0"	±75'	1 FIBER + 3 DC POWER
	A2	C-BAND	ERICSSON AIR6419 B77D	2'-7"	40°	55'-9"		
		C-BAND	ERICSSON AIR6419 B77G	2'-7"	40°	51'-8"		
	A3	LTE	CCI TPA-45R-KU8AA-K	8'-0"	40°	42'-0"	±65'	
	A4	LTE	CCI TPA-45R-KU8AA-K	8'-0"	40°	42'-0"		
BETA SECTOR	B1	C-BAND	ERICSSON AIR6449 B77D	2'-7"	130°	55'-9"	±75'	1 FIBER + 3 DC POWER
		C-BAND	ERICSSON AIR6419 B77G	2'-7"	130°	51'-8"		
	B2	LTE	CCI TPA-45R-KU8AA-K	8'-0"	130°	53'-0"		
	B3	LTE	CCI TPA-45R-KU8AA-K	8'-0"	130°	42'-0"		
	B4	LTE	CCI TPA-45R-KU8AA-K	8'-0"	130°	42'-0"		
GAMMA SECTOR	C1	LTE	CCI TPA-45R-KU8AA-K	8'-0"	220°	53'-0"	±75'	1 FIBER + 3 DC POWER
	C2	C-BAND	ERICSSON AIR6449 B77D	2'-7"	220°	55'-9"		
		C-BAND	ERICSSON AIR6419 B77G	2'-7"	220°	51'-8"		
	C3	LTE	CCI TPA-45R-KU8AA-K	8'-0"	220°	42'-0"	±65'	
	C4	LTE	CCI TPA-45R-KU8AA-K	8'-0"	220°	42'-0"		
DELTA SECTOR	D1	C-BAND	ERICSSON AIR6449 B77D	2'-7"	310°	55'-9"	±75'	1 FIBER + 3 DC POWER
		C-BAND	ERICSSON AIR6419 B77G	2'-7"	310°	51'-8"		
	D2	LTE	CCI TPA-45R-KU8AA-K	8'-0"	310°	53'-0"		
	D3	LTE	CCI TPA-45R-KU8AA-K	8'-0"	310°	42'-0"		
	D4	LTE	CCI TPA-45R-KU8AA-K	8'-0"	310°	42'-0"		

NOTES TO CONTRACTOR

- CONTRACTOR IS TO REFER TO AT&T'S MOST CURRENT RADIO FREQUENCY DATA SHEET (RFDS) PRIOR TO CONSTRUCTION.
- CABLE LENGTHS WERE DETERMINED BASED ON A VISUAL INSPECTION DURING SITE WALK. CONTRACTOR TO VERIFY ACTUAL LENGTH DURING PRE-CONSTRUCTION WALK.
- CONTRACTOR TO USE ROSENBERGER FIBER LINE HANGER COMPONENTS (OR ENGINEER APPROVED EQUAL).
- CONTRACTOR TO USE CABLES SPECIFIED (OR ENGINEER APPROVED EQUAL).

NOTES:

- ALL ANTENNAS TO BE EQUIPPED WITH FRP SOCKS.
- ALL ANTENNAS, SURGE SUPPRESSOR AND HARDWARE TO BE PAINTED GREEN TO MATCH NEW BRANCHES.

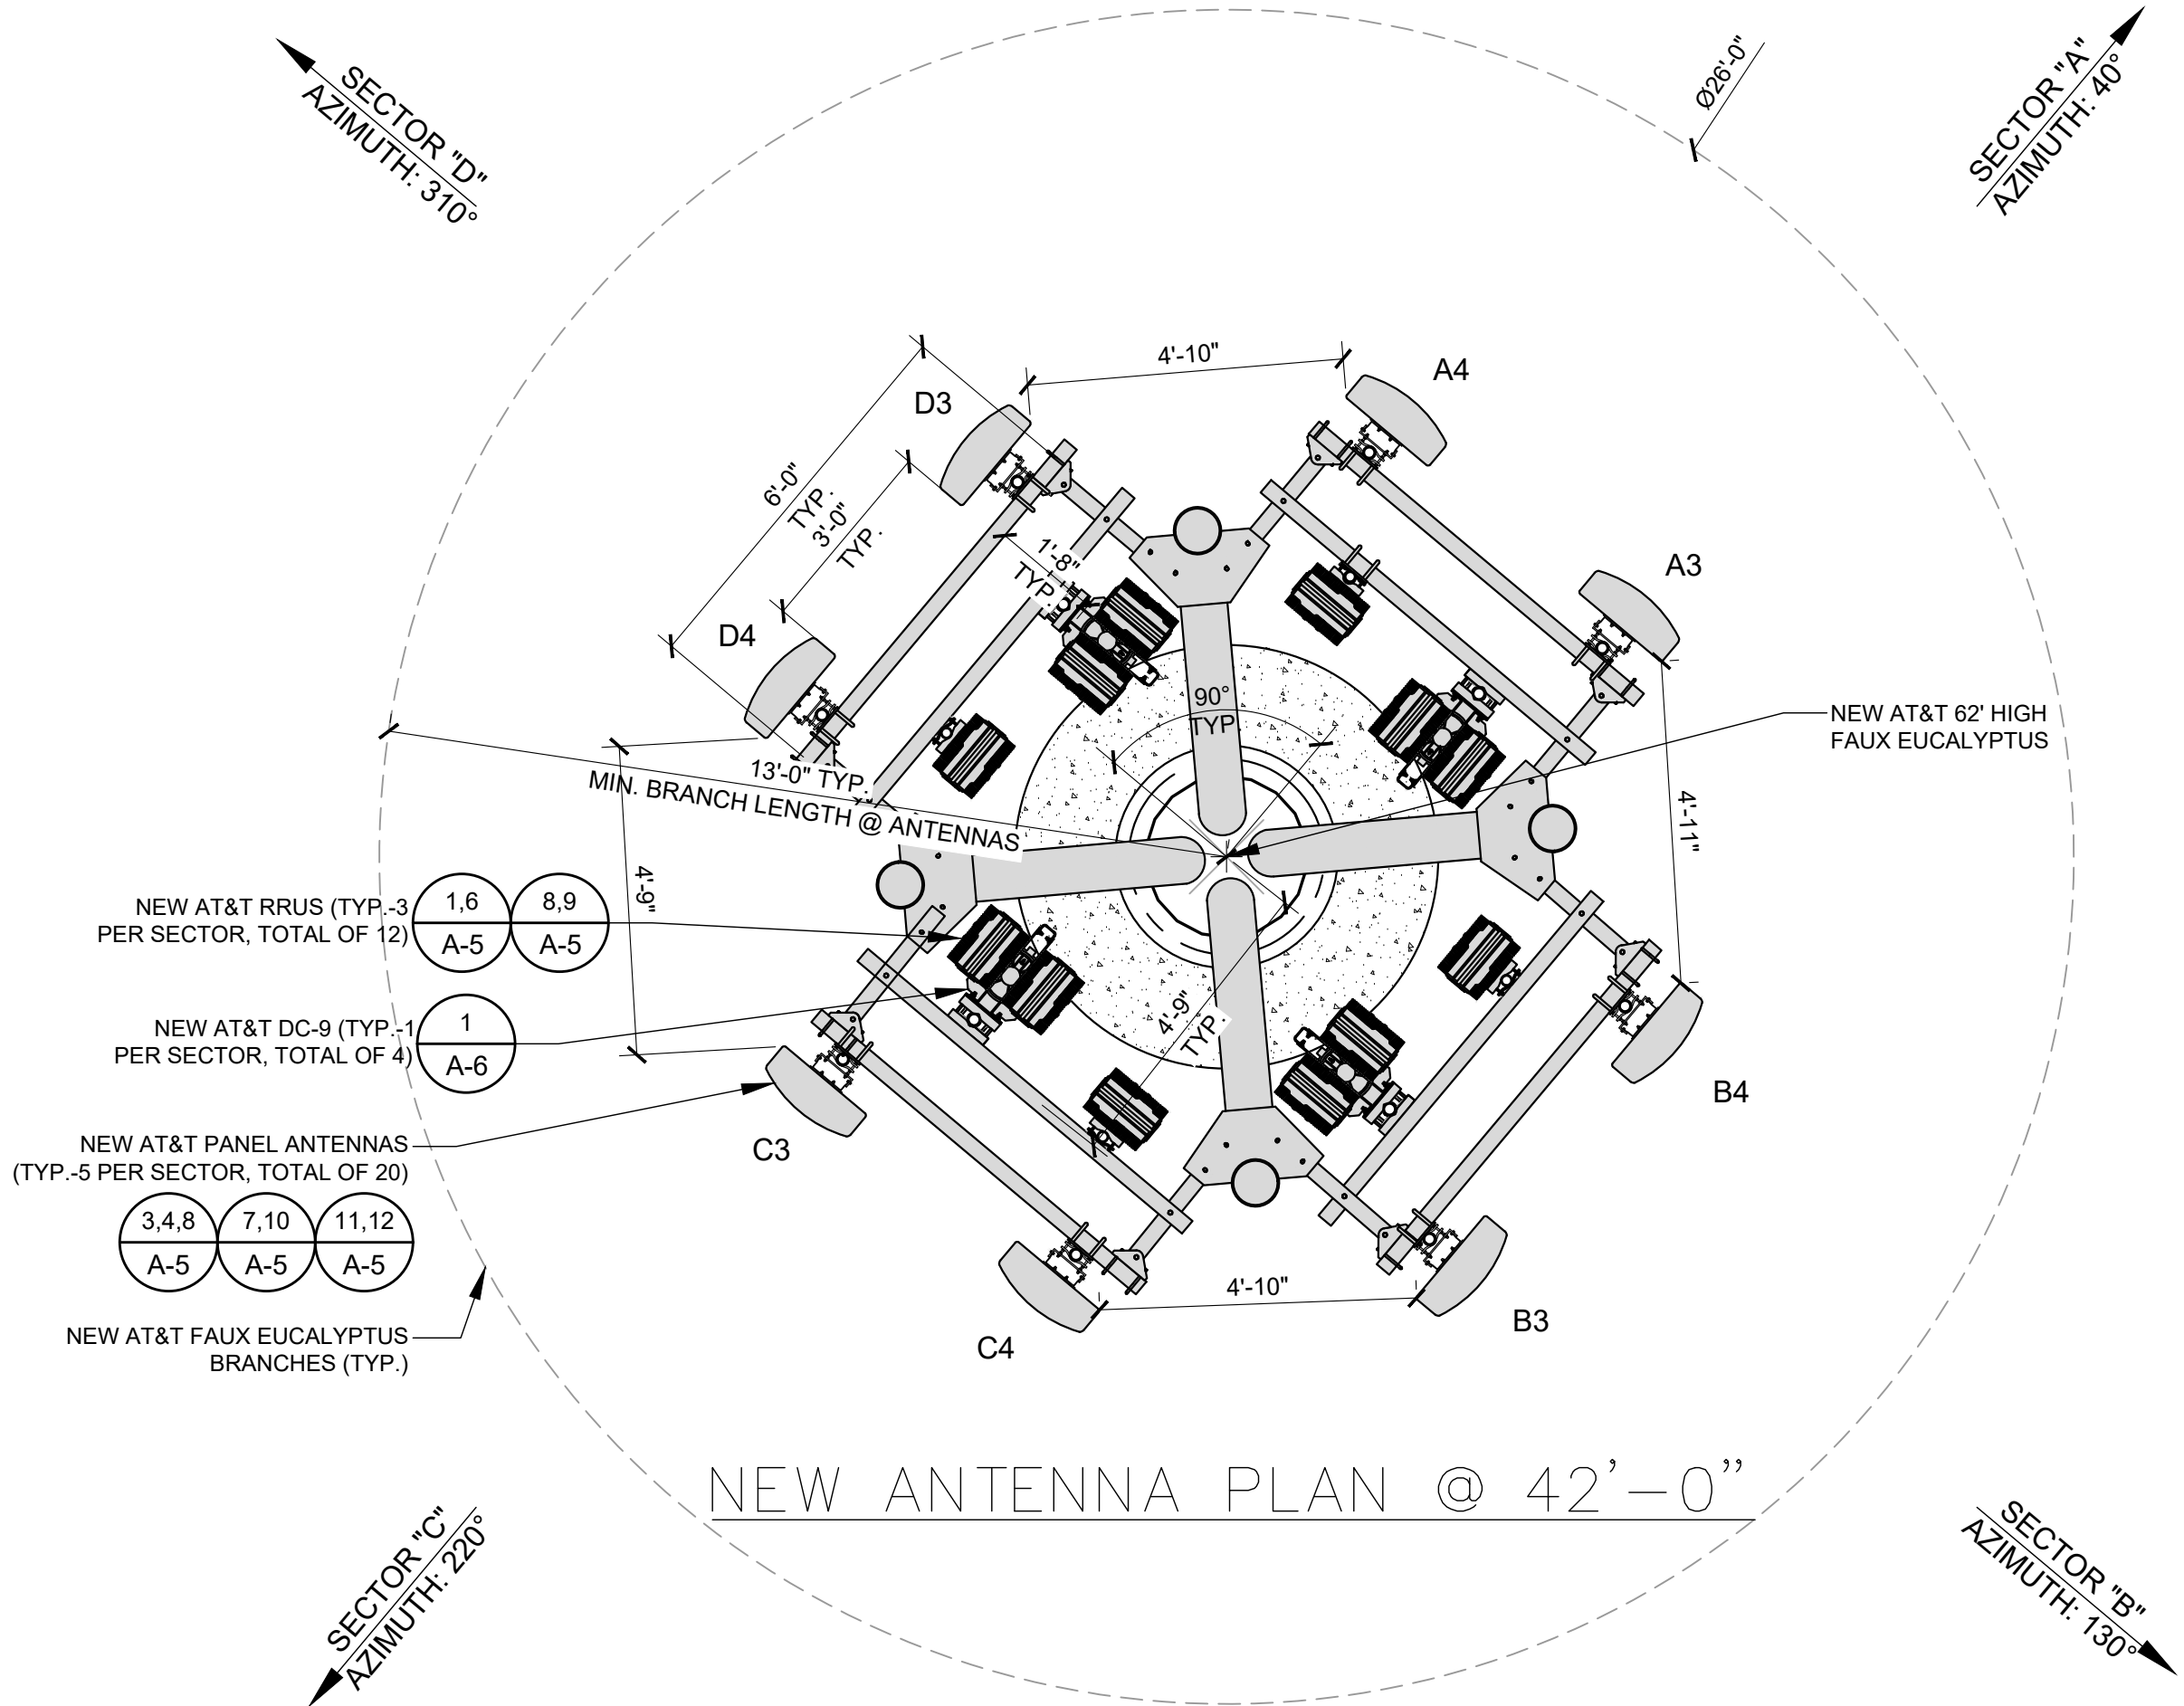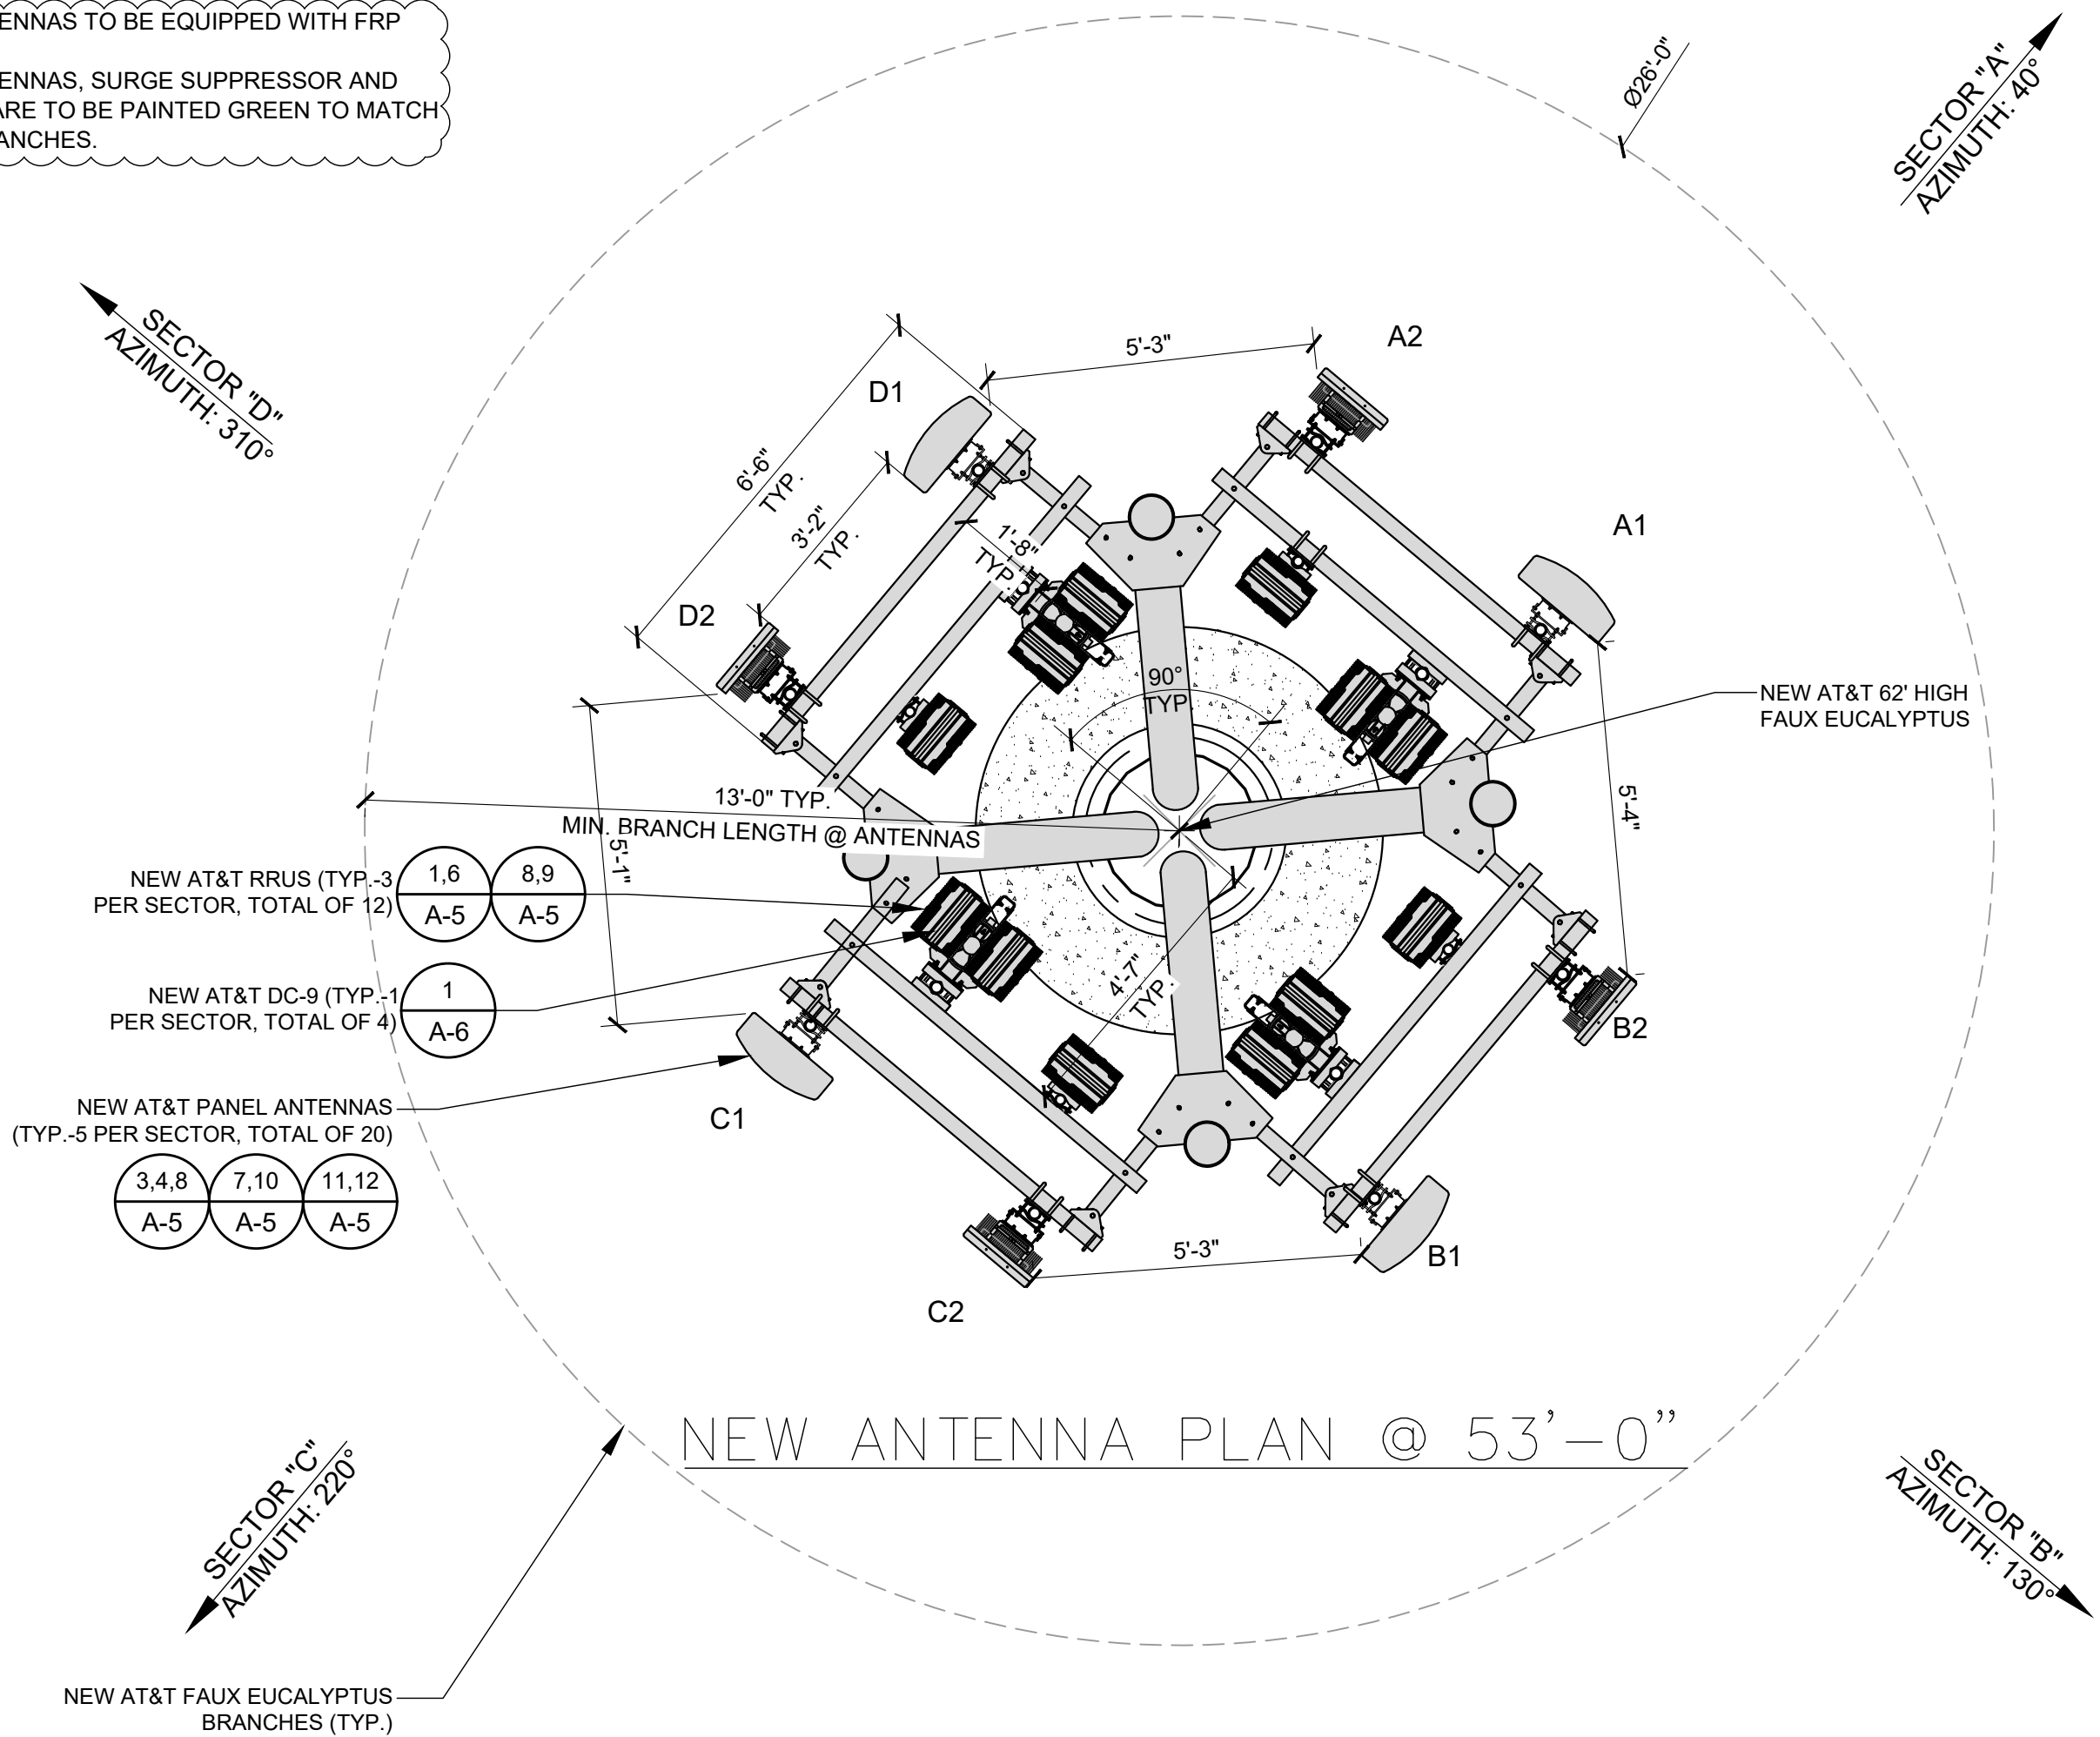

REMOTE RADIO UNIT SCHEDULE						
	SECTOR	RRU TYPE	RRU LOCATION (DISTANCE FROM ANTENNA)	MINIMUM CLEARANCES		
				ABOVE	BELOW	SIDES
ALPHA SECTOR	A1	ERICSSON RRU 4490 B5/B12A	±10'	16"	8"	0"
	A1	ERICSSON RRU 4890 B25/B66	±10'	16"	8"	0"
	A2	-	-	-	-	-
	A2	-	-	-	-	-
	A3	-	-	-	-	-
	A3	ERICSSON RRU 4494 B14/B29	±10'	16"	8"	0"
BETA SECTOR	B1	-	-	-	-	-
	B1	-	-	-	-	-
	B2	ERICSSON RRU 4490 B5/B12A	±10'	16"	8"	0"
	B2	ERICSSON RRU 4890 B25/B66	±10'	16"	8"	0"
	B3	-	-	-	-	-
	B3	-	-	-	-	-
GAMMA SECTOR	C1	ERICSSON RRU 4494 B14/B29	±10'	16"	8"	0"
	C1	ERICSSON RRU 4490 B5/B12A	±10'	16"	8"	0"
	C1	ERICSSON RRU 4890 B25/B66	±10'	16"	8"	0"
	C2	-	-	-	-	-
	C2	-	-	-	-	-
	C3	ERICSSON RRU 4494 B14/B29	±10'	16"	8"	0"
DELTA SECTOR	D1	-	-	-	-	-
	D1	-	-	-	-	-
	D2	ERICSSON RRU 4490 B5/B12A	±10'	16"	8"	0"
	D2	ERICSSON RRU 4890 B25/B66	±10'	16"	8"	0"
	D3	-	-	-	-	-
	D3	-	-	-	-	-
	D4	-	-	-	-	-
	D4	ERICSSON RRU 4494 B14/B29	±10'	16"	8"	0"

SURGE SUPPRESSION SYSTEM				
SYSTEM	MANUFACTURER	PART NUMBER	QTY	LOCATION
	RAYCAP	DC50-48-60-96-50F	1	MOUNTED INSIDE CMU WALL ENCLOSURE
	RAYCAP	DC9-48-60-24-8C-EV	4	MOUNTED AT FAUX EUCALYPTUS TOWER



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DRAWN BY:	UTILITIES CHECKED BY:	A&E CHECKED BY:
DW/AS	GD	RB

CONSTRUCTION
DRAWINGS

SUBMITTALS		
REV	DATE	DESCRIPTION
A	04/26/24	90% CONSTRUCTION DRAWINGS
B	08/29/24	JX COMMENTS
0	03/12/24	100% CONSTRUCTION DRAWINGS

PROJECT INFORMATION

CLL05463

1700 N. TOWNE AVE.
CLAREMONT, CA 91711

SHEET TITLE


ANTENNA PLAN AND
RRU SCHEDULE

SHEET NUMBER



A-3

- NOTES:
1. TOWER TO BE PAINTED AND TEXTURED TO MATCH EXISTING BUILDING.
 2. PER CITY REQUIREMENT, ALL ARCHITECTURE FEATURES TO TIE INTO EXISTING CHURCH BUILDING AND WILL NOT HOUSE ANY EQUIPMENT.
 3. ALL ANTENNAS TO BE EQUIPPED WITH FRP SOCKS.
 4. ALL ANTENNAS, SURGE SUPPRESSOR AND HARDWARE TO BE PAINTED GREEN TO MATCH NEW BRANCHES.


- NOTES:
1. PROPOSED TREES 5 GAL. SEE LANDSCAPING PLANS FOR ALTERNATIVE.

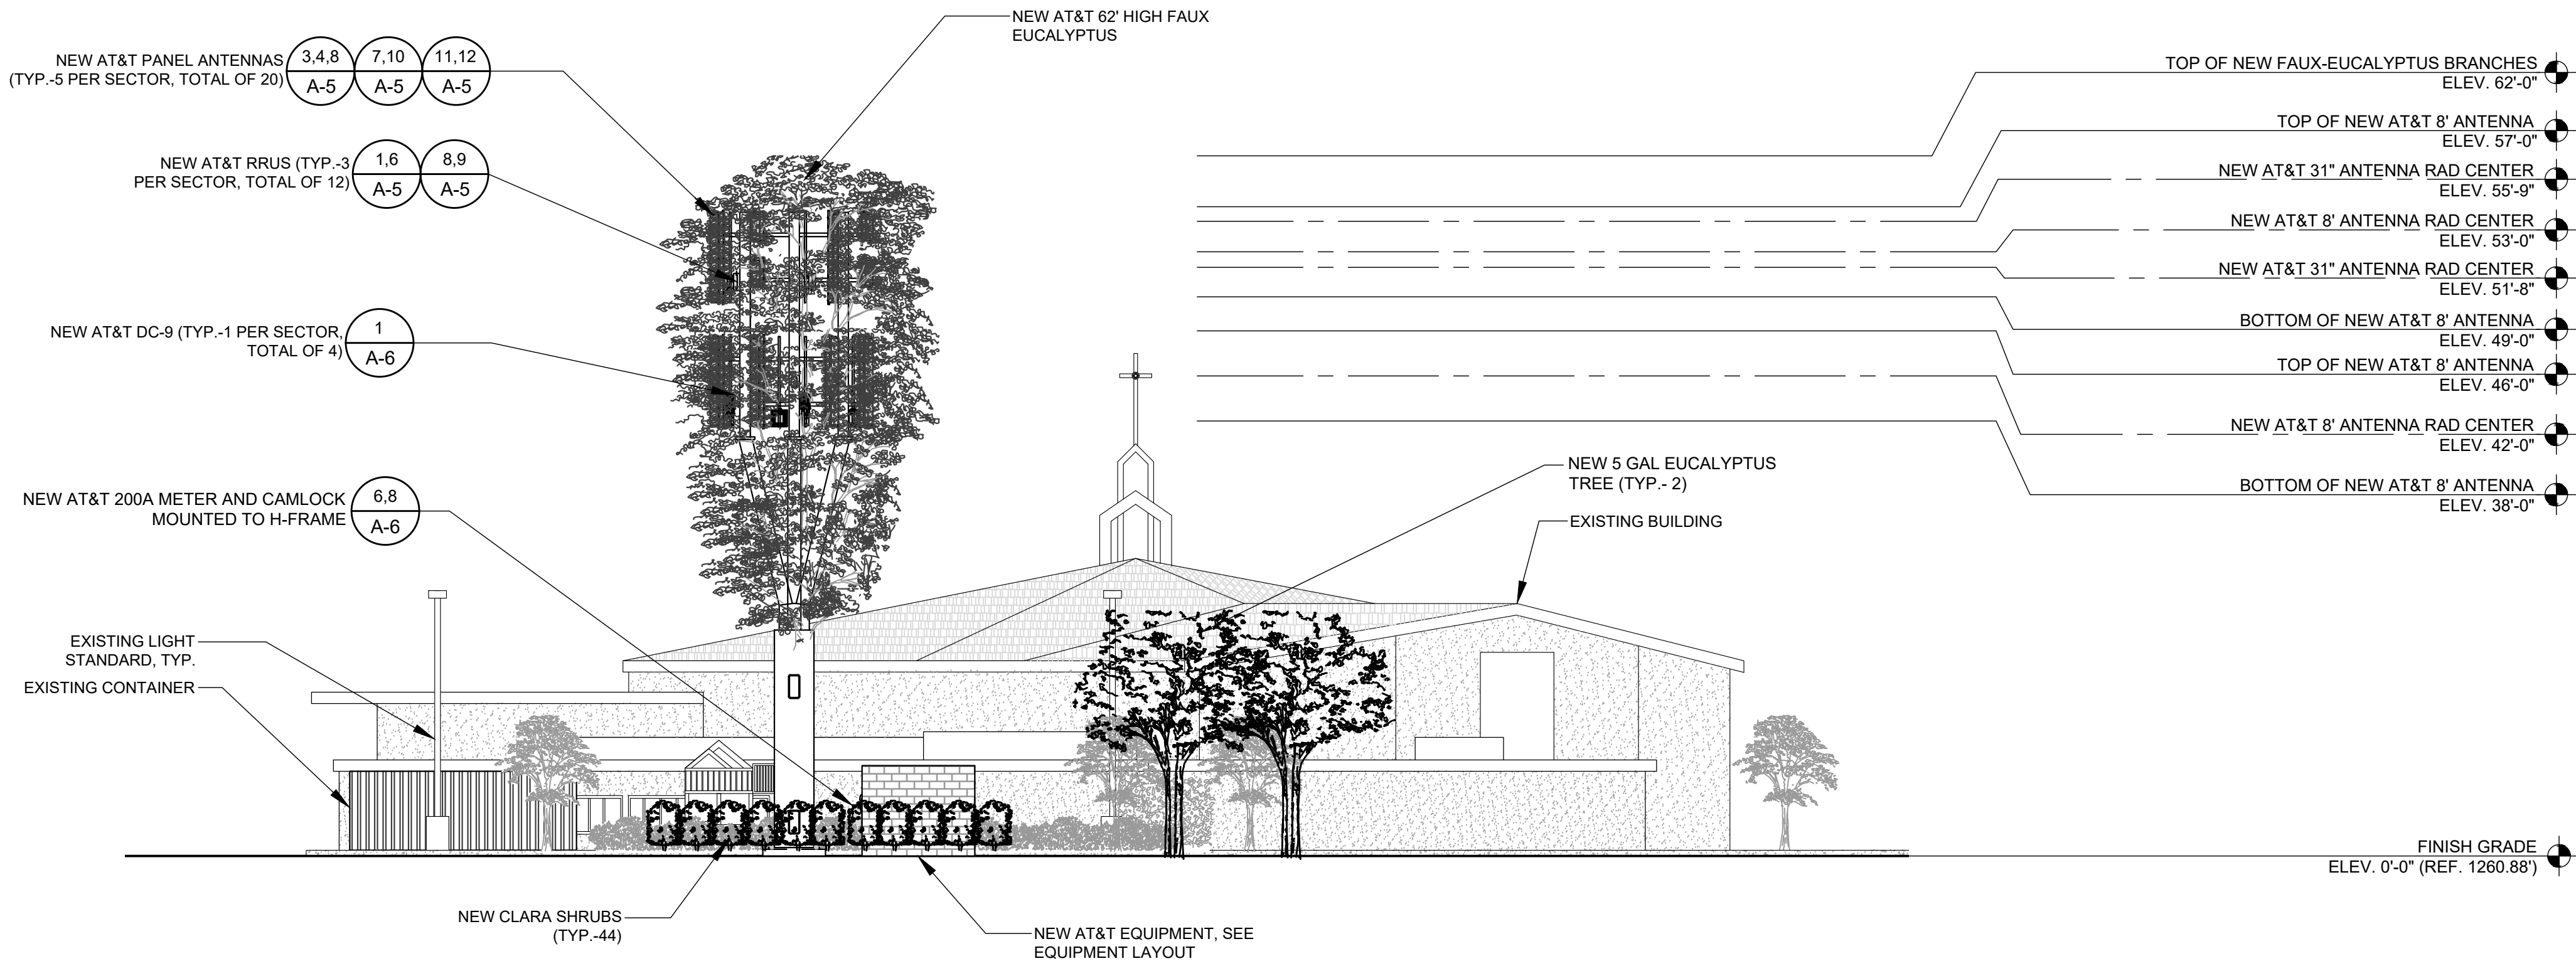

NEW EAST ELEVATION

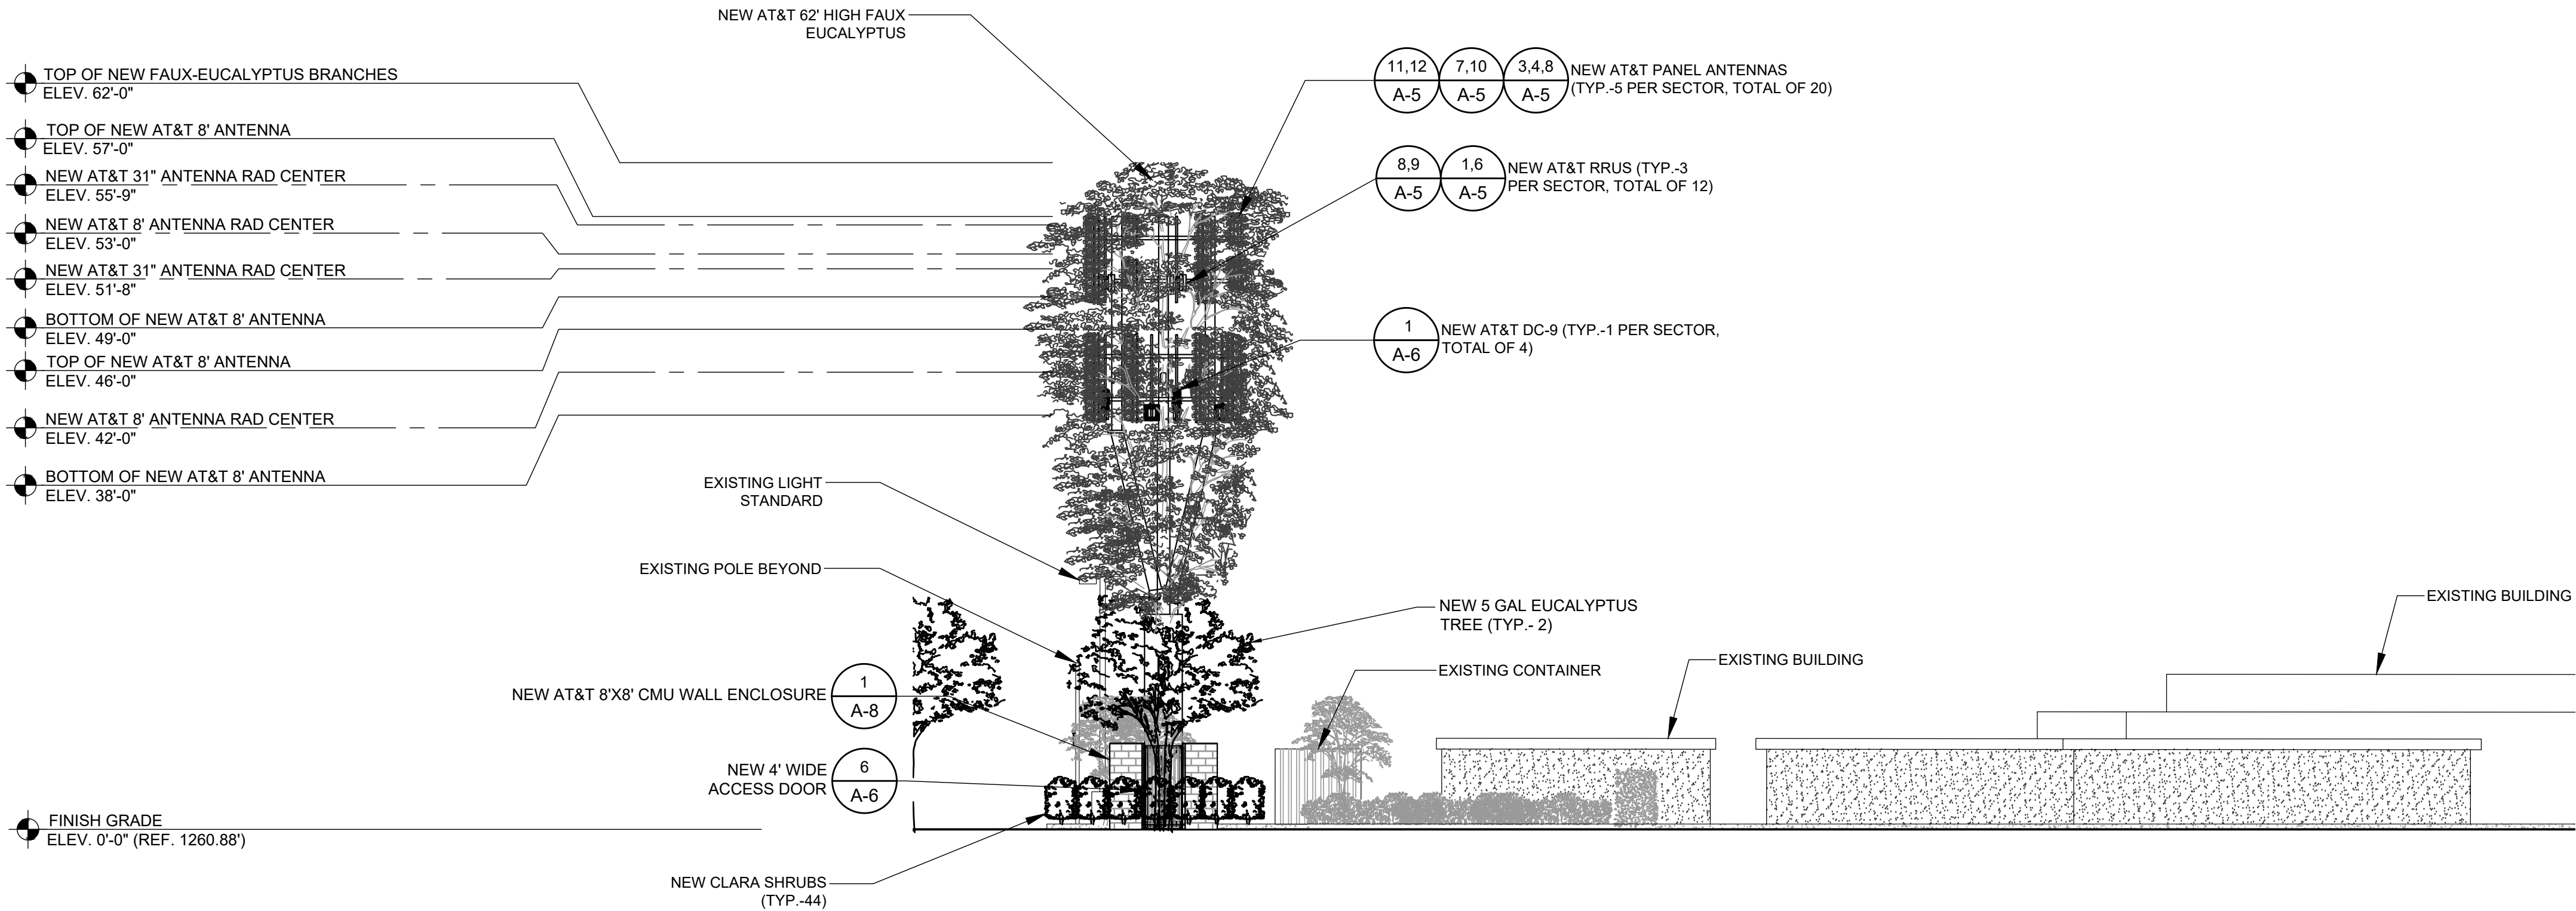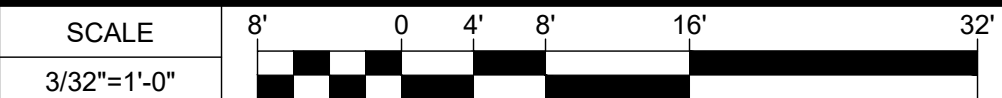

NEW NORTH ELEVATION

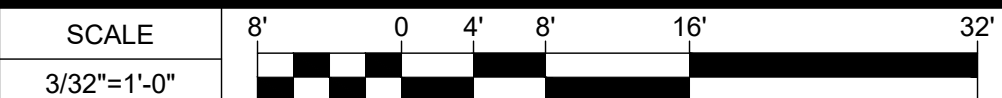

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DRAWN BY:	UTILITIES CHECKED BY:	A&E CHECKED BY:
DW/AS	GD	RB

CONSTRUCTION DRAWINGS

SUBMITTALS		
REV	DATE	DESCRIPTION
A	04/26/24	90% CONSTRUCTION DRAWINGS
B	08/29/24	JX COMMENTS
0	03/12/24	100% CONSTRUCTION DRAWINGS

PROJECT INFORMATION

CLL05463

1700 N. TOWNE AVE.
CLAREMONT, CA 91711

SHEET TITLE NEW EAST AND NORTH ELEVATIONS

SHEET NUMBER

A-4

- NOTES:
1. TOWER TO BE PAINTED AND TEXTURED TO MATCH EXISTING BUILDING.
 2. PER CITY REQUIREMENT, ALL ARCHITECTURE FEATURES TO TIE INTO EXISTING CHURCH BUILDING AND WILL NOT HOUSE ANY EQUIPMENT.
 3. ALL ANTENNAS TO BE EQUIPPED WITH FRP SOCKS.
 4. ALL ANTENNAS, SURGE SUPPRESSOR AND HARDWARE TO BE PAINTED GREEN TO MATCH NEW BRANCHES.

- NOTES:
1. PROPOSED TREES 5 GAL. SEE LANDSCAPING PLANS FOR ALTERNATIVE.



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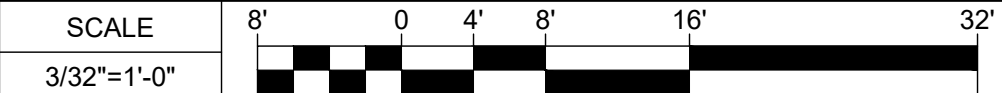


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NEW SOUTH ELEVATION



2

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DW/AS	GD	RB


CONSTRUCTION
DRAWINGS

SUBMITTALS		
REV	DATE	DESCRIPTION
A	04/26/24	90% CONSTRUCTION DRAWINGS
B	08/29/24	JX COMMENTS
0	03/12/24	100% CONSTRUCTION DRAWINGS


PROJECT INFORMATION	
CLL05463	
1700 N. TOWNE AVE. CLAREMONT, CA 91711	

SHEET TITLE	
NEW WEST AND SOUTH ELEVATIONS	


SHEET NUMBER	
A-4.1	

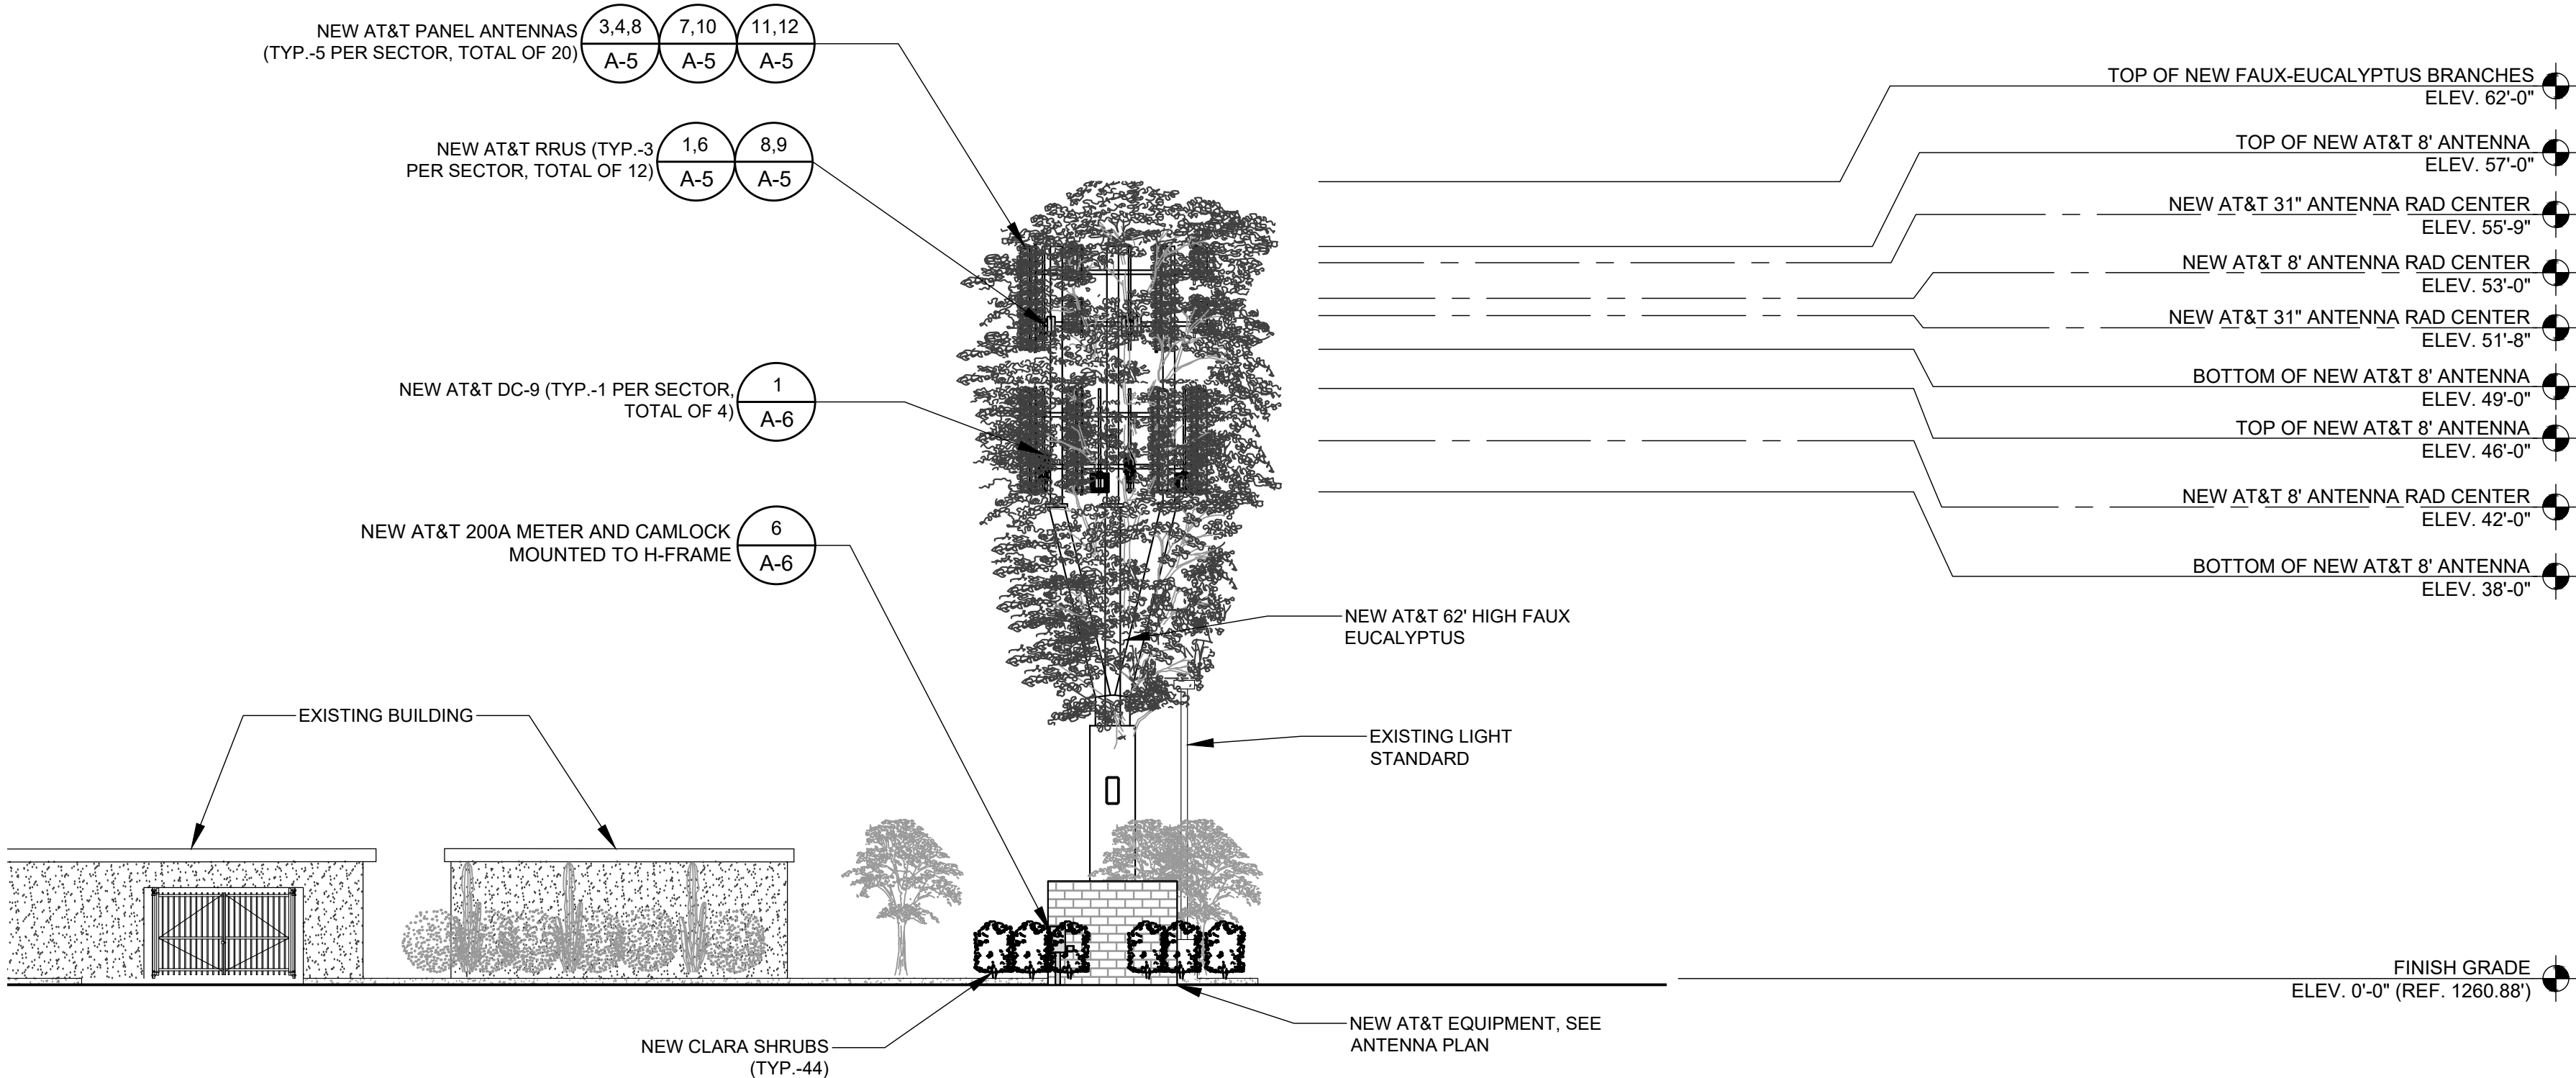

NEW WEST ELEVATION

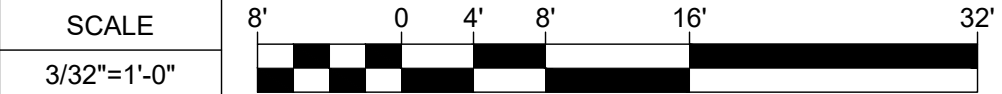

1

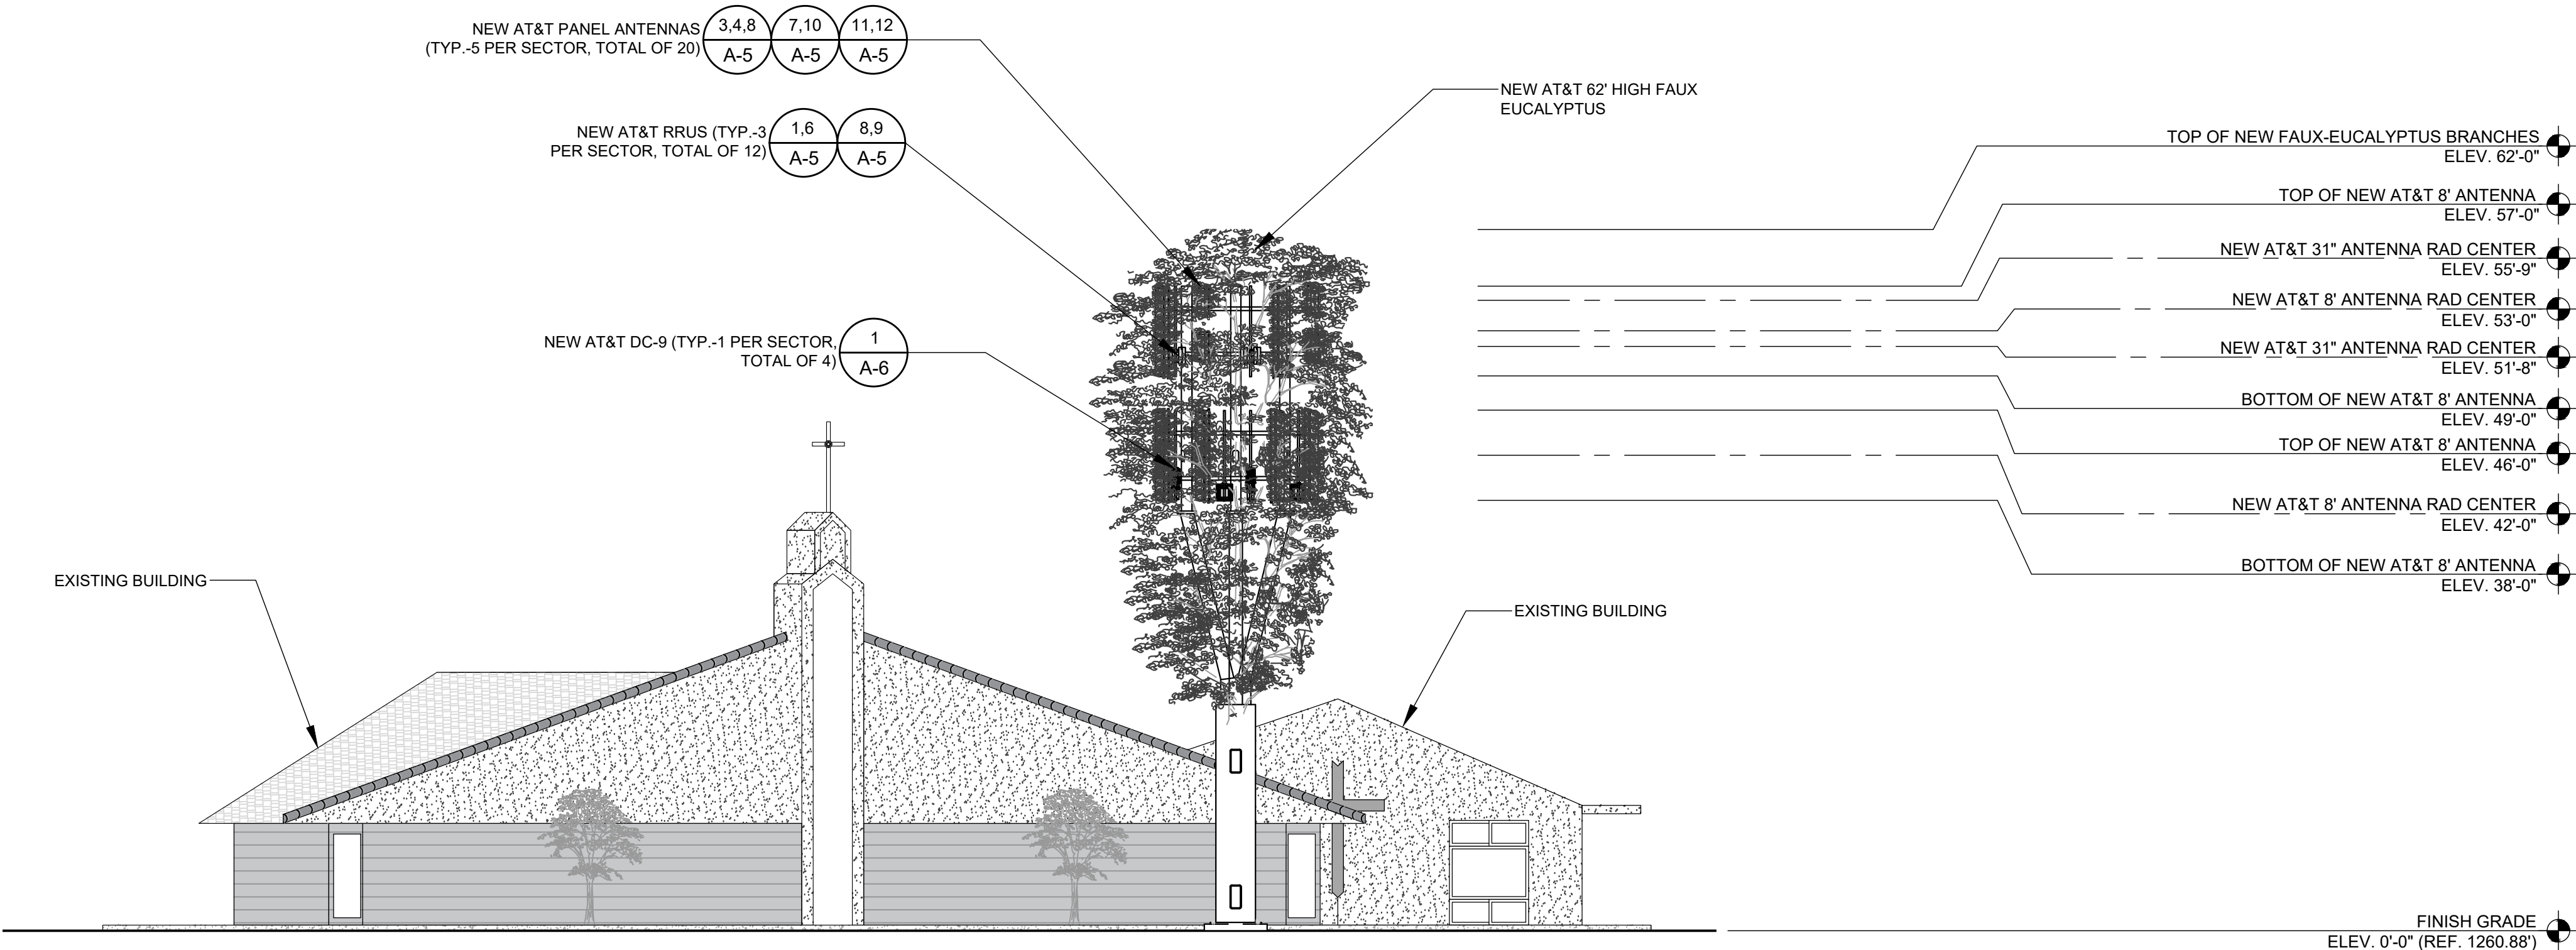


EUKON AT&T 90C0D MONOPOLE TEMPLATE V2 11-18-22

NOT USED

SCALE

NONE

11

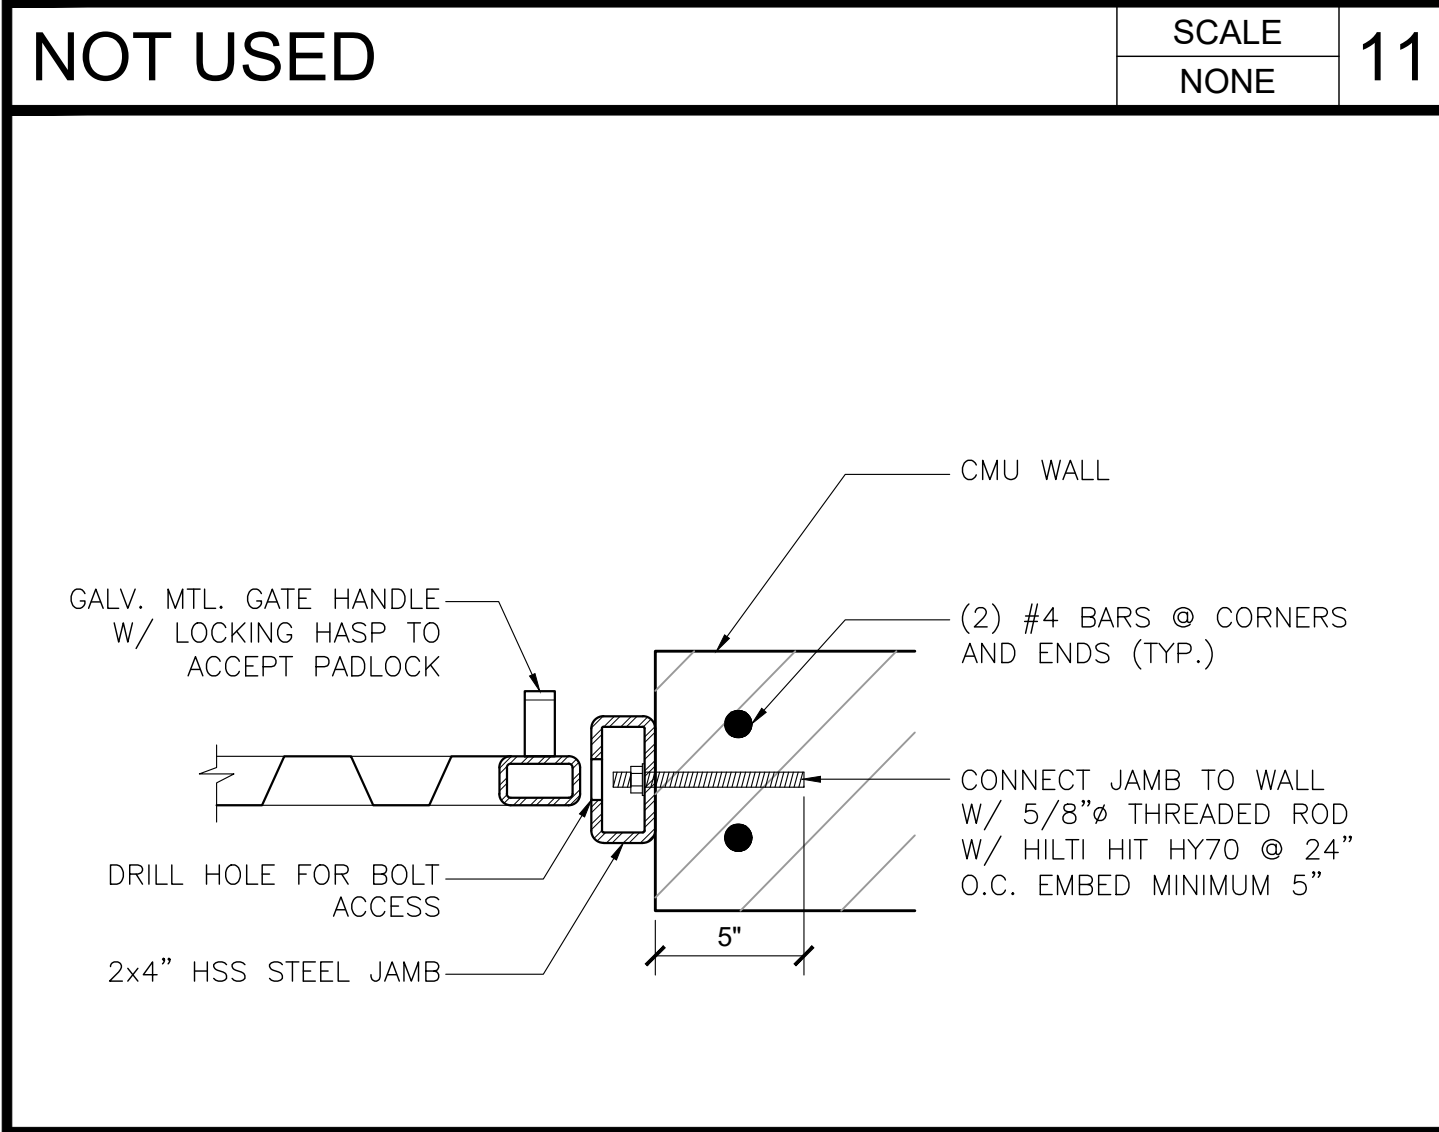


STEEL GATE FRAME TO CMU

SCALE

NONE

10

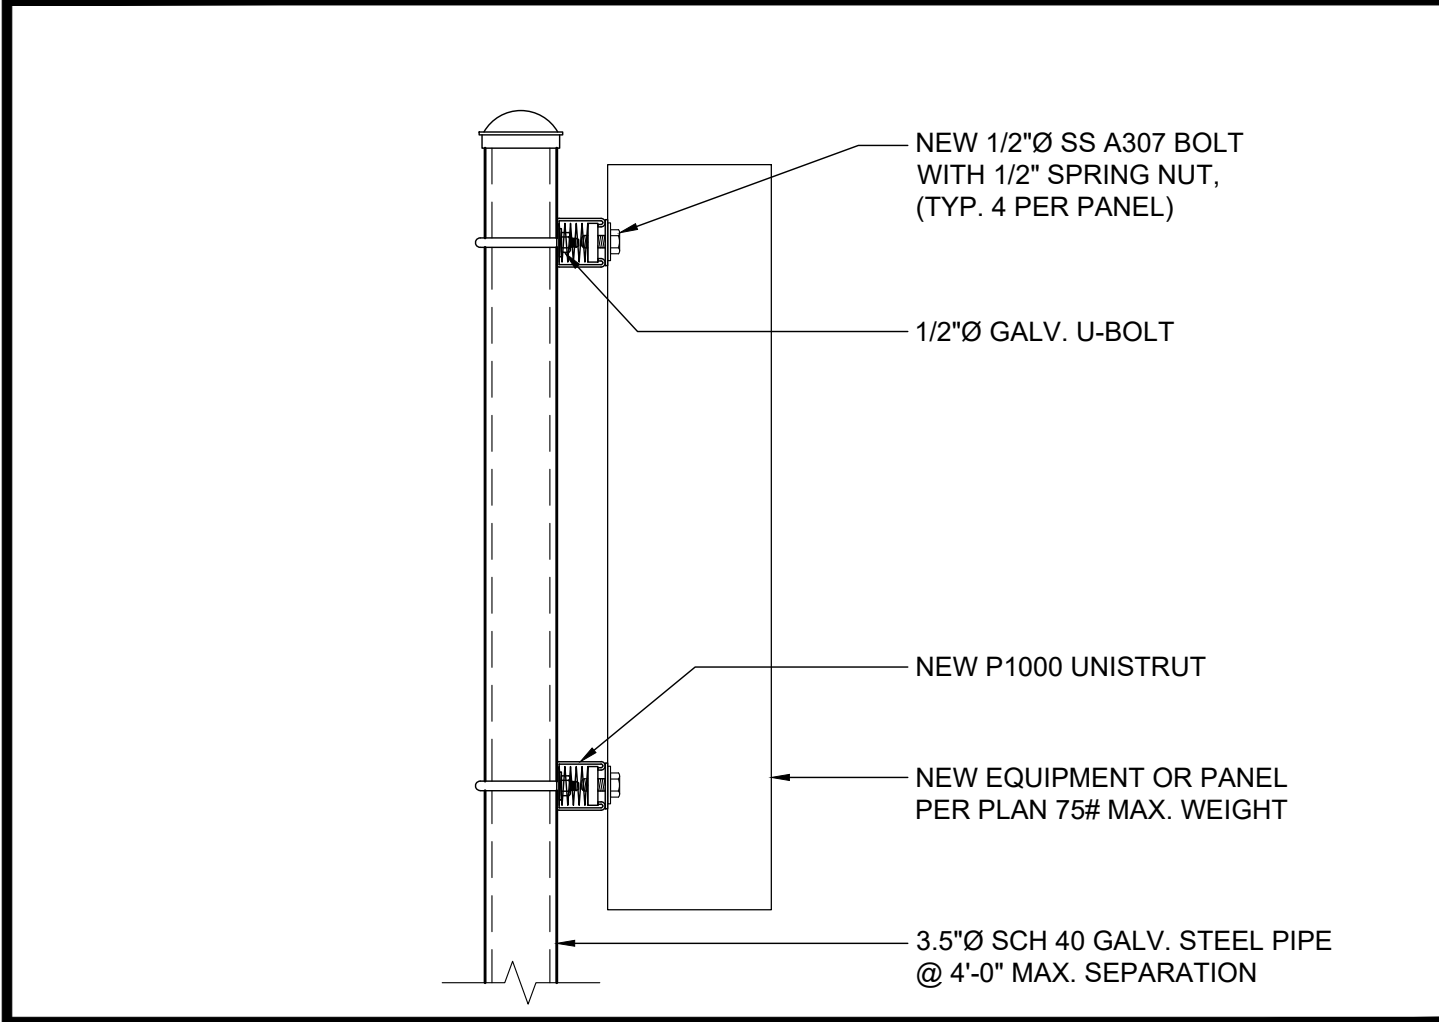


PANEL TO H-FRAME

SCALE

NONE

9

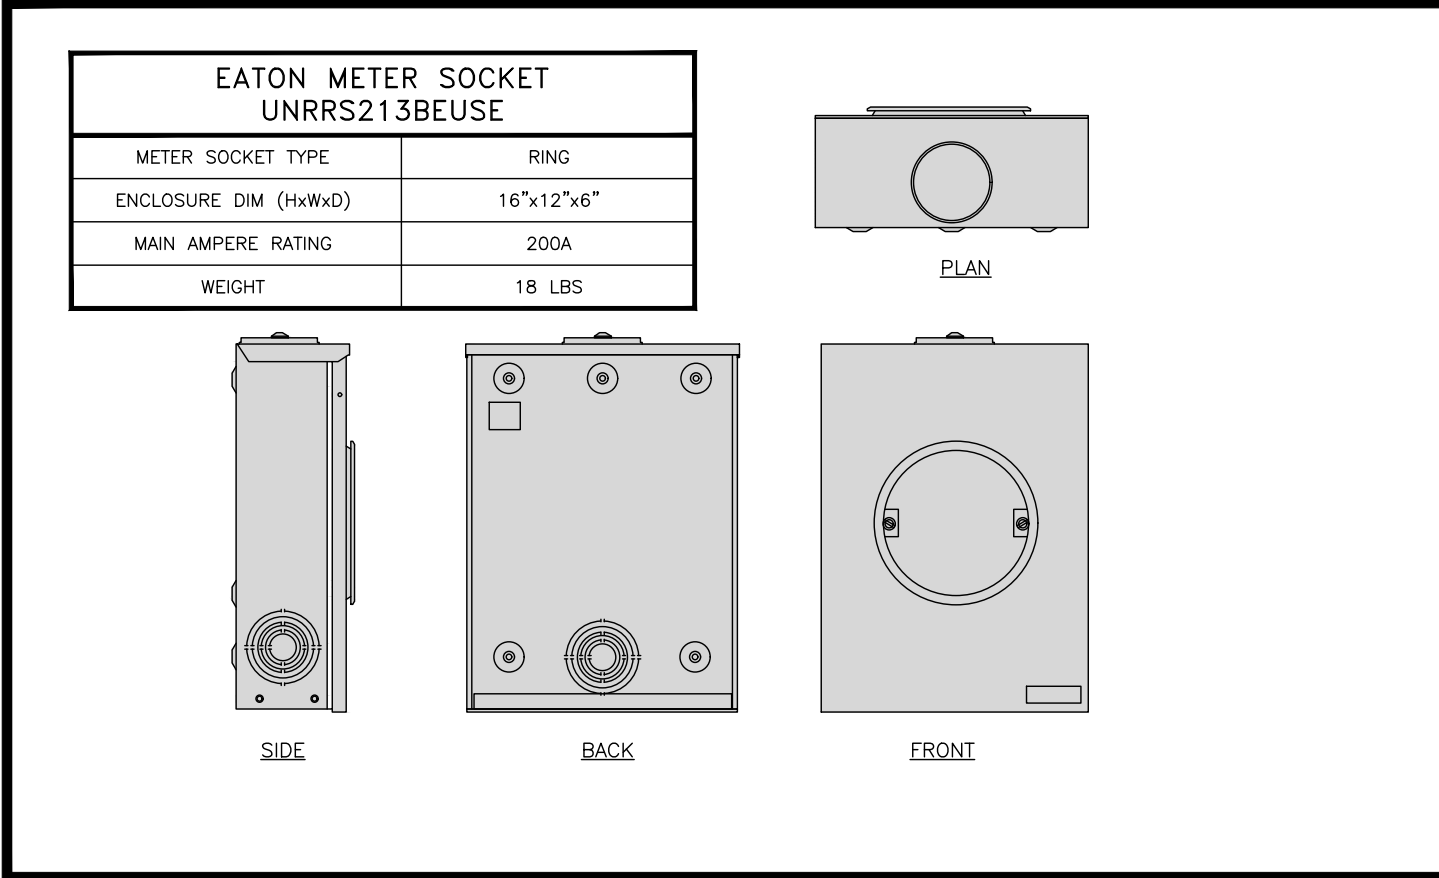


200A METER SPECS

SCALE

NONE

8

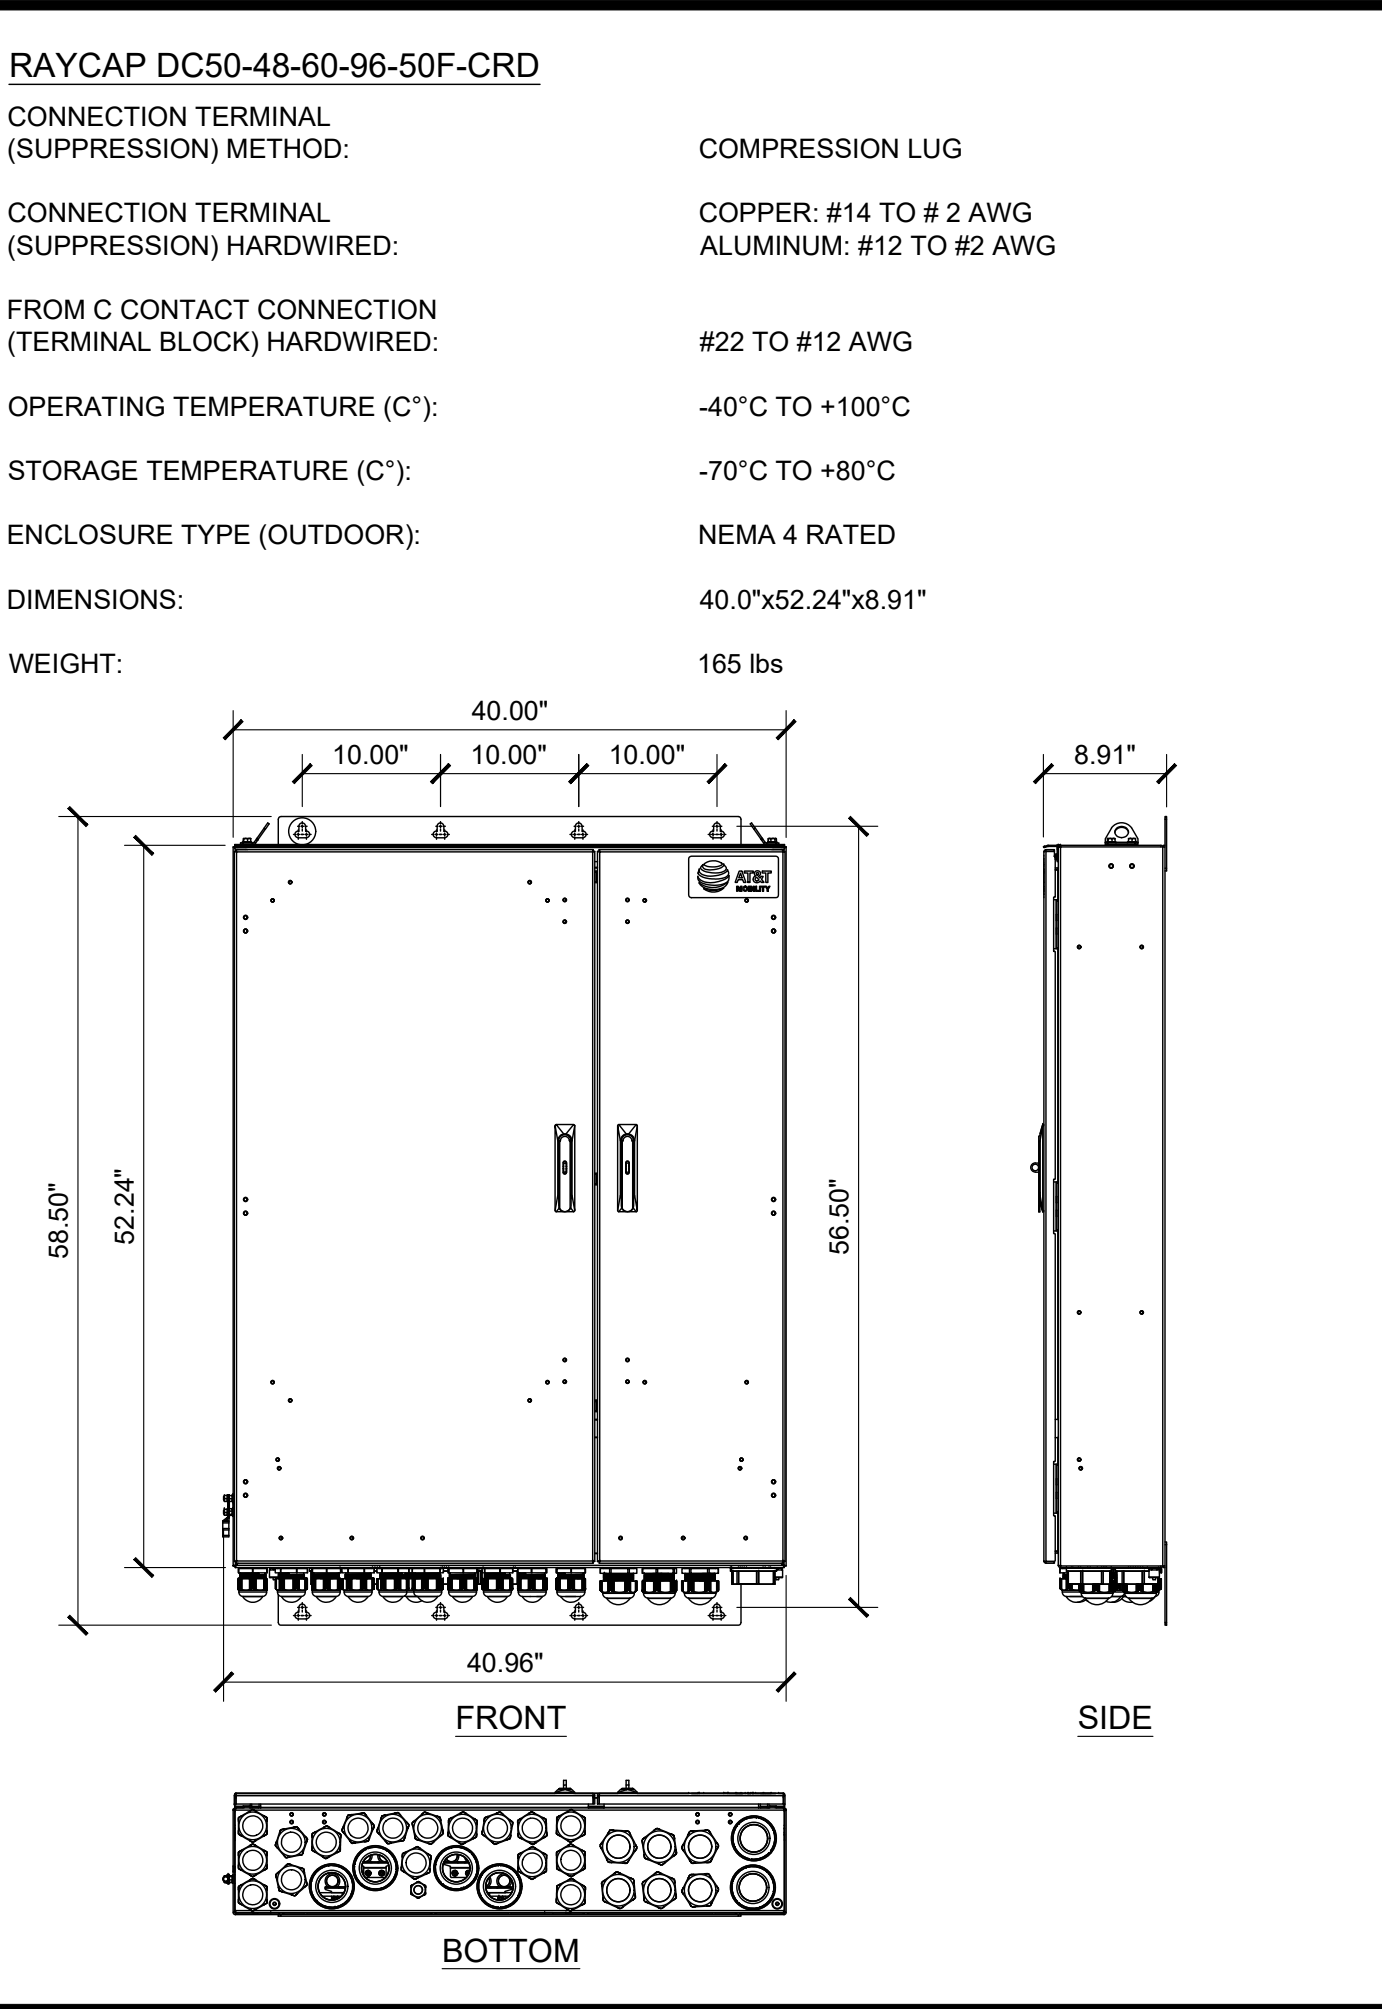


SURGE SUPPRESSOR SPEC

SCALE

NONE

7

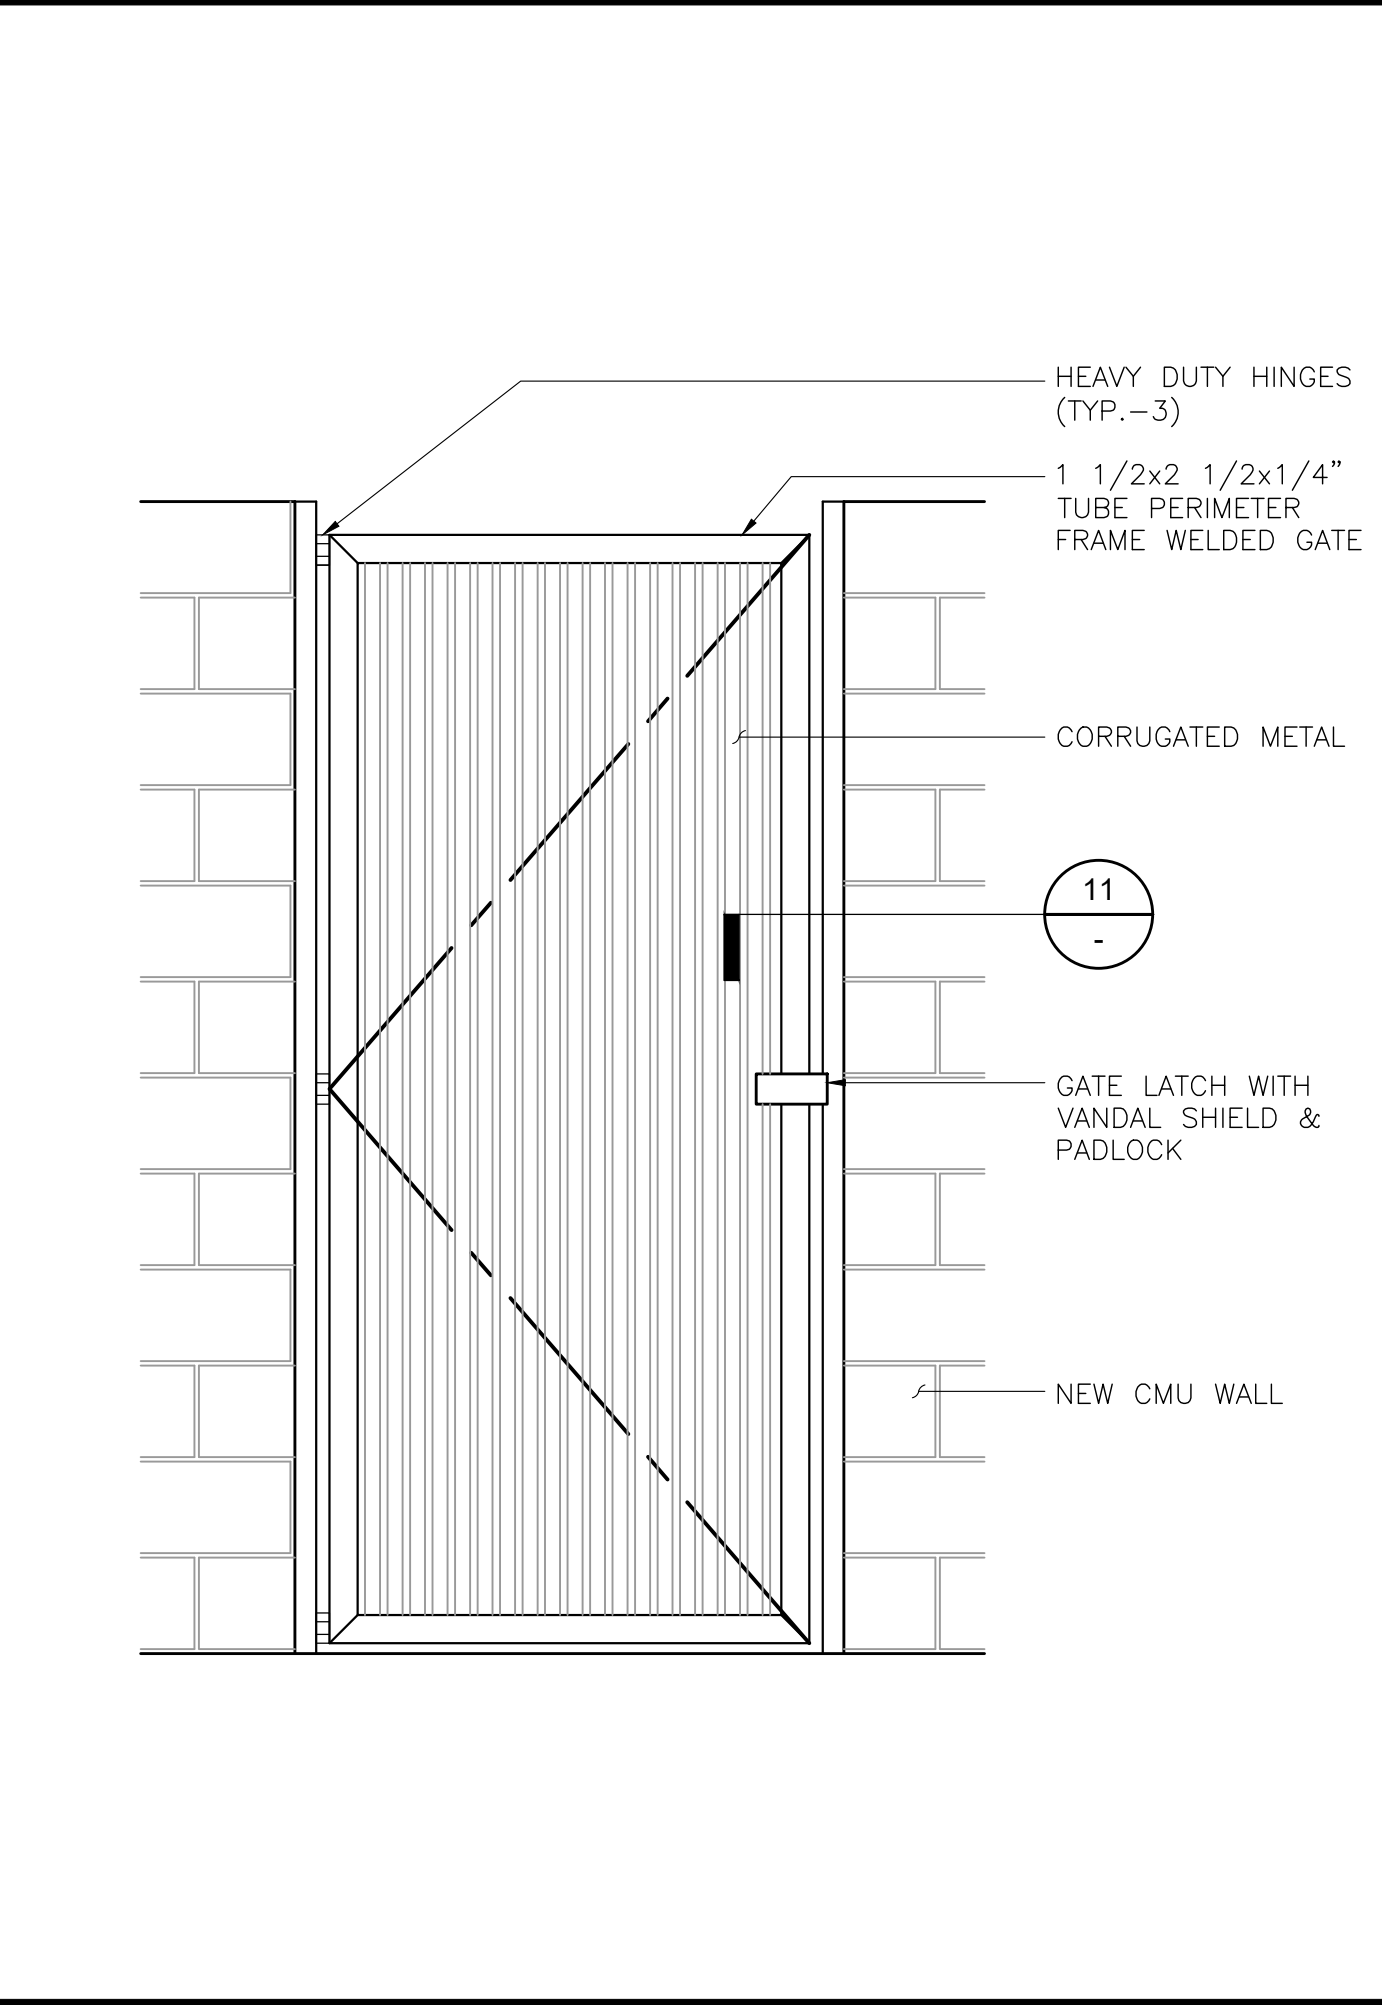


STEEL GATE AT CMU WALL

SCALE

NONE

6

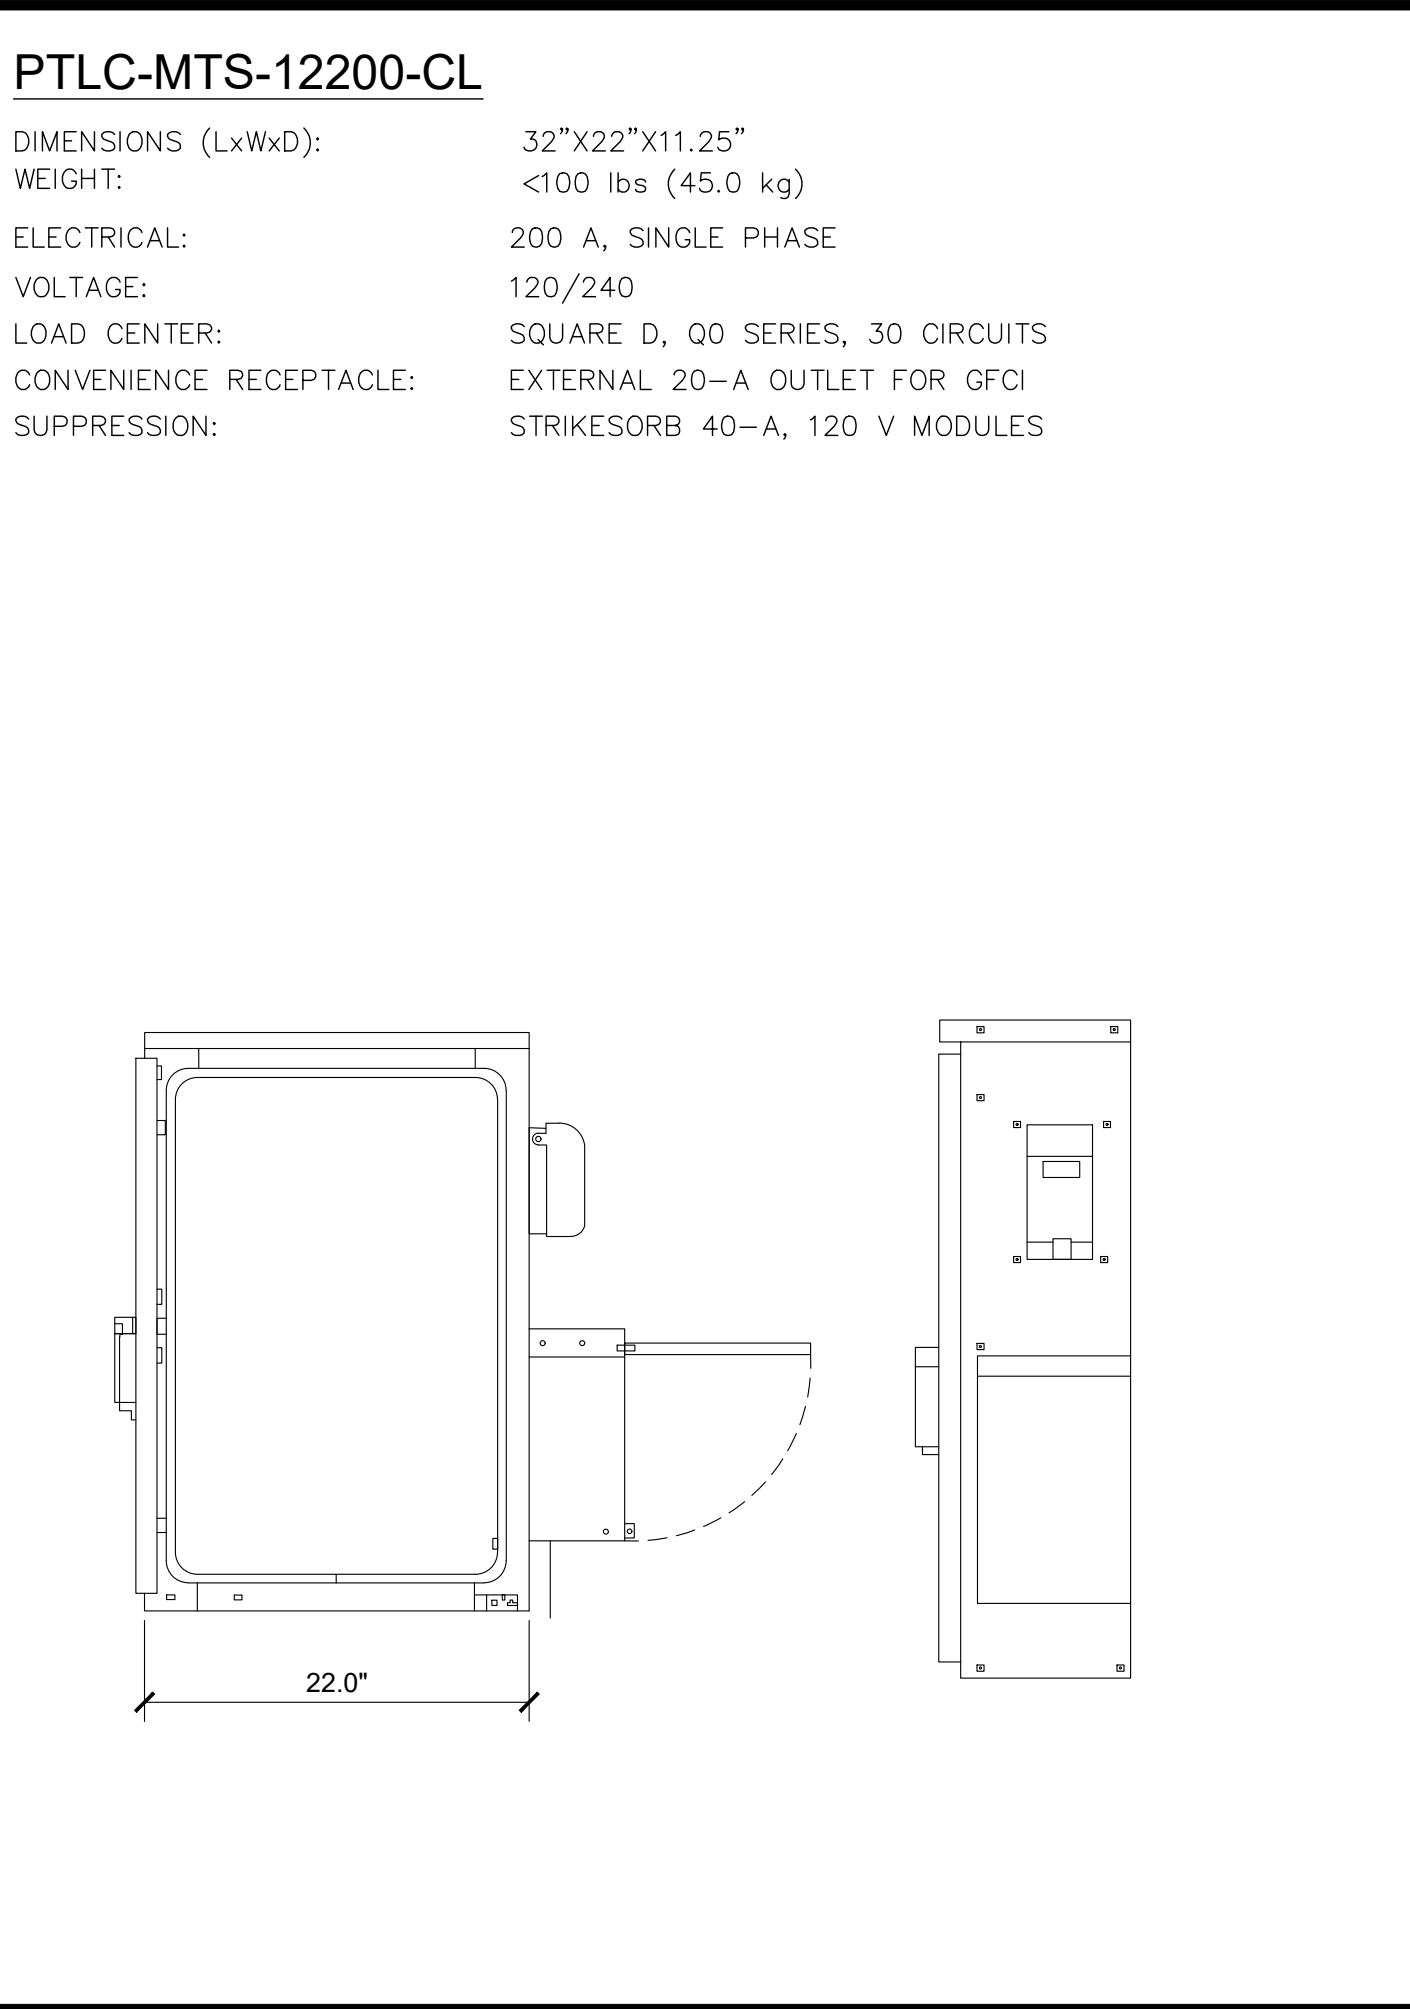


ELECTRICAL PANEL SPEC

SCALE

NONE

5

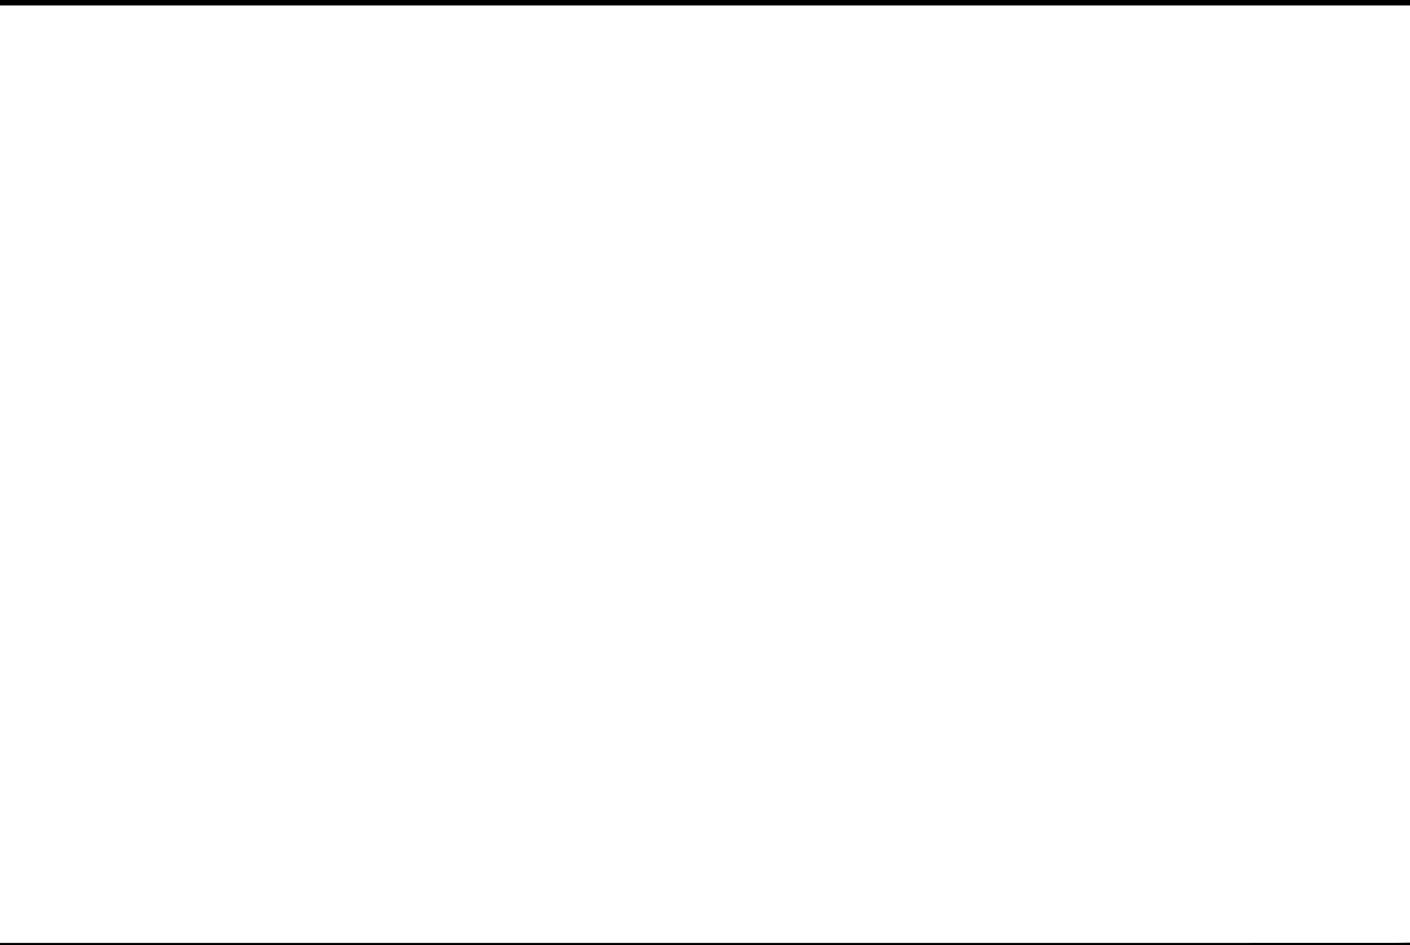

NOT USED

SCALE

NONE

5




TELCO BOX DETAIL

SCALE

NONE

4

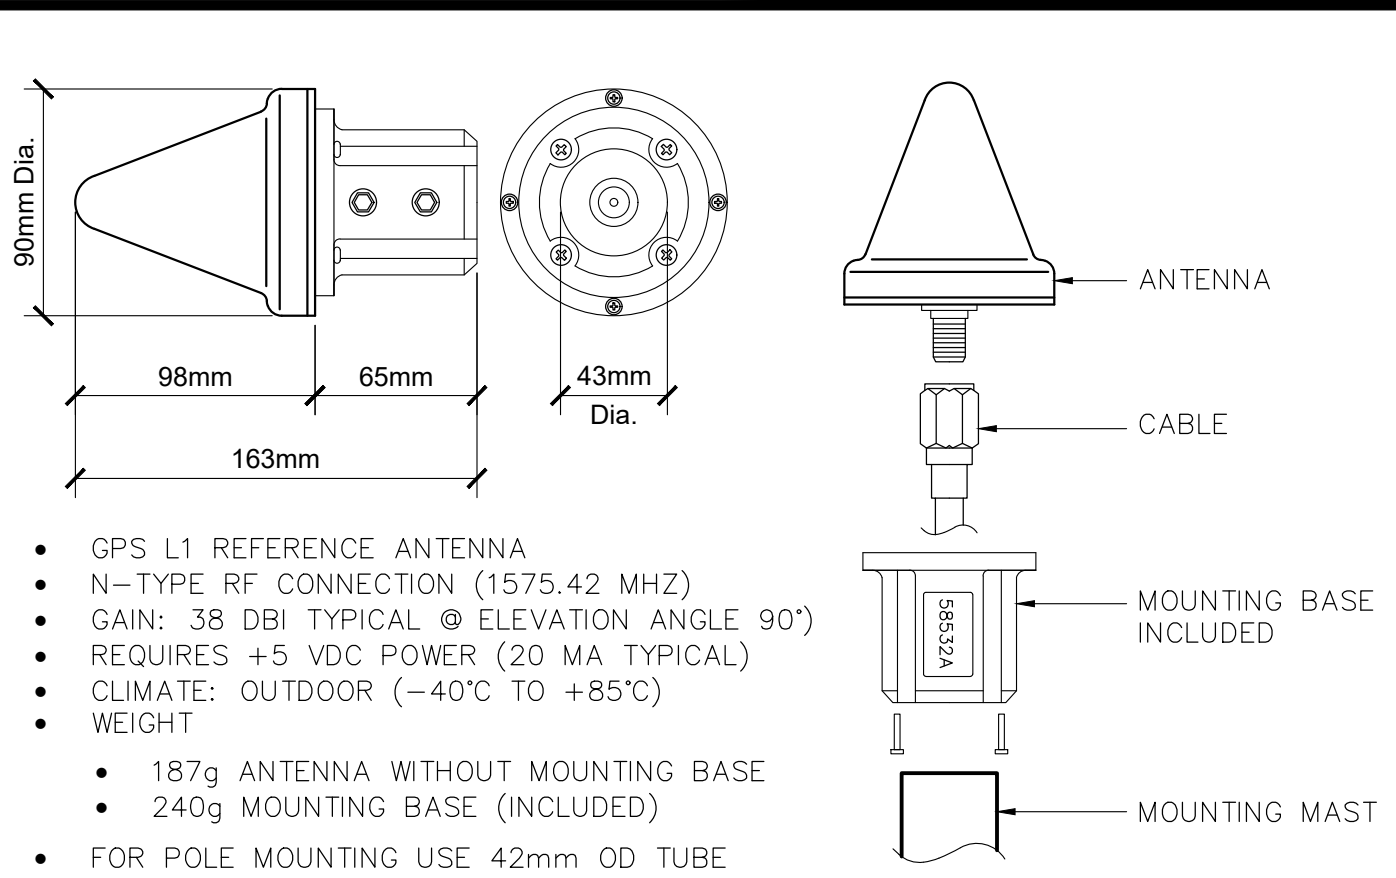


GPS ANTENNA SPEC

SCALE

NONE

3

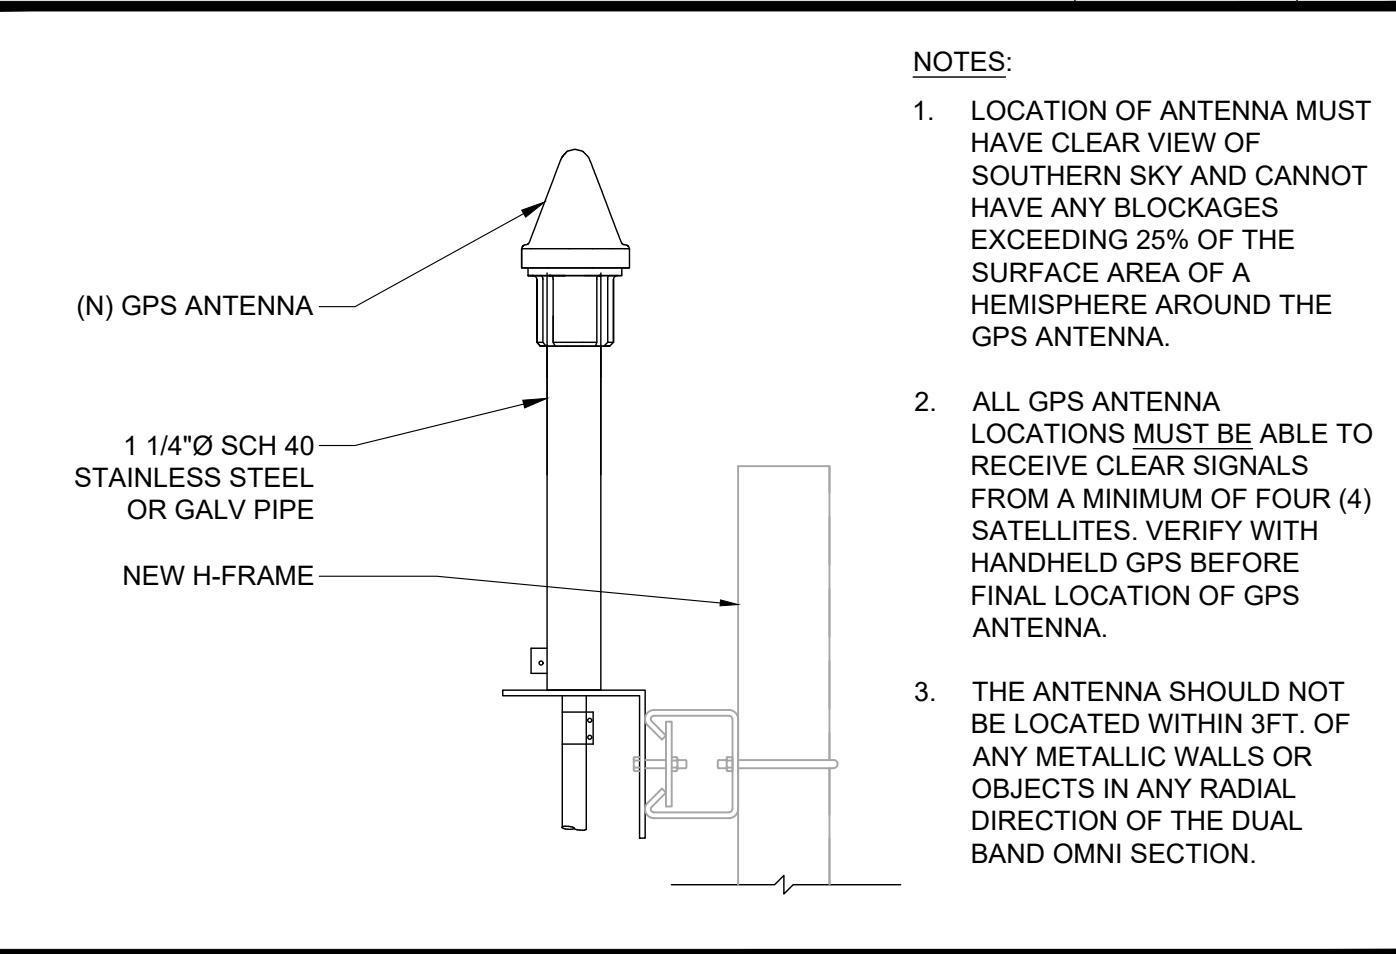


GPS ANTENNA MOUNTING

SCALE

NONE

2

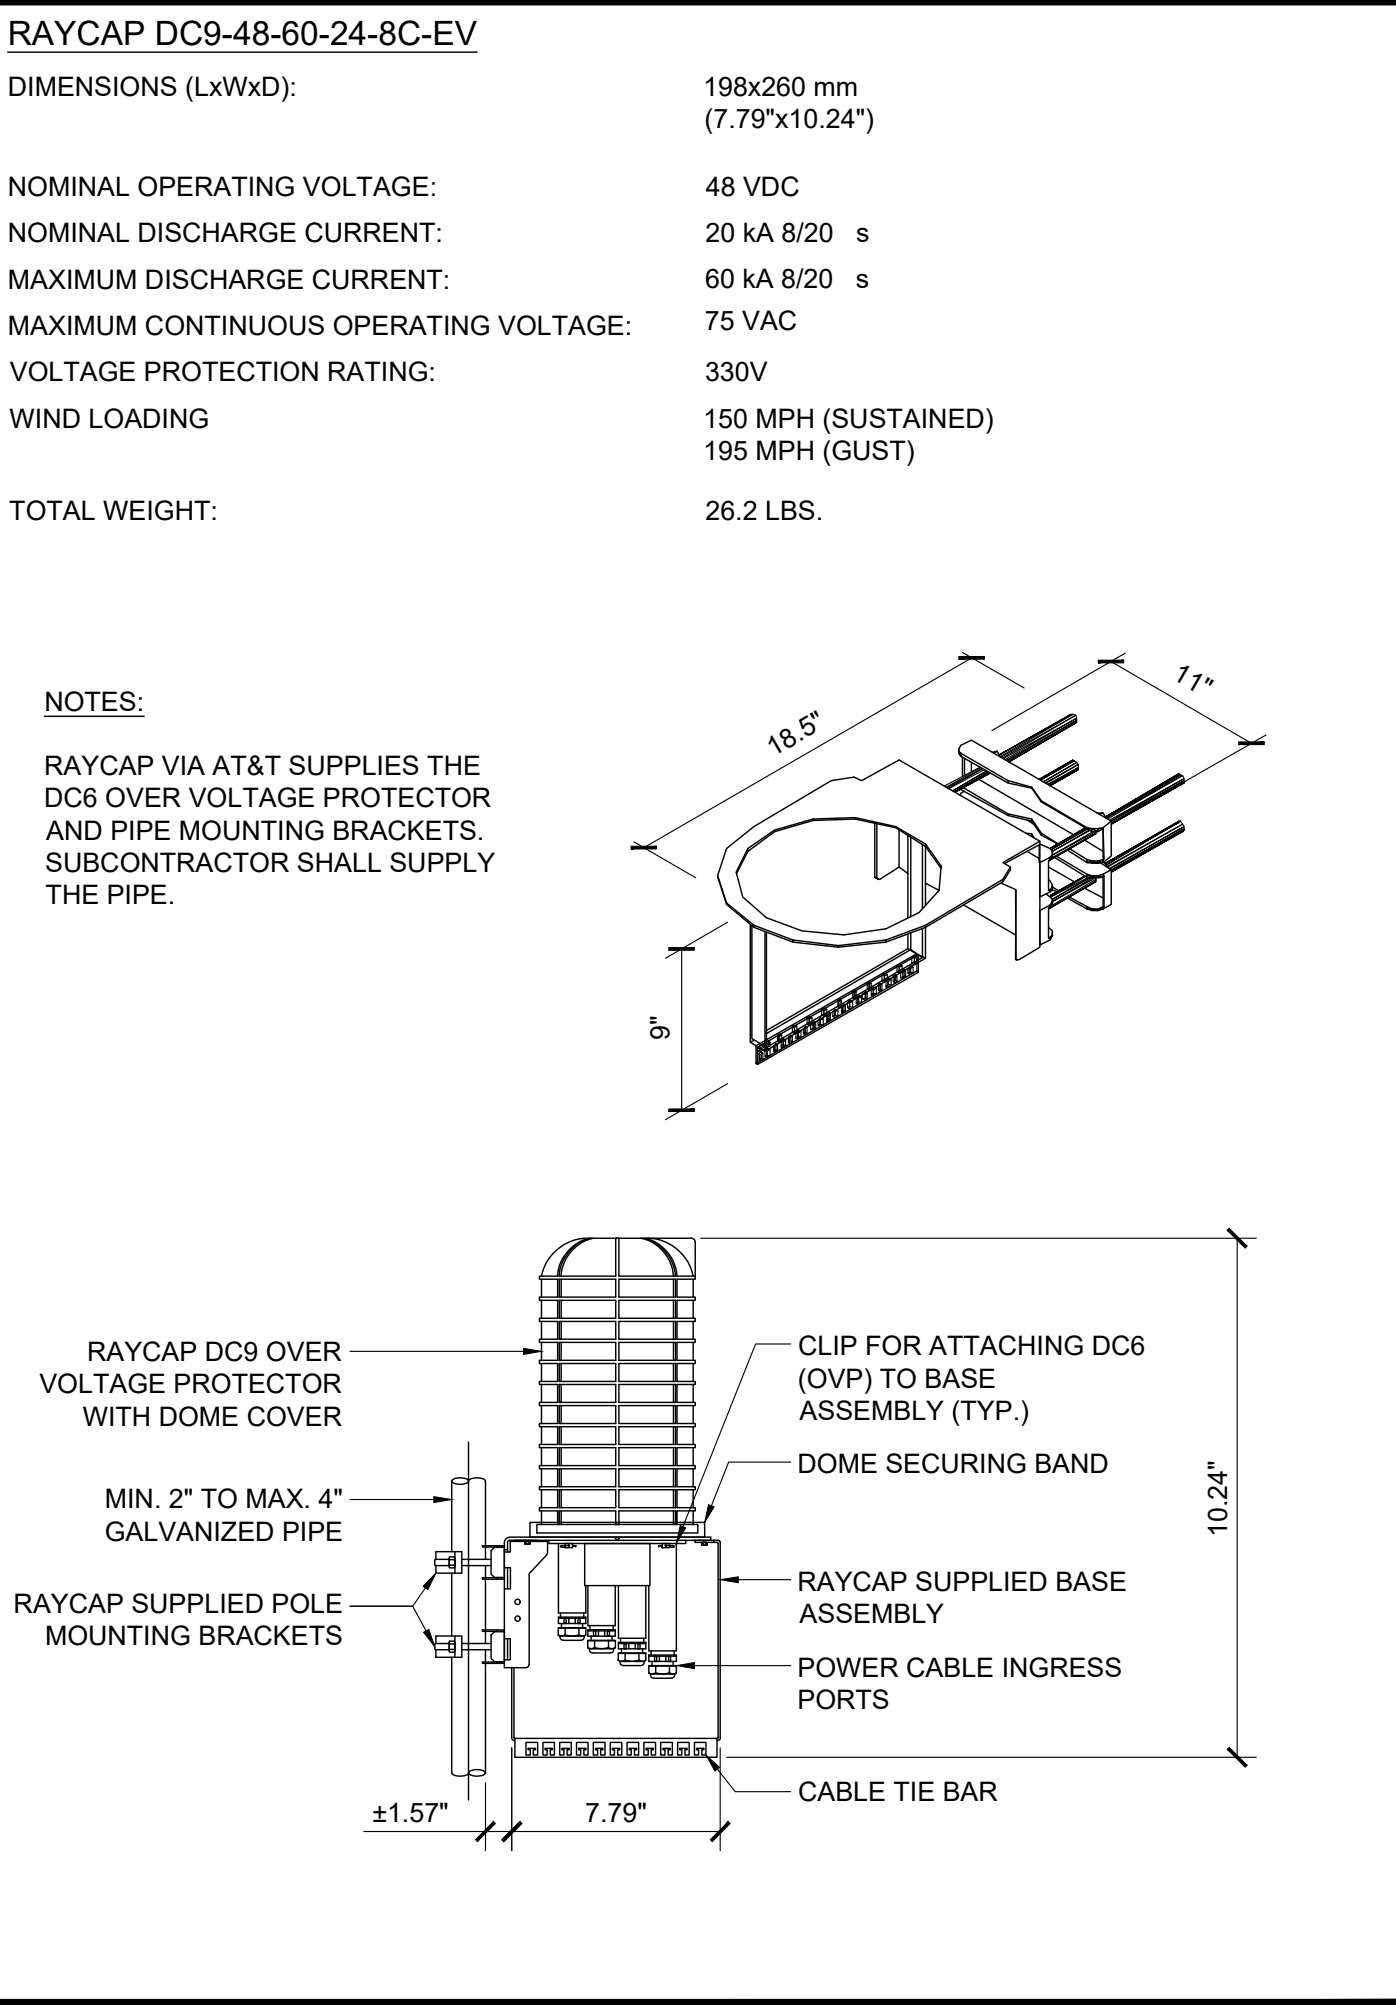


SURGE SUPPRESSOR SPEC


SCALE

NONE

1



1452 EDINGER AVE.
3RD FLOOR
TUSTIN, CA 92780



an SFC Communications, Inc. Company

65 POST, SUITE 1000
IRVINE, CA 92618
TEL: (949) 553-8566
www.eukongroup.com

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DRAWN BY:	UTILITIES CHECKED BY:	A&E CHECKED BY:
DW/AS	GD	RB

CONSTRUCTION DRAWINGS

SUBMITTALS		
REV	DATE	DESCRIPTION
A	04/26/24	90% CONSTRUCTION DRAWINGS
B	08/29/24	JX COMMENTS
0	03/12/24	100% CONSTRUCTION DRAWINGS

PROJECT INFORMATION

CLL05463

1700 N. TOWNE AVE.
CLAREMONT, CA 91711




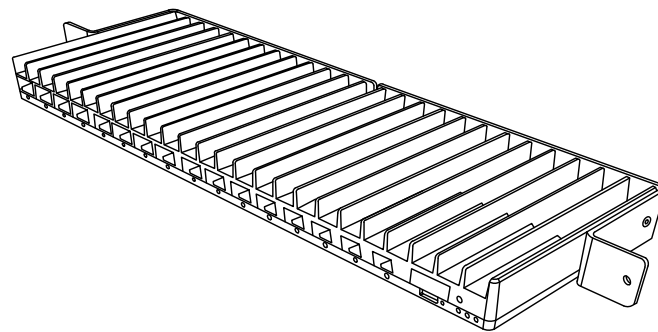
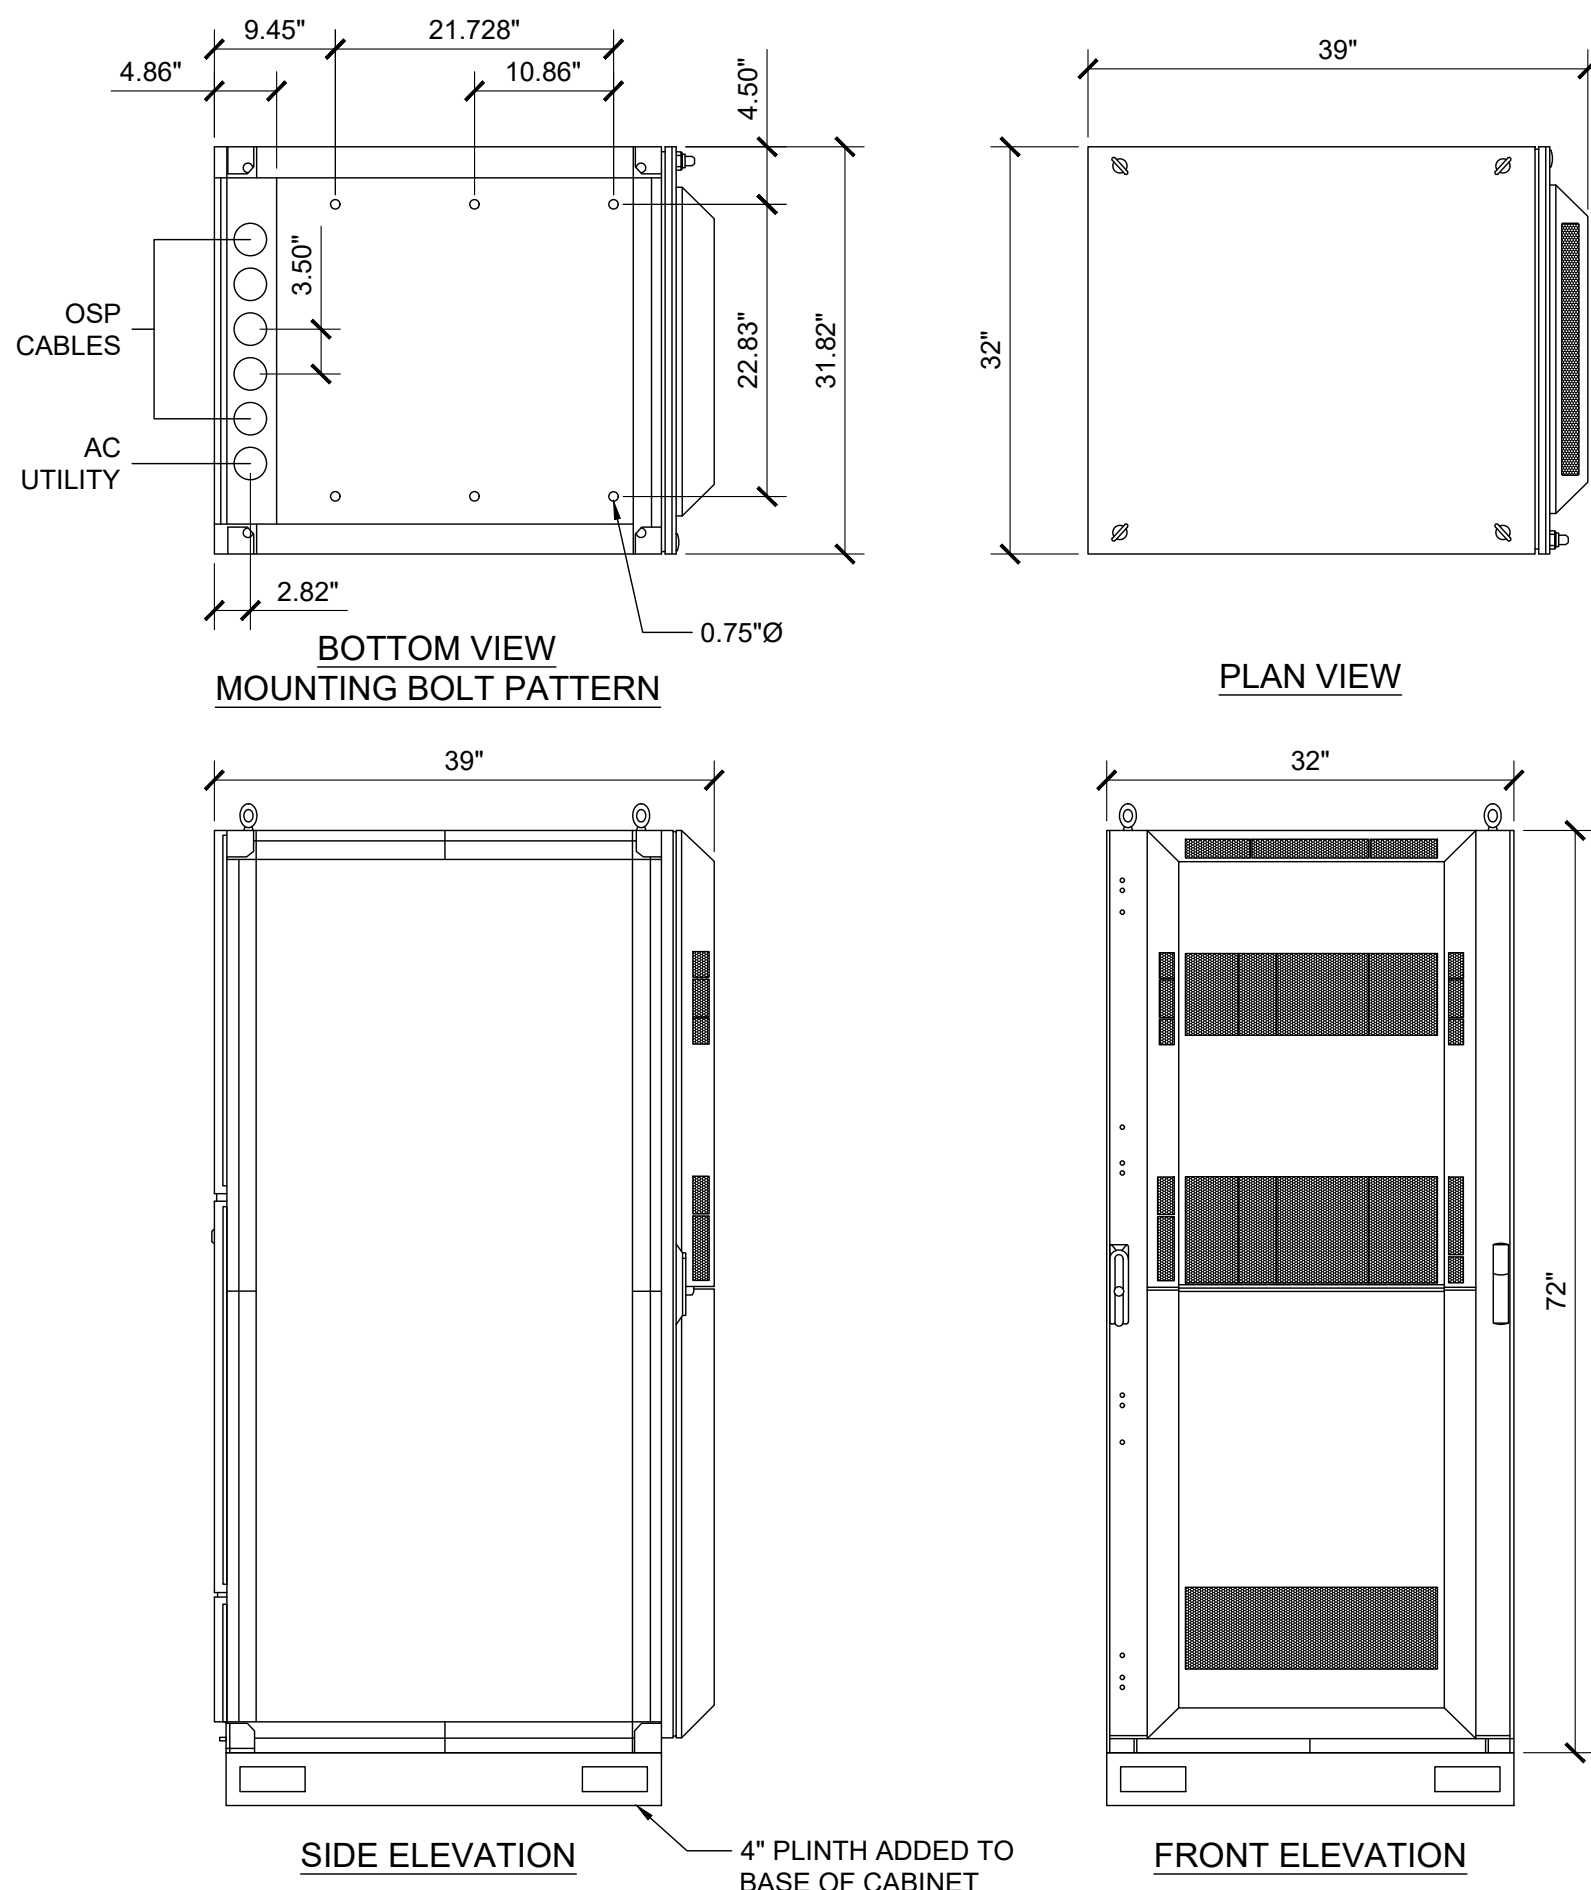
SHEET TITLE

EQUIPMENT DETAILS


SHEET NUMBER

A-6

EUKON AT&T_90CD_MONOPOLE_TEMPLATE_V2_11-18-22

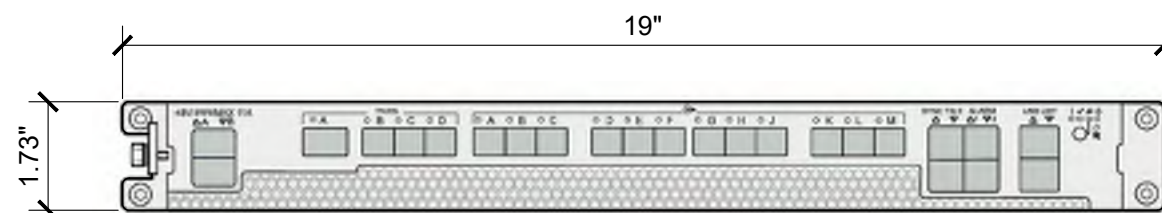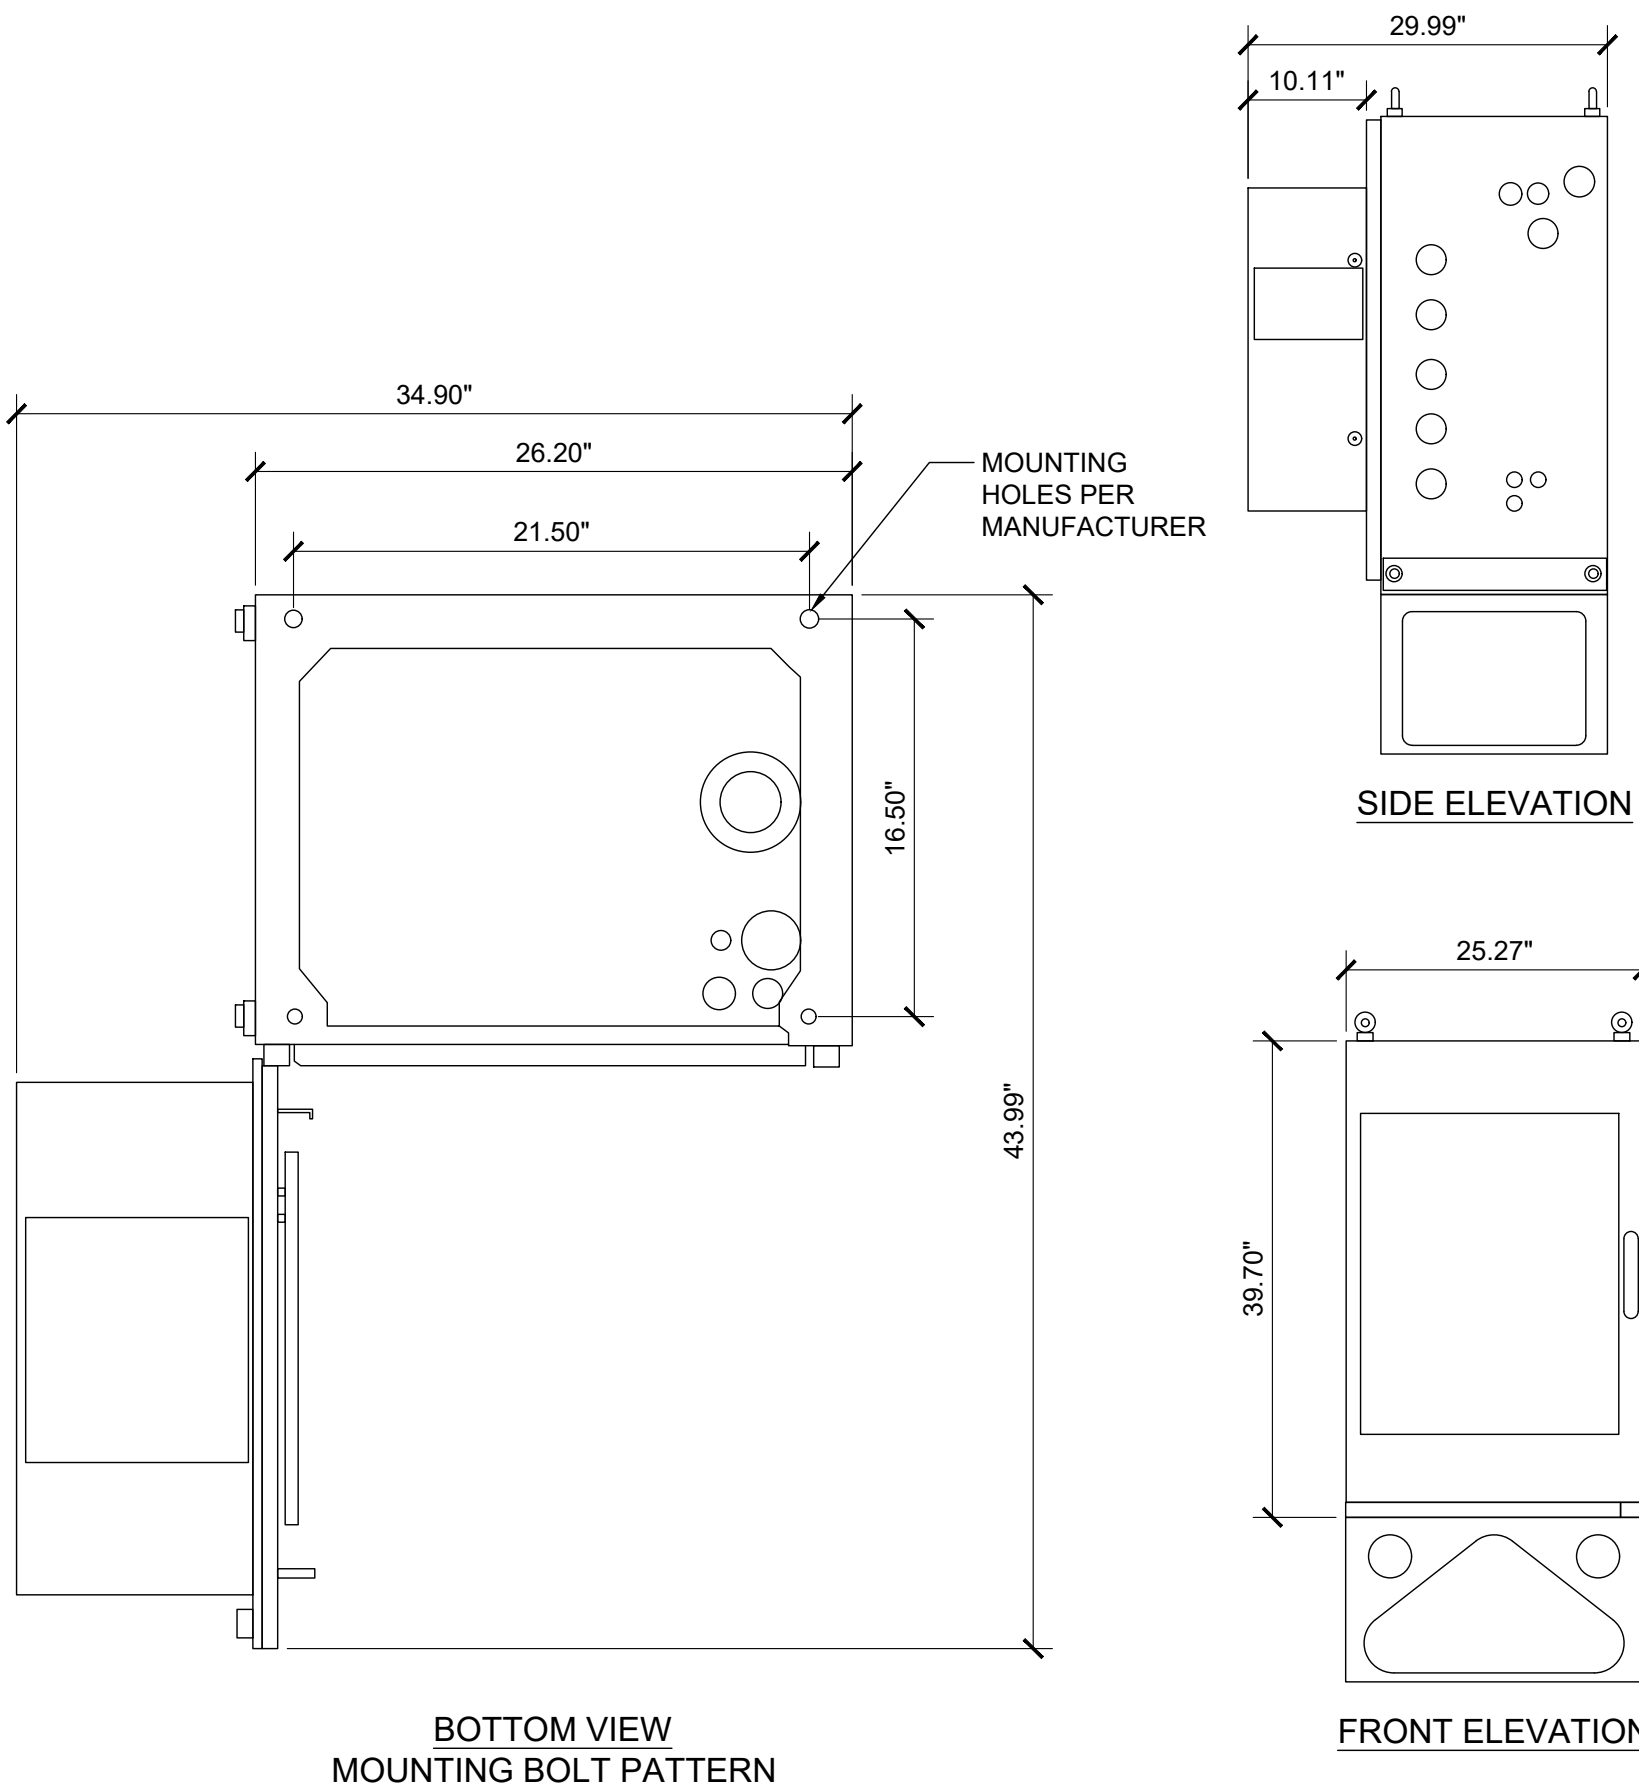			<div>ERICSSON BASEBAND - 6651</div> <div>DIMENSIONS (HxWxD): 1.73 x 19 x 15.1 in</div> <div>WEIGHT: 17 lbs</div> <div></div>			<div>PURCELL CABINET - 66010D FLX21</div> <div>MECHANICAL SPECIFICATIONS:</div> <div>DIMENSIONS: 39.70"H x 25.27"W x 30"D</div> <div>FINISH: ULTRA-LIGHT GRAY POLYESTER POWDER COAT FINISH</div> <div>MOUNTING OPTIONS: 4" & 12" RISER PLINTHS, PAD, POLE, H-FRAME, WALL, UNISTRUT, STACKING</div> <div>WEIGHT: 140 LBS EMPTY 250 LBS FULL</div> <div>SAFETY: ENCLOSURE: UL508A</div> <div>ENVIRONMENTAL: OPERATING TEMPERATURE: -40°F TO 115°F (-40°C TO 46°C) CONTINUOUS OPERATIONS</div> <div>HUMIDITY: 0% TO 95% RELATIVE HUMIDITY, NON-CONDENSING</div> <div>THERMAL SOLUTIONS: POWER CHAMBER: 1600 WATTS</div> <div></div>			<div></div> <div>1452 EDINGER AVE. 3RD FLOOR TUSTIN, CA 92780</div>																																										
NOT USED		SCALE NONE	7	BASEBAND UNIT SPECS		SCALE NONE	5	<div>ERICSSON BASEBAND R503 XMU - BASEBAND AUXILIARY MULTIPLEXING UNIT</div> <div>MECHANICAL SPECIFICATIONS:</div> <div>DIMENSIONS: 1.22"H x 11"D x 13.8"W</div> <div>WEIGHT: 5 LBS</div> <div>HEAT DISSIPATION: 50 WATTS</div> <div>TECHNICAL SPECIFICATIONS:</div> <div>PLATFORM FOR CPRI MULTIPLEXING AND DE-MULTIPLEXING</div> <div>-16x SFP+ PORTS</div> <div>PLUGGABLE OPTICAL TRANSCEIVERS</div> <div>DIRECT ATTACH CABLES</div> <div>-48V DC POWERING</div> <div>-FANLESS</div> <div>TARGET RELEASE - L14B</div> <div>-2x (10Gbps -> 4x 2.5 Gbps)</div> <div></div>			<div>NOT FOR CONSTRUCTION</div>																																								
NOT USED		SCALE NONE	6	BASEBAND UNIT SPECS		SCALE NONE	4	DATA CABINET			SCALE NONE	2	<div>IT IS A VIOLATION OF LAW FOR ANY PERSON, UNLESS THEY ARE ACTING UNDER THE DIRECTION OF THE LICENSED PROFESSIONAL ENGINEER, TO ALTER THIS DOCUMENT.</div> <div>DRAWN BY: UTILITIES CHECKED BY: A&E CHECKED BY:</div> <div>DW/AS GD RB</div> <div>CONSTRUCTION DRAWINGS</div> <div>SUBMITTALS</div> <table><tr><th>REV</th><th>DATE</th><th>DESCRIPTION</th></tr><tr><td>A</td><td>04/26/24</td><td>90% CONSTRUCTION DRAWINGS</td></tr><tr><td>B</td><td>08/29/24</td><td>JX COMMENTS</td></tr><tr><td>0</td><td>03/12/24</td><td>100% CONSTRUCTION DRAWINGS</td></tr><tr><td> </td><td> </td><td> </td></tr><tr><td> </td><td> </td><td> </td></tr><tr><td> </td><td> </td><td> </td></tr><tr><td> </td><td> </td><td> </td></tr><tr><td> </td><td> </td><td> </td></tr><tr><td> </td><td> </td><td> </td></tr><tr><td> </td><td> </td><td> </td></tr><tr><td> </td><td> </td><td> </td></tr></table> <div>PROJECT INFORMATION</div> <div>CLL05463</div> <div>1700 N. TOWNE AVE. CLAREMONT, CA 91711</div> <div>SHEET TITLE</div> <div>EQUIPMENT DETAILS</div> <div>SHEET NUMBER</div> <div>A-7</div>			REV	DATE	DESCRIPTION	A	04/26/24	90% CONSTRUCTION DRAWINGS	B	08/29/24	JX COMMENTS	0	03/12/24	100% CONSTRUCTION DRAWINGS																								
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NOT USED		SCALE NONE	3	POWER PLANT CABINET		SCALE NONE	1	<div>VERTIV NETSURE - 512 DC POWER SYSTEM</div> <div>DC POWER SYSTEM FEATURES:</div> <div>NOMINAL SYSTEM VOLTAGE: -48 VDC or +24 VDC</div> <div>CONTROL: MICROPROCESSOR (ACU+)</div> <div>RATED OUTPUT CAPACITY - MAX CONFIGURATION: SYSTEM: 525A @ -48V DC PLUS REDUNDANCY 400A @ +24V DC PLUS REDUNDANCY</div> <div>RECTIFIER: 2000 WATTS (41.7A)</div> <div>CONVERTER: 1200 WATTS (50A), -48V DC TO +24V DC</div> <div>DISTRIBUTION PANEL TOP SECTION: WIRED FOR (16) +24V AND (13) -48V BULLET POSITIONS</div> <div>BOTTOM SECTION: (30) -48V BULLET POSITIONS</div> <div>ENVIRONMENTAL: OPERATING TEMPERATURE: -40°F TO 115°F (-40°C TO 46°C) CONTINUOUS OPERATIONS</div> <div>HUMIDITY: 0% TO 95% RELATIVE HUMIDITY, NON-CONDENSING</div> <div>THERMAL SOLUTIONS: POWER CHAMBER: 2500 WATT DOOR-MOUNTED HEAT EXCHANGER, 2 RU AVAILABLE SPACE FOR SURGE PROTECTION</div> <div>BATTERY CHAMBER: FAN COOLED, FRESH AIR VENTILATION, HOLDS UP TO (3) BATTERY STRINGS</div> <div>EQUIPMENT: GROUND BAR: 10 POSITIONS</div> <div>TERMINAL BLOCK: 12 POSITION PHOENIX ALARM BLOCK 32 POSITION PHOENIX ALARM BUNCHING BLOCK</div> <div>SAFETY: DC POWER SYSTEM: UL 1801 LISTED (US & CANADA) NEBS LEVEL 3</div> <div>ENCLOSURE: GR-487, UL 60950, AND SEISMIC ZONE 4 COMPLIANT</div> <div>MECHANICAL SPECIFICATIONS: DIMENSIONS: 72"H x 32"W x 39"D</div> <div>WEIGHT: 752 LBS.</div> <div></div>																																											

EUKON AT&T 90CD_MONOPOLE_TEMPLATE_V2_11-18-22

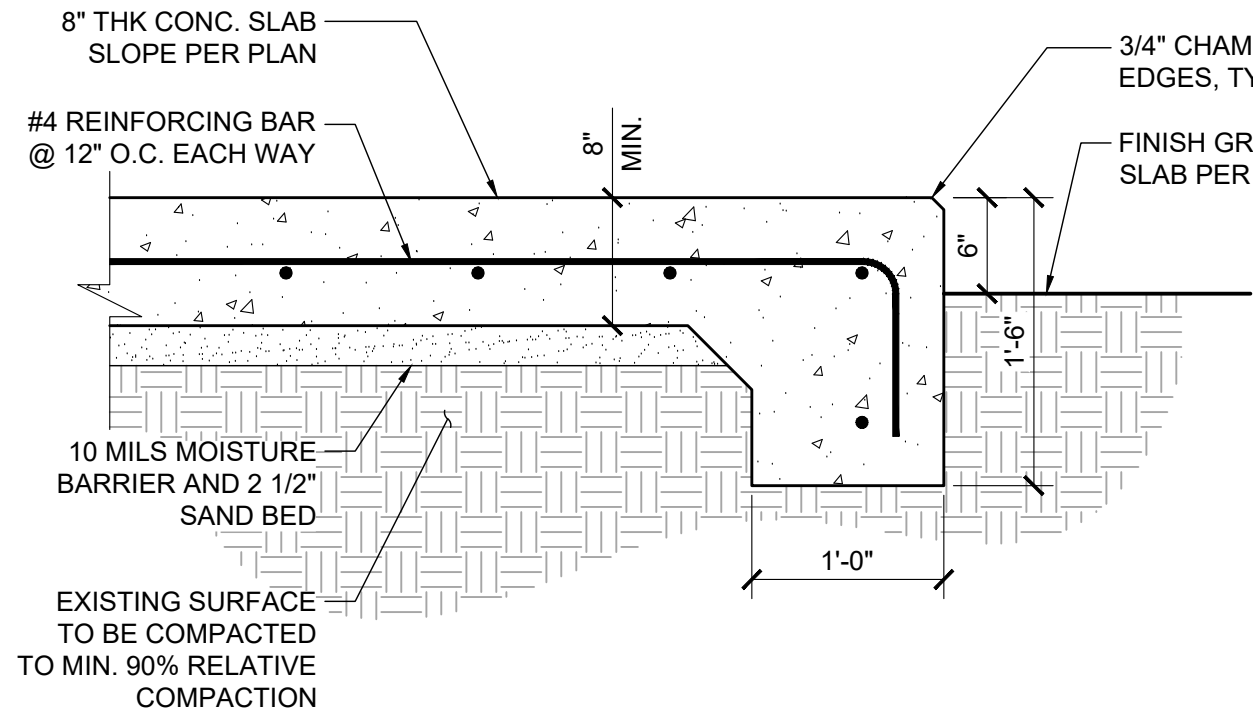

CONCRETE AND REINFORCING STEEL NOTES:

- ALL CONCRETE WORK SHALL BE IN ACCORDANCE WITH THE ACI 301, ACI 318, ACI 336, ASTM A184, ASTM A185 AND THE DESIGN AND CONSTRUCTION SPECIFICATION PER CAST-IN-PLACE CONCRETE.
- ALL CONCRETE SHALL HAVE A MINIMUM COMPRESSIVE STRENGTH OF 2500 PSI AT 28 DAYS, UNLESS NOTED OTHERWISE.
- REINFORCING STEEL SHALL CONFORM TO ASTM A615, GRADE 60, DEFORMED UNLESS NOTED OTHERWISE. WELDED WIRE FABRIC SHALL CONFORM TO ASTM A185 WELDED STEEL WIRE FABRIC UNLESS NOTED OTHERWISE. SPLICES SHALL BE CLASS "B" AND ALL HOOKS SHALL BE STANDARD, UNO.
- THE FOLLOWING MINIMUM CONCRETE COVER SHALL BE PROVIDED FOR REINFORCING STEEL UNLESS SHOWN OTHERWISE ON DRAWINGS:

CONCRETE CAST AGAINST EARTH3 IN.
CONCRETE EXPOSED TO EARTH OR WEATHER:

#6 AND LARGER1 1/2 IN.
#5 AND SMALLER & WWF.....1 1/2 IN.

CONCRETE NOT EXPOSED TO EARTH OR WEATHER
OR NOT CAST AGAINST THE GROUND:

PAD AND WALL3/4 IN.
BEAMS AND COLUMNS.....1 1/2 IN.

- A CHAMFER 3/4" SHALL BE PROVIDED AT ALL EXPOSED EDGES OF CONCRETE, UNO, IN ACCORDANCE WITH ACI 301 SECTION 4.2.4.
- GRAVEL SHALL BE NATURAL OR CRUSHED STONE WITH 100% PASSING 1 INCH SIEVE.
- DIMENSIONS SHOWN ARE EXACT MINIMUM PAD SIZES REQUIRED FOR EQUIPMENT LAYOUTS - CONTRACTOR MAY ROUND UP TO THE NEAREST FOOT (OR HALF FOOT) IF LEASE AREA AND SPACE PERMIT.

CONCRETE SLAB DETAIL


SCALE
NONE

8

UTILITY H-FRAME

SCALE
NONE

5

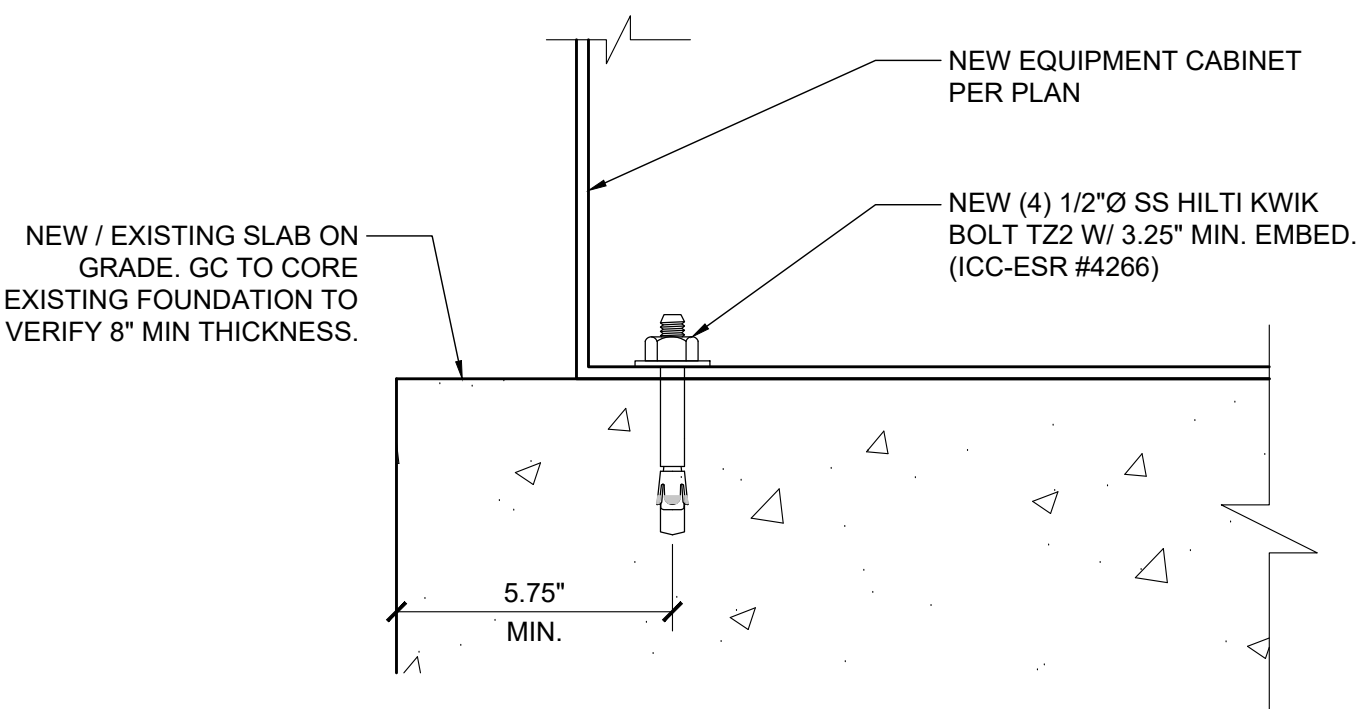

EQUIPMENT ANCHORAGE


SCALE
NONE

7

PANEL MOUNTING

SCALE
NONE


4

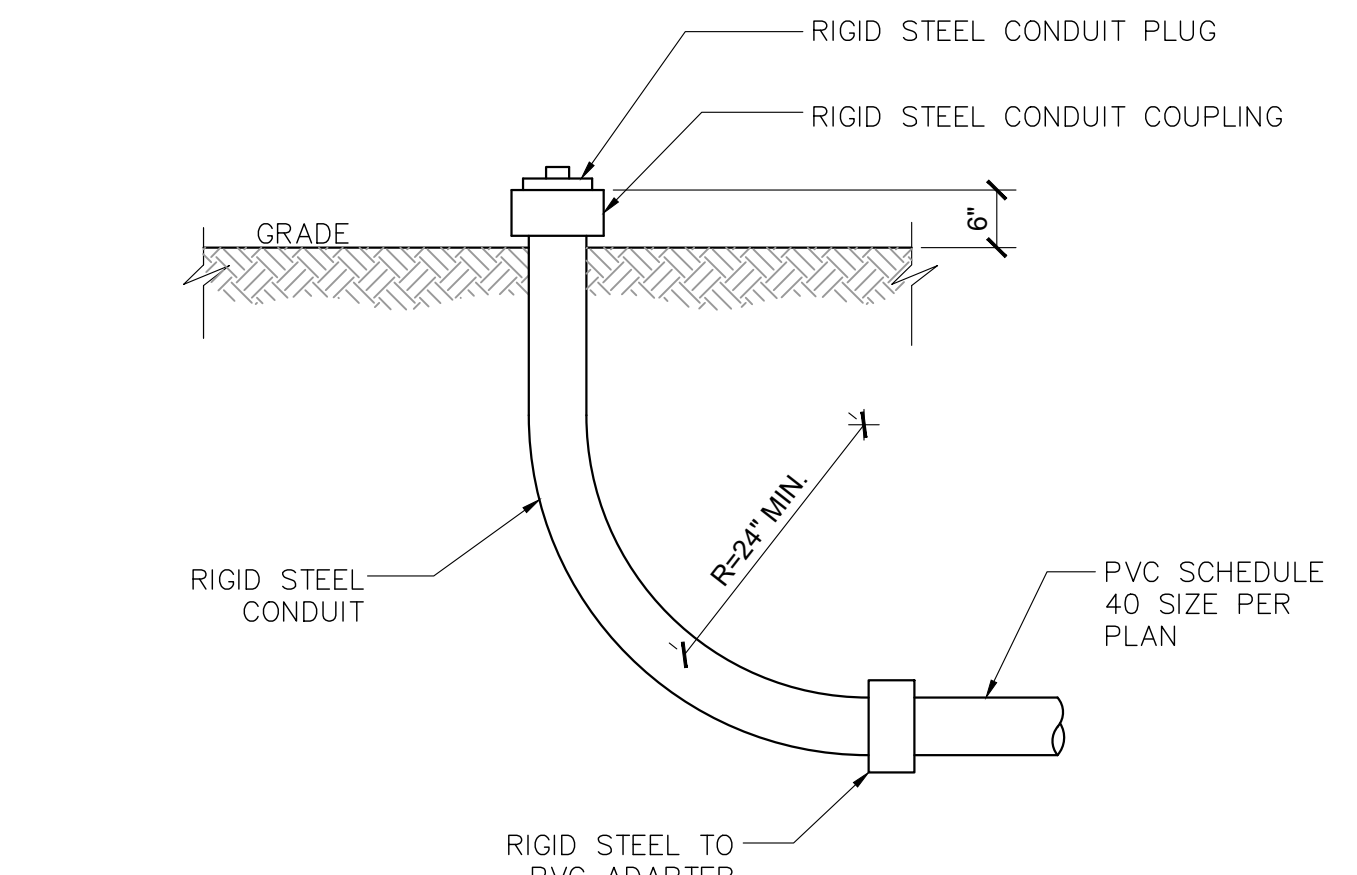

STUB-UP DETAIL

SCALE
NONE


6

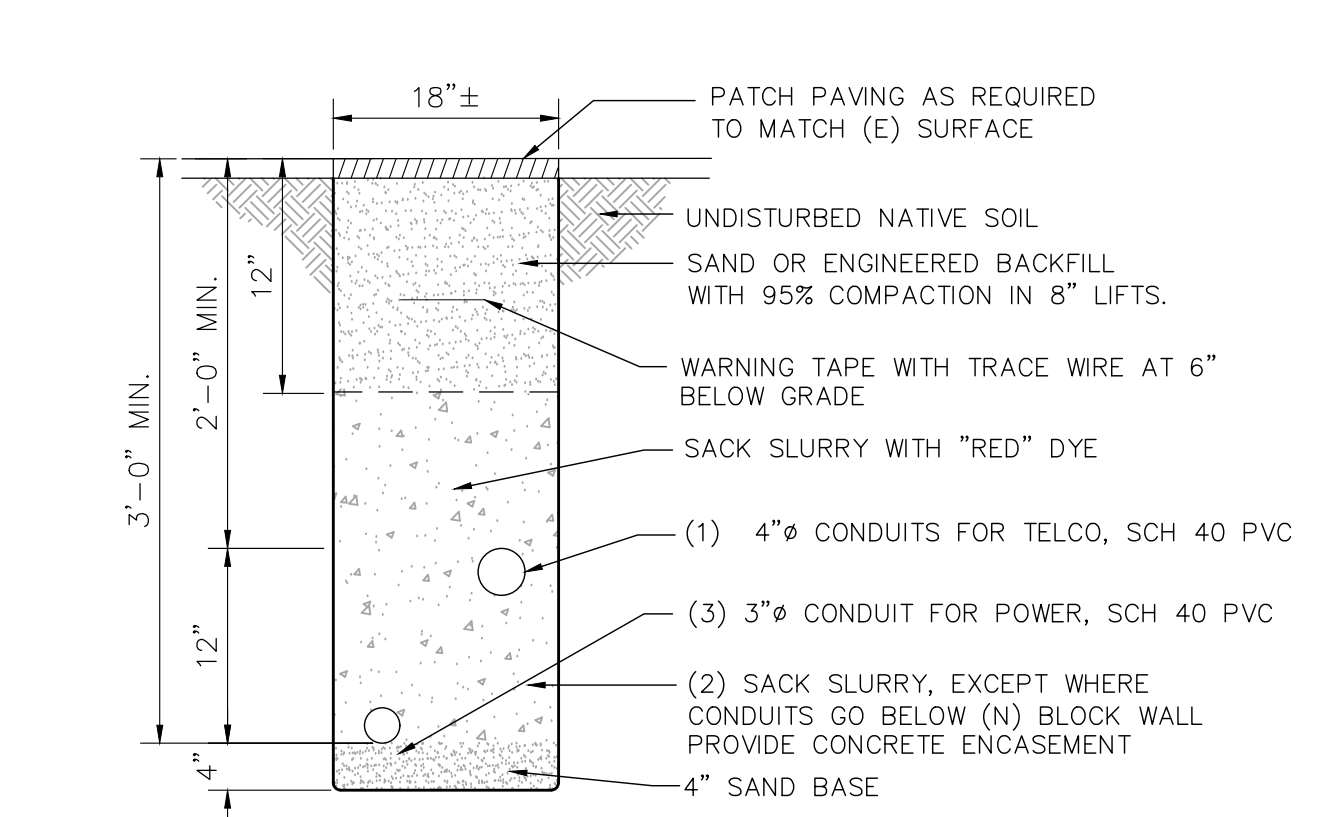

UTILITY TRENCH

SCALE
NONE

3

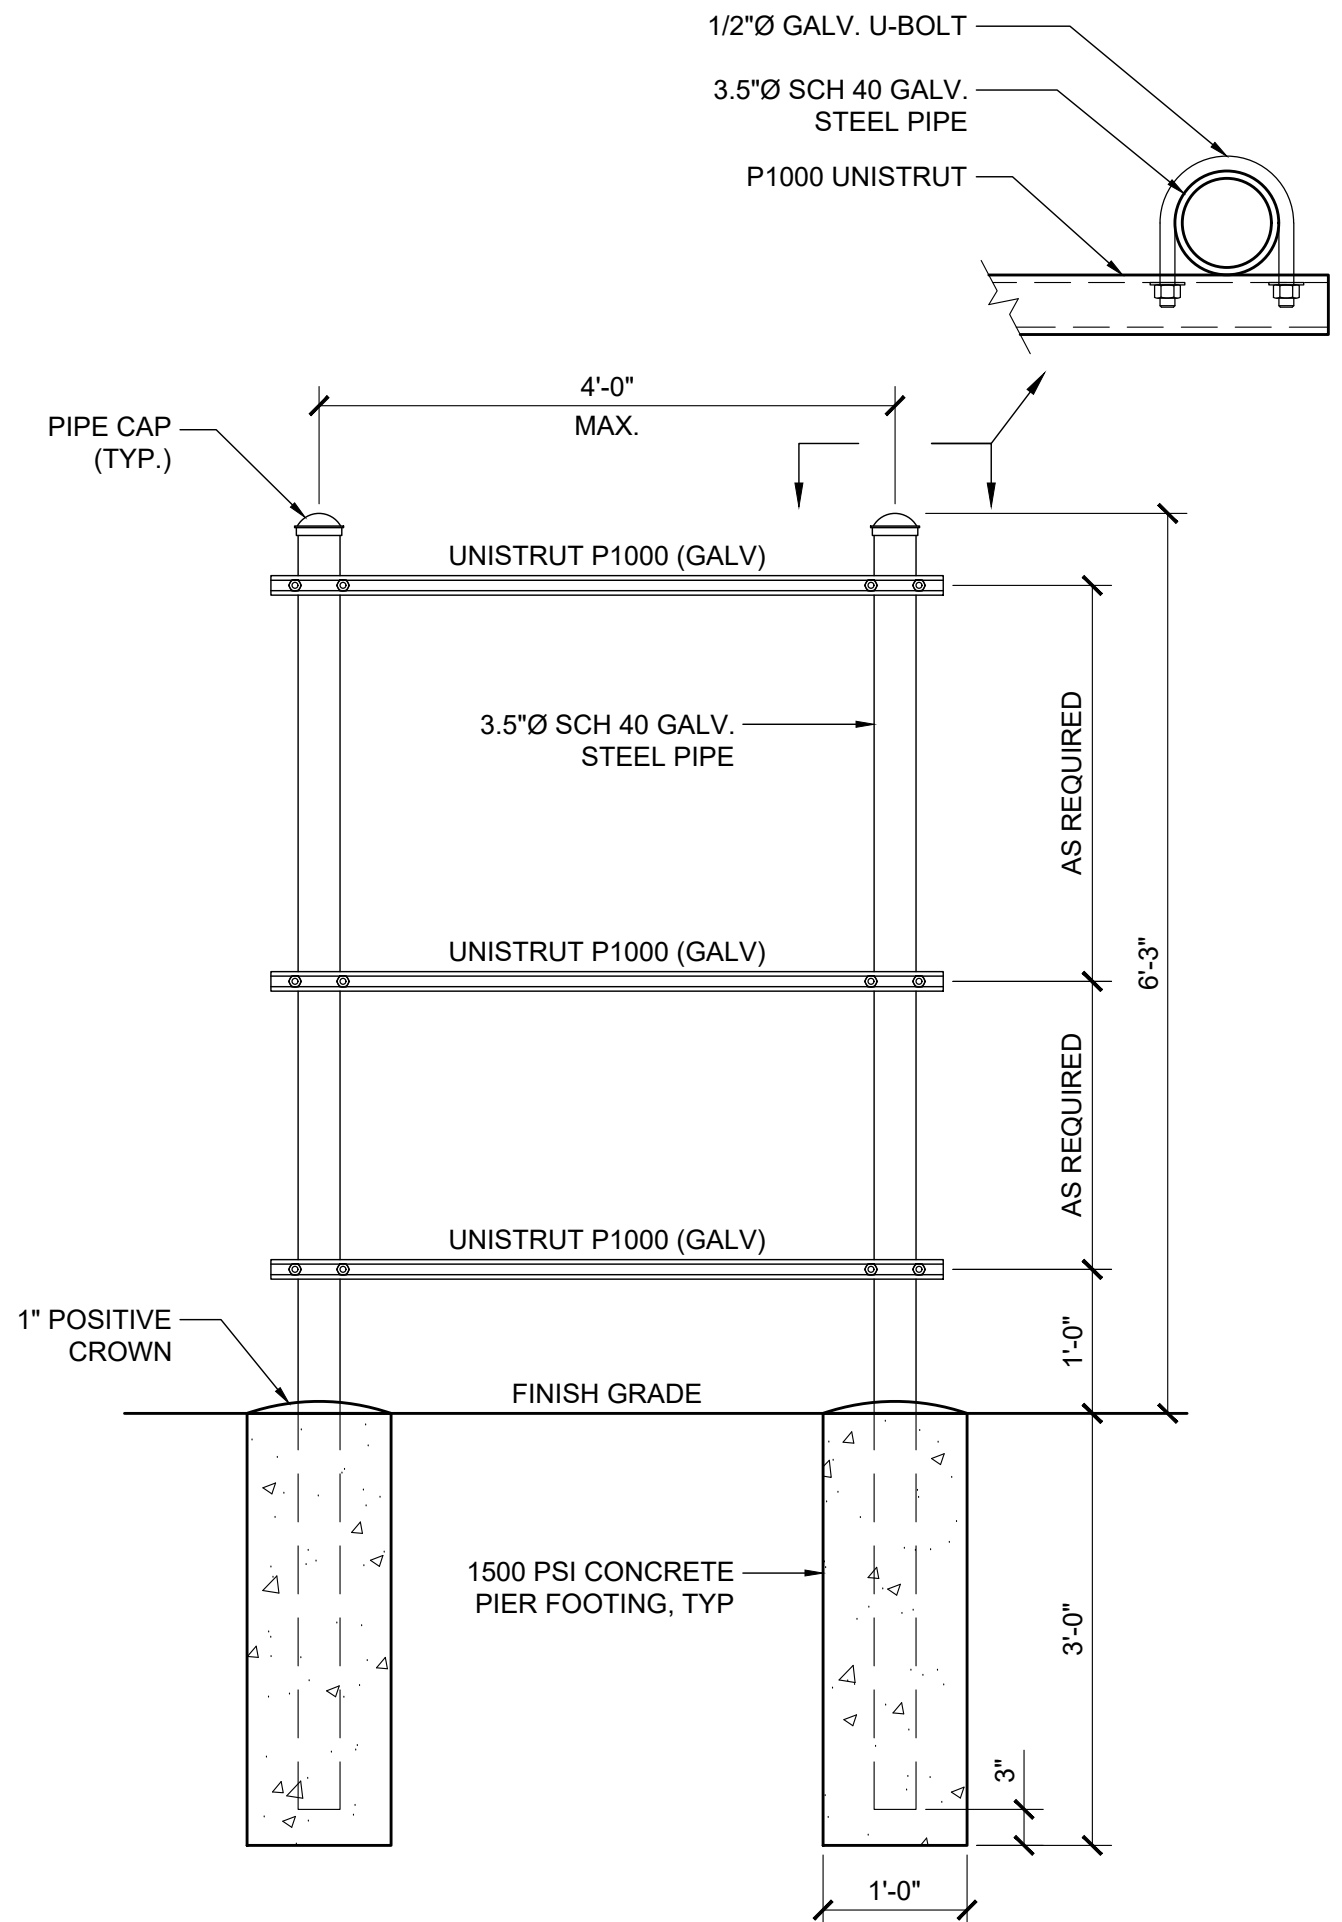


NOT USED

CONCRETE MASONRY BLOCK


- MASONRY UNITS FOR HOLLOW UNIT MASONRY SHALL COMPLY WITH SECTION 2103 OF THE CBC. CONSTRUCTION SHALL COMPLY WITH CHAPTER 21 OF THE CBC AND LOCAL CODES. MASONRY SHALL BE LAID IN STRAIGHT UNIFORM COURSES IN RUNNING BOND. JOINTS SHALL BE TOOLED CONCAVE AND BE UNIFORM IN SIZE. TIE INTERSECTING WALLS BY OVERLAPPING UNITS IN ALTERNATE COURSES. ROUGHEN AND CLEAN CONCRETE BEARING SURFACES FOR THE PLACEMENT OF THE FIRST COURSE. VERTICAL HEAD JOINTS SHALL BE FILLED SOLID AND SHOVED TIGHTLY TO PROVIDE BOND TO BOTH BLOCKS.
- MORTAR SHALL BE FRESHLY PREPARED AND UNIFORMLY MIXED OF 1 PART PORTLAND CEMENT, 1/2 MAXIMUM TO 1/4 MINIMUM PARTS LIME PUTTY OR HYDRATED LIME, AND 3 PARTS SAND.
- GROUT SHALL BE FLUID CONSISTENCY AND MIXED IN RATIO OF 1 PART CEMENT AND 3 PARTS SAND FOR GROUT SPACES LESS THAN 4" IN ANY DIRECTION. FOR SPACES GREATER THAN 4" THE RATIO IS TO BE 1 PART CEMENT, 2 PARTS SAND AND 2 PARTS PEA GRAVEL. AGGREGATE AND SAND SHALL CONFORM TO ASTM C-144. SOLID GROUT ALL CELLS.
- USE CARE TO PREVENT MORTAR AND GROUT SPILLAGE ON THE FACE OF THE MASONRY. CLEAN SUCH SPILLAGE IMMEDIATELY. REPAIR ANY DAMAGES OR INTERSTICES BETWEEN BLOCK AND REMOVE STAINS AT THE COMPLETION OF WORK.
- SPLICE ALL BARS IN MASONRY WITH A MINIMUM OF 48 BAR DIAMETER LAPS (2'-0" MINIMUM).
- ALL ISOLATED BOLTS EMBEDDED IN MASONRY SHALL BE GROUTED SOLIDLY IN PLACE WITH NOT LESS THAN 2" OF GROUT SURROUNDING THE BOLT.
- SEAL RETAINING FACE OF WALL AND FOOTING WITH 2 COATS OF HENRY'S 502 ASPHALTIC MASTIC.

CONSTRUCTION MATERIALS SPECIFICATIONS.


- ALL CONCRETE AND GROUT SHALL BE MIN. $f_c = 2500$ PSI.
- CMU BLOCK SHALL BE MIN. $f_m = 1500$ PSI, 8"x8"x16" U.N.O.
- ALL STEEL SHALL BE GRADE 60. $f_y = 60,000$ PSI, $F_s = 24,000$ PSI

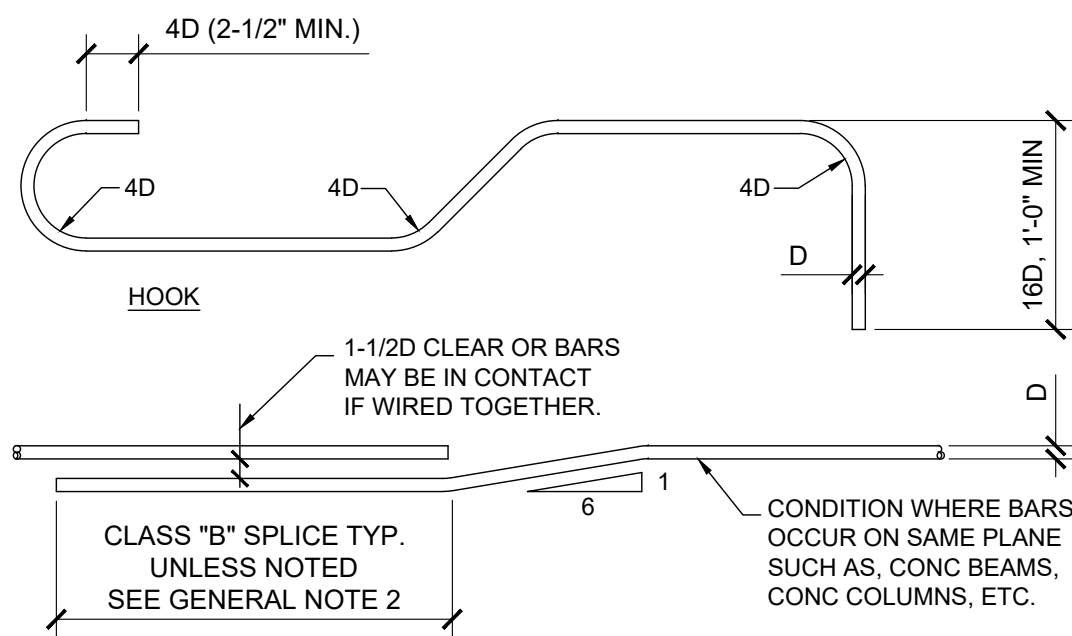

REINF. BENDING DETAIL

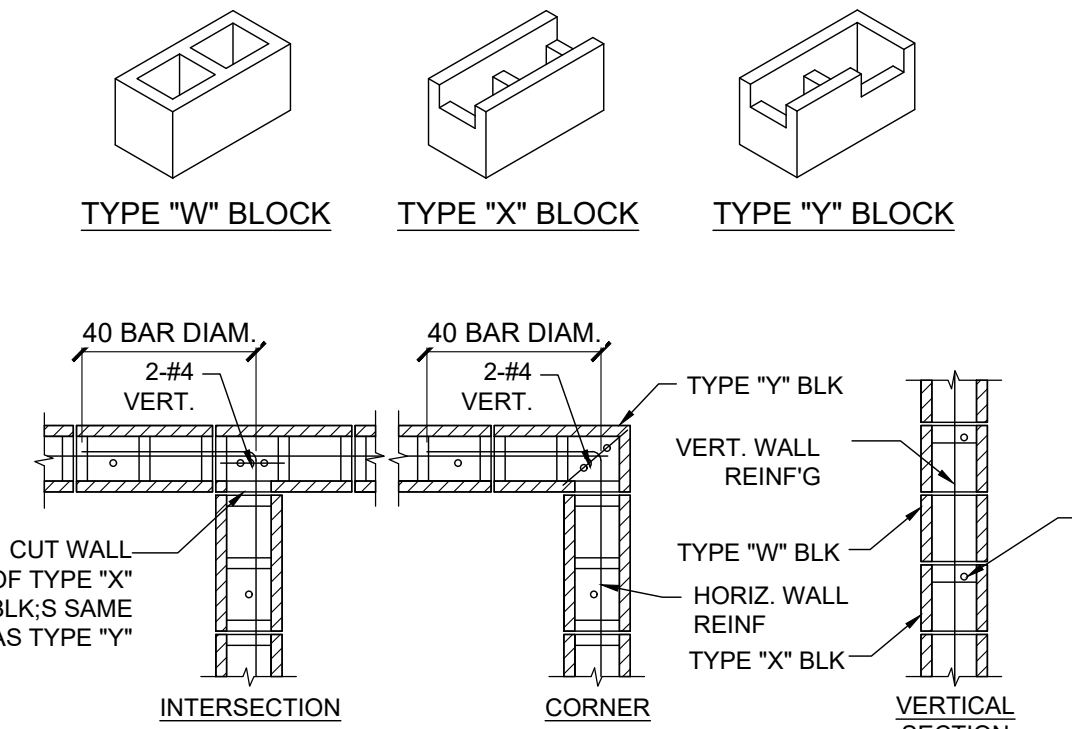

- NOTES
- GROUT ALL CELLS.
 - VERTICAL REINFORCING TO BE AT CENTER OF WALL UNLESS NOTED OTHERWISE.
 - ALSO SEE GENERAL MASONRY NOTES.

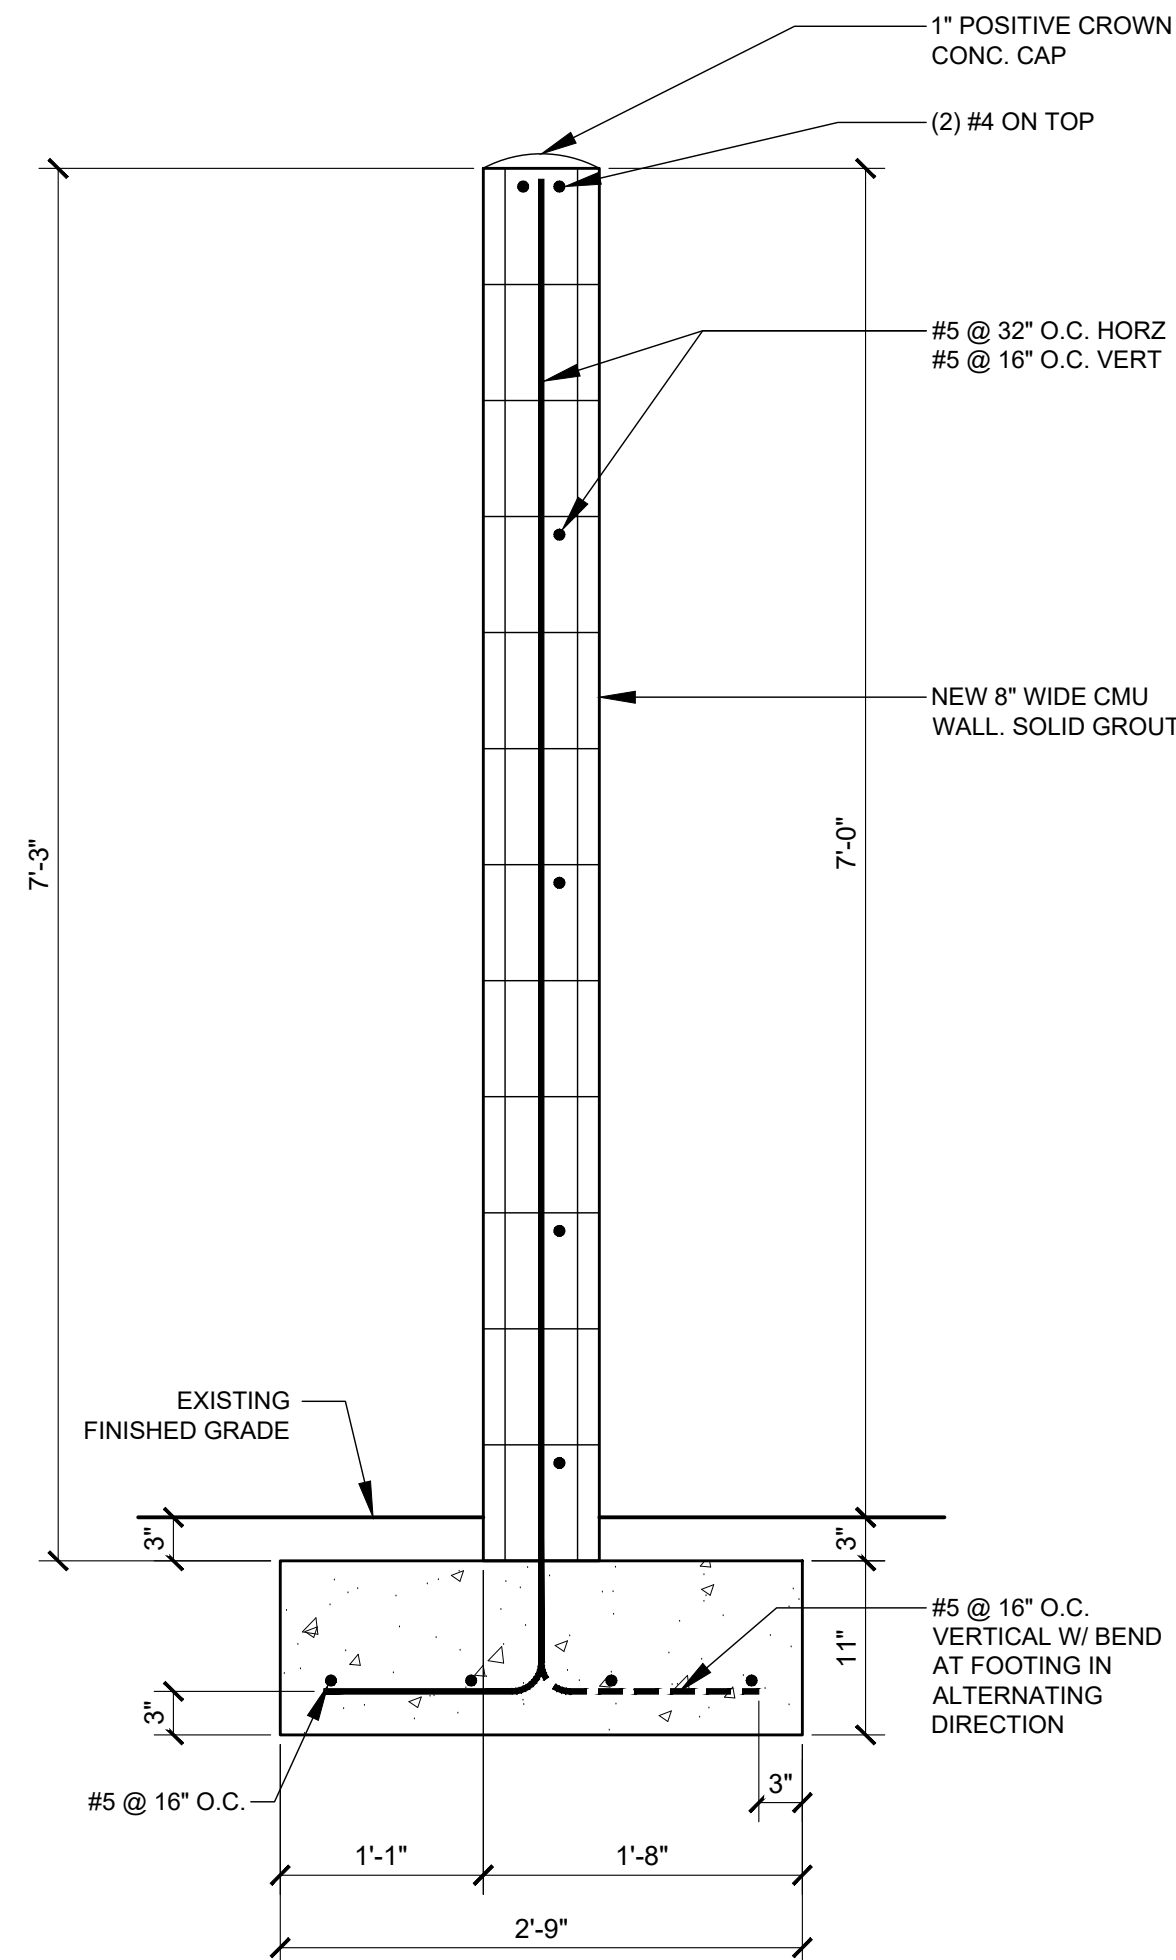

CMU WALL DETAIL

SCALE
NONE

1



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DRAWN BY:	UTILITIES CHECKED BY:	A&E CHECKED BY:
DW/AS	GD	RB

CONSTRUCTION DRAWINGS

SUBMITTALS		
REV	DATE	DESCRIPTION
A	04/26/24	90% CONSTRUCTION DRAWINGS
B	08/29/24	JX COMMENTS
0	03/12/24	100% CONSTRUCTION DRAWINGS

PROJECT INFORMATION


CLL05463

1700 N. TOWNE AVE.
CLAREMONT, CA 91711

SHEET TITLE CONSTRUCTION DETAILS

SHEET NUMBER


A-8

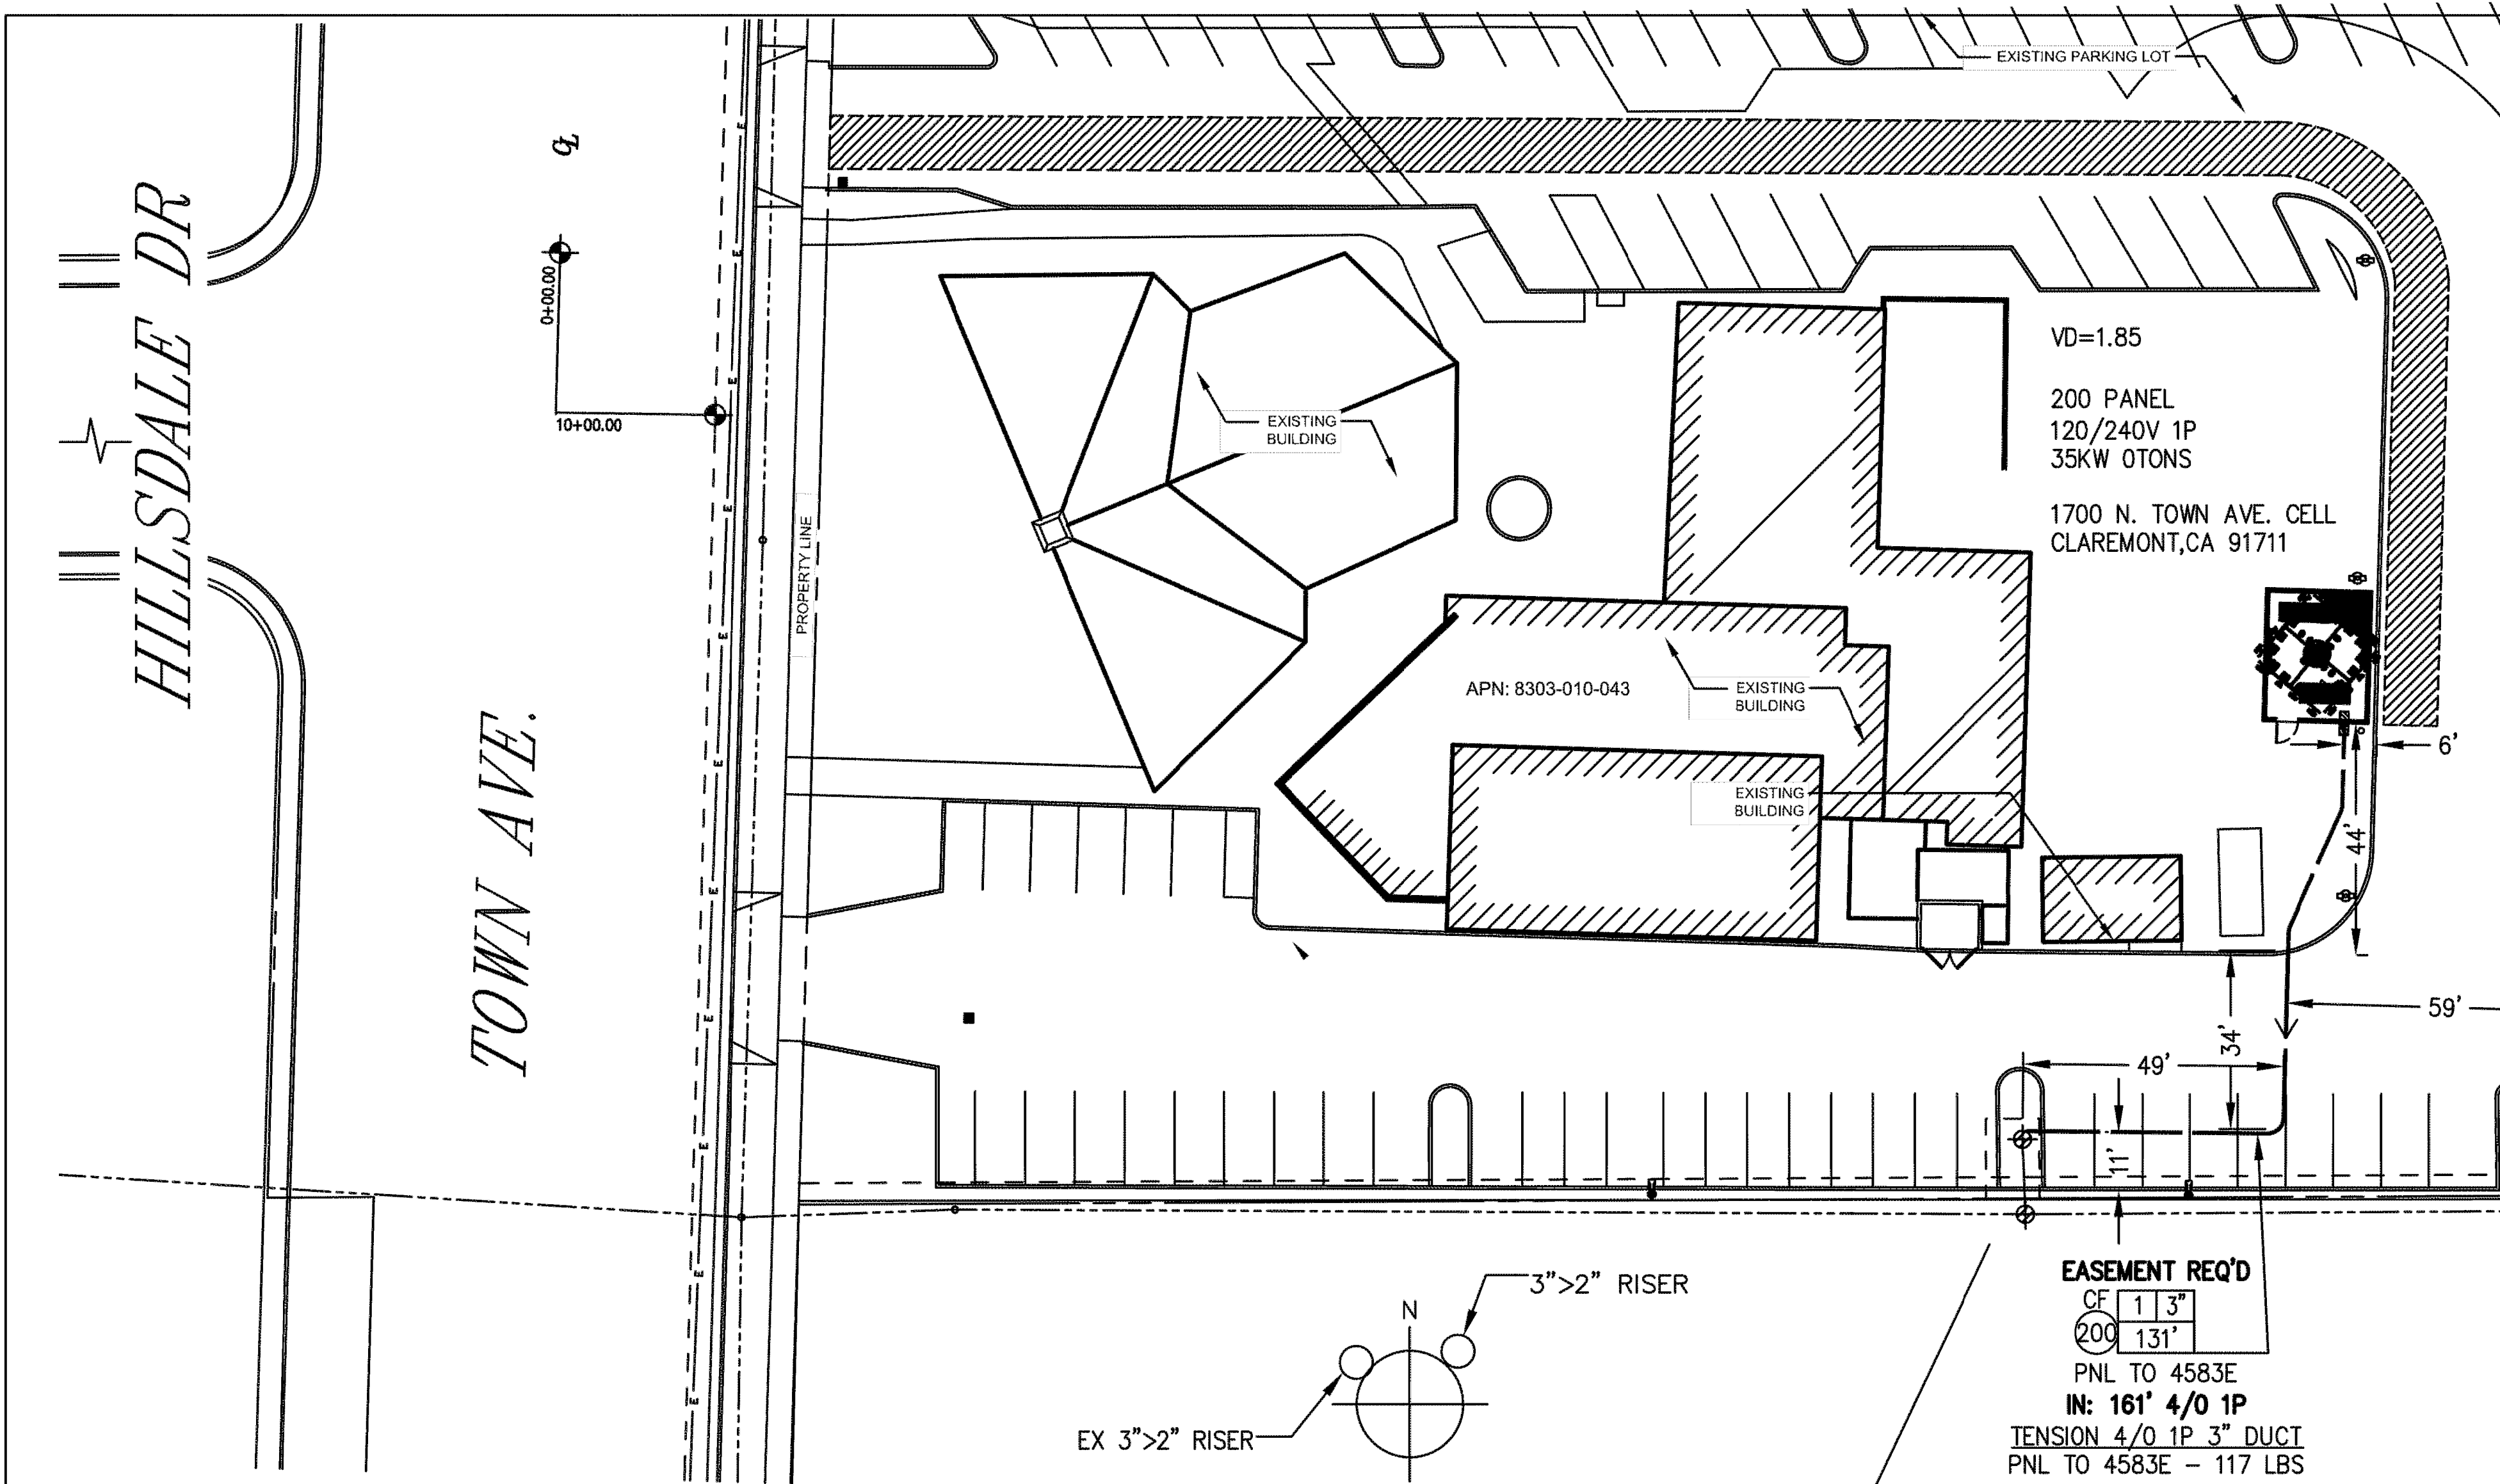

PROJECT REQUIREMENTS (Y/N)

EDISON EASEMENT REQUIRED	<input checked="" type="checkbox"/>
PWRD 88 REQUIRED	<input type="checkbox"/>
UG CIVIL ONLY WORK ORDER	<input type="checkbox"/>
PERMIT REQUIRED	<input type="checkbox"/>
PERMIT TYPE:	
OUTAGE REQUIRED	<input type="checkbox"/>
OUTAGE DATE:	
TIME:	
TRAFFIC CONTROL REQUIRED	<input type="checkbox"/>
PED. TRAFFIC CONTROL REQ'D	<input type="checkbox"/>
CONVEYANCE LETTER REQ'D	<input type="checkbox"/>
ENVIRONMENTAL REQUIREMENTS DOCUMENT (ERD) REQUIRED	<input type="checkbox"/>
CSD 140 (TLM) REQ'D	<input type="checkbox"/>
DIG ALERT APP	<input checked="" type="checkbox"/>
VERIFIED ACTIVE AND CONFIRMED USA TICKETS	<input type="checkbox"/>
UTILQUEST NOTIFIED	<input type="checkbox"/>

STANDARD ADHERENCE: 1 Q/ 23 Y

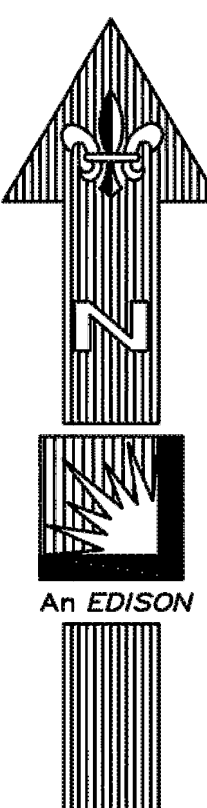

D124: Rev. 10/12/21

SCALE: 1" = 40'

FINAL DESIGN
APPROVED FOR CONSTRUCTION

UNDERGROUND SERVICE ALERT
Contact USA
Dial 811 or 800-422-4133
www.digalert.org/contact
For Underground Locating
Two Working Days Before You Dig

D16: Rev. 05/28/20

T.L.M. DATA: 1654583E				
	SIZE	KVA	CUST	% LOAD
EXIST.	100	48.9	1	48.9%
PROP.	100	90.1	2	90.1%
VOLTAGE DROP: 1.85				
FLICKER FACTOR: —				
PRI. CIRCUIT: FORBES 12KV				

D27: REV. 12/10/21

TD2078262
EX: 1654583E
45' CLASS 2
IN: 1 - TM 2-4/0 & 1-1/0 600V 1P UG TO OH
IN: 1 - RSR 3" TO 2" EXTENSION
CF: 131' - CM DUCT 2 1/2" TO 4"
CF: 128' - CM DUCT FOR EXCAVATION
IN: 161' - CBL (2) 4/0, (1) 1/0 600V CLP PLEX
IN: 1 - MTR KWH 30A 120/240 1P 3W
EX: 2-25KVA & 1-50KVA 12KV 120/240 1P

EASEMENT REQ'D
CF 1 3"
200 131'
PNL TO 4583E
IN: 161' 4/0 1P
TENSION 4/0 1P 3" DUCT
PNL TO 4583E - 117 LBS

DISTRICT 26 - COVINA	PROJ. MGR. HUNTER, YOLANDA PHONE 909-477-6471	PLANNER WITCHELL, WAYNE PHONE 714-796-9810	DESIGNER QUINONEZ, KATHLEENA
PROJECT NO. 2537924	SERVICE REQUEST 3426815	MSR NO.	PRODUCT-1 2078262-NEW METER & SERVICE
CIRCUIT / VOLTAGE FORBES 12KV	GPS	PRODUCT-2	ASSOC DESGN 1583101
SUB / PG NO. LIVE OAK	CIRCUIT CODE 06634	PRODUCT-3	ASSOC DESGN
INVENTORY MAP 155-4366-5	J.P.A. NO.	PROPOSED CONSTRUCTION (LOCATION) AT&T MOBILITY SITE #CLL05463 1700 N TOWNE AVE CLAREMONT CA 91711	
F 01/17/23	C. ANDRADE	W. WITCHELL	K. QUINONEZ
TYPE DATE	APPROVED BY	CHECKED BY	DRAWN BY
Southern California Edison Company			
SHEET 2 of 2		DESIGN\DRWG NO. 1583101_0.01	



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DRAWN BY:	UTILITIES CHECKED BY:	A&E CHECKED BY:
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**CONSTRUCTION
DRAWINGS**

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PROJECT INFORMATION

CLL05463

1700 N. TOWNE AVE.
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SHEET TITLE

UTILITY DESIGN

SHEET NUMBER

UD-1

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DW/AS	GD	RB
-------	----	----

SUBMITTALS

CLL05463

1700 N. TOWNE AVE.
CLAREMONT, CA 91711

SHEET TITLE

UTILITY DESIGN

SHEET NUMBER

UD-2

Diagram illustrating the side view of the equipment. A vertical line represents the equipment's side profile. A horizontal dimension line indicates a required clear and level working space of 3 feet from the equipment to the left. The text "REQUIRED CLEAR AND LEVEL WORKING SPACE. SEE NOTE 3." is written above this dimension line. The word "FRONT" is written above the equipment profile. The word "SIDE VIEW" is written below the equipment profile.

Unistrut riser supports should be installed a maximum of 5' apart, above the 8' level.

Side View

Unistrut

Pipe Clamps

3-1/4"

5/8" Double Arm Bolt

Plan View

3-1/4"

Precut Predrilled 18" Unistrut M/C 132-00746

NOTE(S):

1. All notes pertaining to Figure CR 110-1.1 (Sheet 1) construction on scope CR 110.1 also apply to risers supported by a unistrut.

1.0 APPLICATION

The unistrut shown in Figure CR 110-5 (Sheet 3) is the preferred method where multiple risers are required.

2.0 MATERIAL

TABLE CR 110-2: Unistrut Pipe Clamps

Conduit Size (in)	Material Code
1	622-04052
2	133-48248
2.5	133-48214
3	133-00025
4	133-00017
5	133-48008
6	132-00746

Contact SCE 48 Hours in advance for a Pre-Construction meeting and/or Inspection.

Email: NDPFCSC@SCE.COM

NOTE:

ALL ELECTRICAL DUCTS AND STRUCTURES WILL CONFORM TO GENERAL ORDER #128 (RULES FOR CONSTRUCTION OF UNDERGROUND ELECTRICAL SUPPLY AND COMMUNICATION PRESCRIBED BY THE PUBLIC UTILITIES COMMISSION OF THE STATE OF CALIFORNIA, JANUARY 2006).

- Per SCE requirements, customers are not allowed to enter, intercept or tie-in to existing SCE facilities; e.g. structures, equipment, multi-conduit runs/banks, or conductors. These facilities may be energized and the work will only be performed by SCE. Contact the appropriate SCE inspector to schedule an appointment. Customers may connect to an existing conduit stub without a SCE inspector present.

- Multi-conduit runs/banks are runs of conduit in close proximity to each other and other SCE facilities. A conduit stub is a single empty conduit stub that is not in close proximity to other SCE owned facilities. Refer to the work order map for details.
- Per CPUC/SCE's Rule 15 B.1.A and Rule 16 D.1.A., the customer will provide all necessary excavations (with the exception of excavation under pads and primary splice boxes), material (including conduit and structures) and encasement, to be utilized in the intercept/tie-in process.
- The customer must adhere to all applicable Cal-OSHA, local, city, state and federal regulations, (including, but not limited to, all necessary shoring and traffic control in place to perform the intercept/tie-in work by SCE's underground civil contractor(s)).
- Intercept/tie-in work must be coordinated with SCE's civil contractors through the Division Inspector/P-Spec to limit exposure of excavation(s). Customer is responsible for securing excavation(s).

D08: 11/13/18

WOOD MOULDING WITH #6 (MIN.) WIRE INSIDE TO TOP.

ALIGN RISER WITH A TEMPORARY LENGTH OF CONDUIT; REMOVE THIS LENGTH WHEN RISER IS SET.

SOLVENT WELD PIPE CAP ONTO RISER. DO NOT PERMIT EXCESS CEMENT TO ENTER CONDUIT. CAP HDG BEND WITH CONCRETE-FILLED COUPLING.

RISER BENDS

36"(MIN) RADIUS FOR 1" TO 3" INCL.
48"(MIN) RADIUS FOR 4" AND 5"
60"(MIN) RADIUS FOR 6" AND OVER

GRADE

3"(MIN) 24"(MAX)

ENCASEMENT

DUCT

COUPLING OR ADAPTER

#6(MIN) BARE COPPER TO GROUND RODS

MINIMUM EARTH COVER OVER RISER BEND TO BE AS FOLLOWS:

CONDUIT SIZE	HDG COVER	FIBERGLASS COVER
1"-3"	33"	47"
4"-5"	57"	59"
6"	72"	74"

REAM INTERIOR OF LOWER END OF ABS RISER BEND TO PERMIT A SMOOTH TRANSITION FROM THE CONDUIT TO THE RISER.

#6(MIN) BARE COPPER

5/8" x 8" COPPERCLAD STEEL GROUND ROD AND CLAMP
2 PLACED 6"(MIN) SEPARATION

CONDUIT

WOOD MOULDING

POLE

GROUNDING TYPICAL FOR BOTH POLE CONFIGURATIONS

4"

RISER BEND

POLE

1. APPROVED RISER BENDS ARE SHOWN ON FOLLOWING TABLE;

MATERIAL	SIZE							
	1"	1-1/2"	2"	2-1/2"	3"	4"	5"	6"
ABS	-	-	-	X	X	X	X	-
FIBERGLASS	-	-	-	-	X	X	X	X
HDG	X	X	X	X	X	X	X	X

NOTE: 6" HDG OR FIBERGLASS RISER BEND SHALL BE USED WHEN SPECIFIED ON THE WORKING DRAWING. SEE UGS AC 702 FOR GROUNDING HDG RISER BENDS.

2. THE TOP AND BOTTOM OF 3", 4", 4", 5" OR 6" FIBERGLASS BENDS ARE FURNISHED WITH PERMANENTLY ATTACHED PVC COUPLINGS. ALSO INCLUDED IS A 6" LONG 3", 4", 5" OR 6" SCHEDULE 80 PVC STUB-OUT, SOLVENT WELDED INTO THE TOP COUPLING. SEE UGS CD 168 FOR FIBERGLASS RISER BEND MATERIAL INFORMATION AND SUPPLIERS.
3. ALL RISER RODS ARE TO BE 1/2" DIA. STEEL RODS WITH 1/4" DIA. TRENCH BOLTS. TRENCH BOLTS TO BE MINIMUM SEPARATION IN UNDISTURBED EARTH. LEAVE THE ROD TOPS 3" ABOVE THE TRENCH BOTTOM AND ATTACH CONTINUOUS GROUND WIRE WITH CLAMP. EXTEND WIRE TO INDICATED LOCATION ON POLE AND STUB UP TO THE NEXT GRADE. SEE UGS 100 FOR DETAILS. ALL GROUNDING MATERIALS FURNISHED BY CONTRACTORS. SEE UGS AC 703 FOR APPROVED GROUNDING MATERIALS.
4. ENCASUREMENT REQUIRED ONLY WHEN CALLED OUT ON WORKING DRAWINGS.
5. PVC RISERS MAY BE SUBSTITUTED FOR FIBERGLASS FOR STRAIGHT RUNS OF 150' OR LESS IN CONDUIT SIZES 4" AND

D78: REV. 02/14/11

FINAL DESIGN
APPROVED FOR CONSTRUCTION

DISTRICT 26 - COVINA				PROJ. MGR. HUNTER, YOLANDA PHONE 909-477-6471				PLANNER WITCHELL, WAYNE PHONE 714-796-9810				DESIGNER QUINONEZ, KATHLEENA			
PROJECT NO. 2537924		SERVICE REQUEST 3426815		MSR NO.		PRODUCT-1 2078262-NEW METER & SERVICE						ASSOC DESGN 1583101			
CIRCUIT / VOLTAGE FORBES 12KV				GPS		PRODUCT-2						ASSOC DESGN			
SUB / PG NO. LIVE OAK				CIRCUIT CODE 06634		PRODUCT-3						ASSOC DESGN			
INVENTORY MAP 155-4366-5				J.P.A. NO.				PROPOSED CONSTRUCTION (LOCATION) AT&T MOBILITY SITE #CLL05463 1700 N TOWNE AVE CLAREMONT CA 91711							
F 01/17/23		C. ANDRADE		W. WITCHELL		K. QUINONEZ		63055							
TYPE		DATE		APPROVED BY		CHECKED BY		DRAWN BY		PAX #		SHEET		DESIGN\DRWG NO.	
Southern California Edison Company										1 OF 2		1583101_0.01			

99: 10/26/20

30" MIN.

1 1/2"

3"

1"

BE D

E E

DIRECT BURIAL

CONSTRUCTION FOR FEWER CO

2 CONDUITS MAX.

D81: Rev. 09/23/04

CONDUIT RADIUS REQUIREMENTS:

- A: The minimum radius for bends are:
36" for conduits 3" in diameter or smaller
48" for conduits 4" and 5" in diameter
60" for 6" diameter conduit
- B: The minimum radius for sweeps are:
36" for conduits 3" in diameter or smaller
12'-6" for conduits 4" in diameter and larger
unless otherwise noted.

WARNING

THE EXCAVATOR MUST TAKE ALL STEPS NECESSARY TO AVOID CONTACT WITH UNDERGROUND FACILITIES WHICH MAY RESULT IN INJURY TO PERSONS OR DAMAGE TO FACILITIES IN THE AREA. THE INDICATED LOCATIONS OF EDISON UNDERGROUND FACILITIES, AS PROVIDED, ARE BELIEVED TO BE ACCURATE. HOWEVER, THE FINAL DETERMINATION OF EXACT LOCATIONS AND THE COST OF REPAIR TO DAMAGED FACILITIES IS THE RESPONSIBILITY OF THE EXCAVATOR.

RUN NUMBER CALL-OUTS AS FOLLOWS:


- | | |
|-----------|----------------------|
| ① - 199 | MAINLINE CONDUIT |
| 200 - 599 | SERVICE CONDUIT |
| 600 - 799 | STREET LIGHT CONDUIT |

D84: Rev. 10/26/20

FILE NAME: 1583101_0.01.DWG SAVE DATE: 1/23/2023 12:29 PM SAVED BY: QUINONKMI

EUKON AT&T 90CD MONOPOLE TEMPLATE V2 11-18-22

NOTES:
1. THIS SITE PLAN IS NOT INTENDED
TO BE A LAND SURVEY.

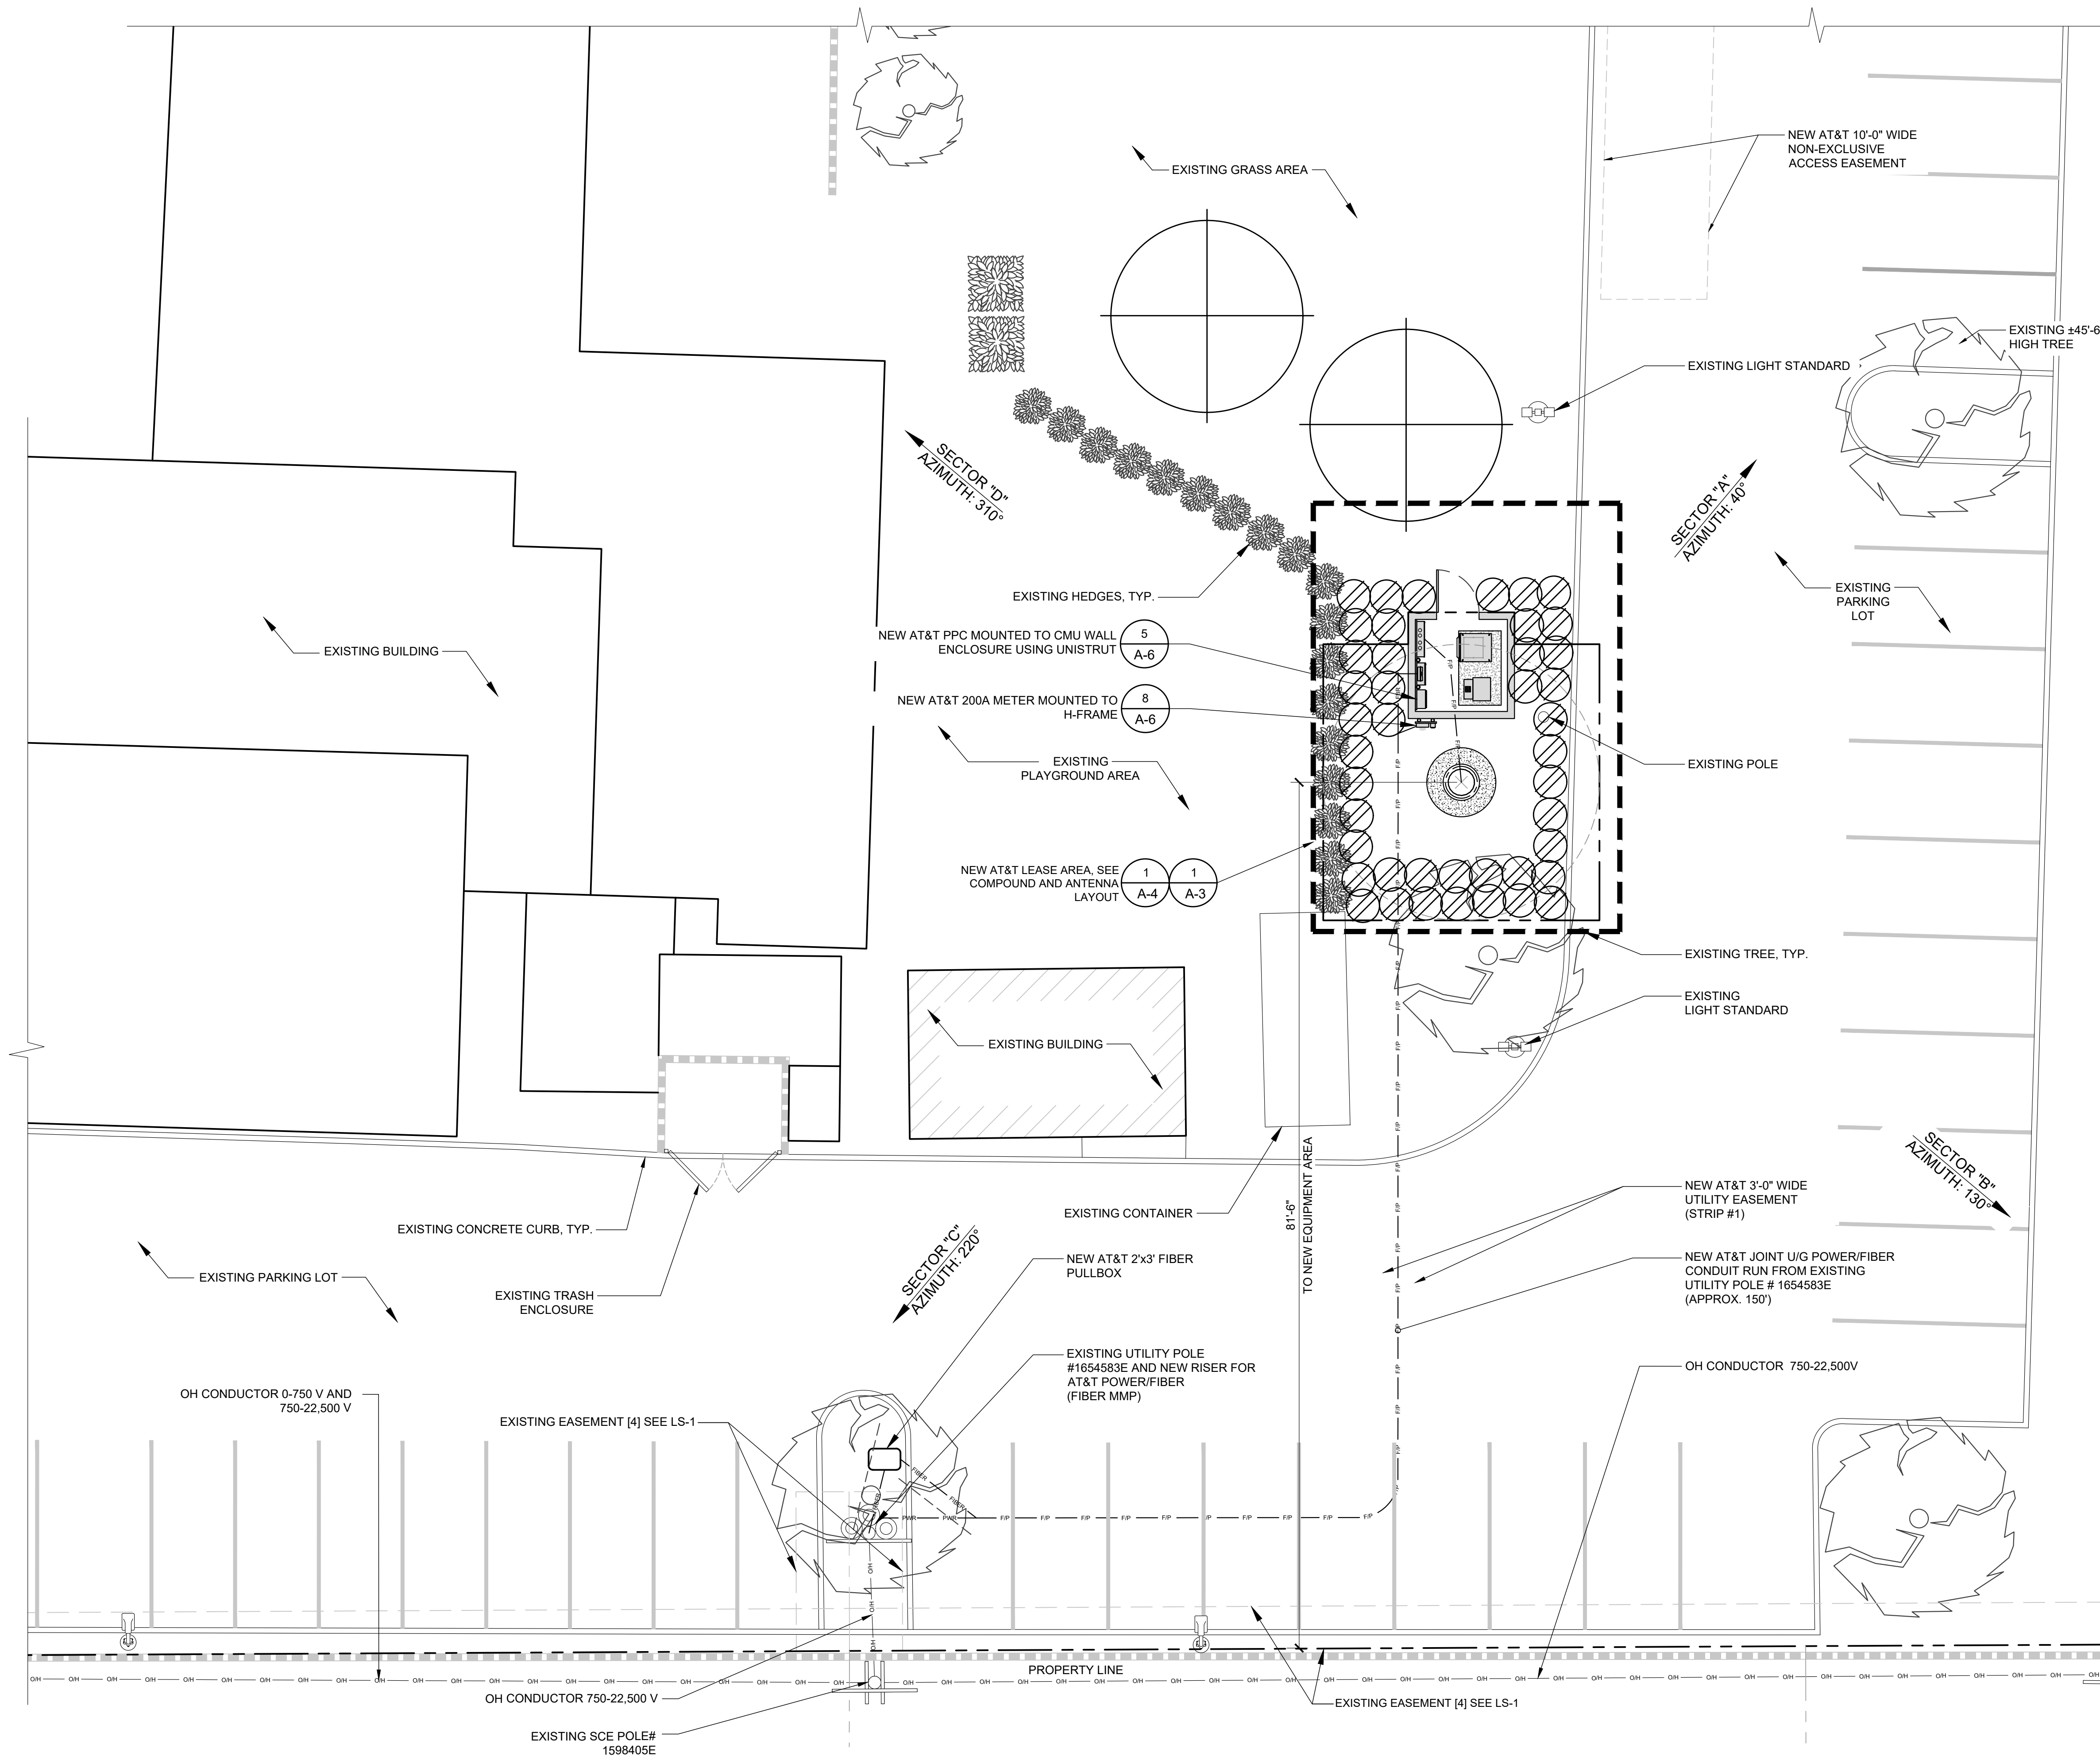

1452 EDINGER AVE.
3RD FLOOR
TUSTIN, CA 92780



65 POST, SUITE 1000
IRVINE, CA 92618
TEL: (949) 553-8566
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NOT FOR
CONSTRUCTION

IT IS A VIOLATION OF LAW FOR ANY PERSON,
UNLESS THEY ARE ACTING UNDER THE DIRECTION
OF THE LICENSED PROFESSIONAL ENGINEER,
TO ALTER THIS DOCUMENT.

DRAWN BY:	UTILITIES CHECKED BY:	A&E CHECKED BY:
DW/AS	GD	RB

CONSTRUCTION DRAWINGS

SUBMITTALS		
REV	DATE	DESCRIPTION
A	04/26/24	90% CONSTRUCTION DRAWINGS
B	08/29/24	JX COMMENTS
0	03/12/24	100% CONSTRUCTION DRAWINGS

PROJECT INFORMATION


CLL05463

1700 N. TOWNE AVE.
CLAREMONT, CA 91711

SHEET TITLE ELECTRICAL SITE PLAN

SHEET NUMBER

E-1

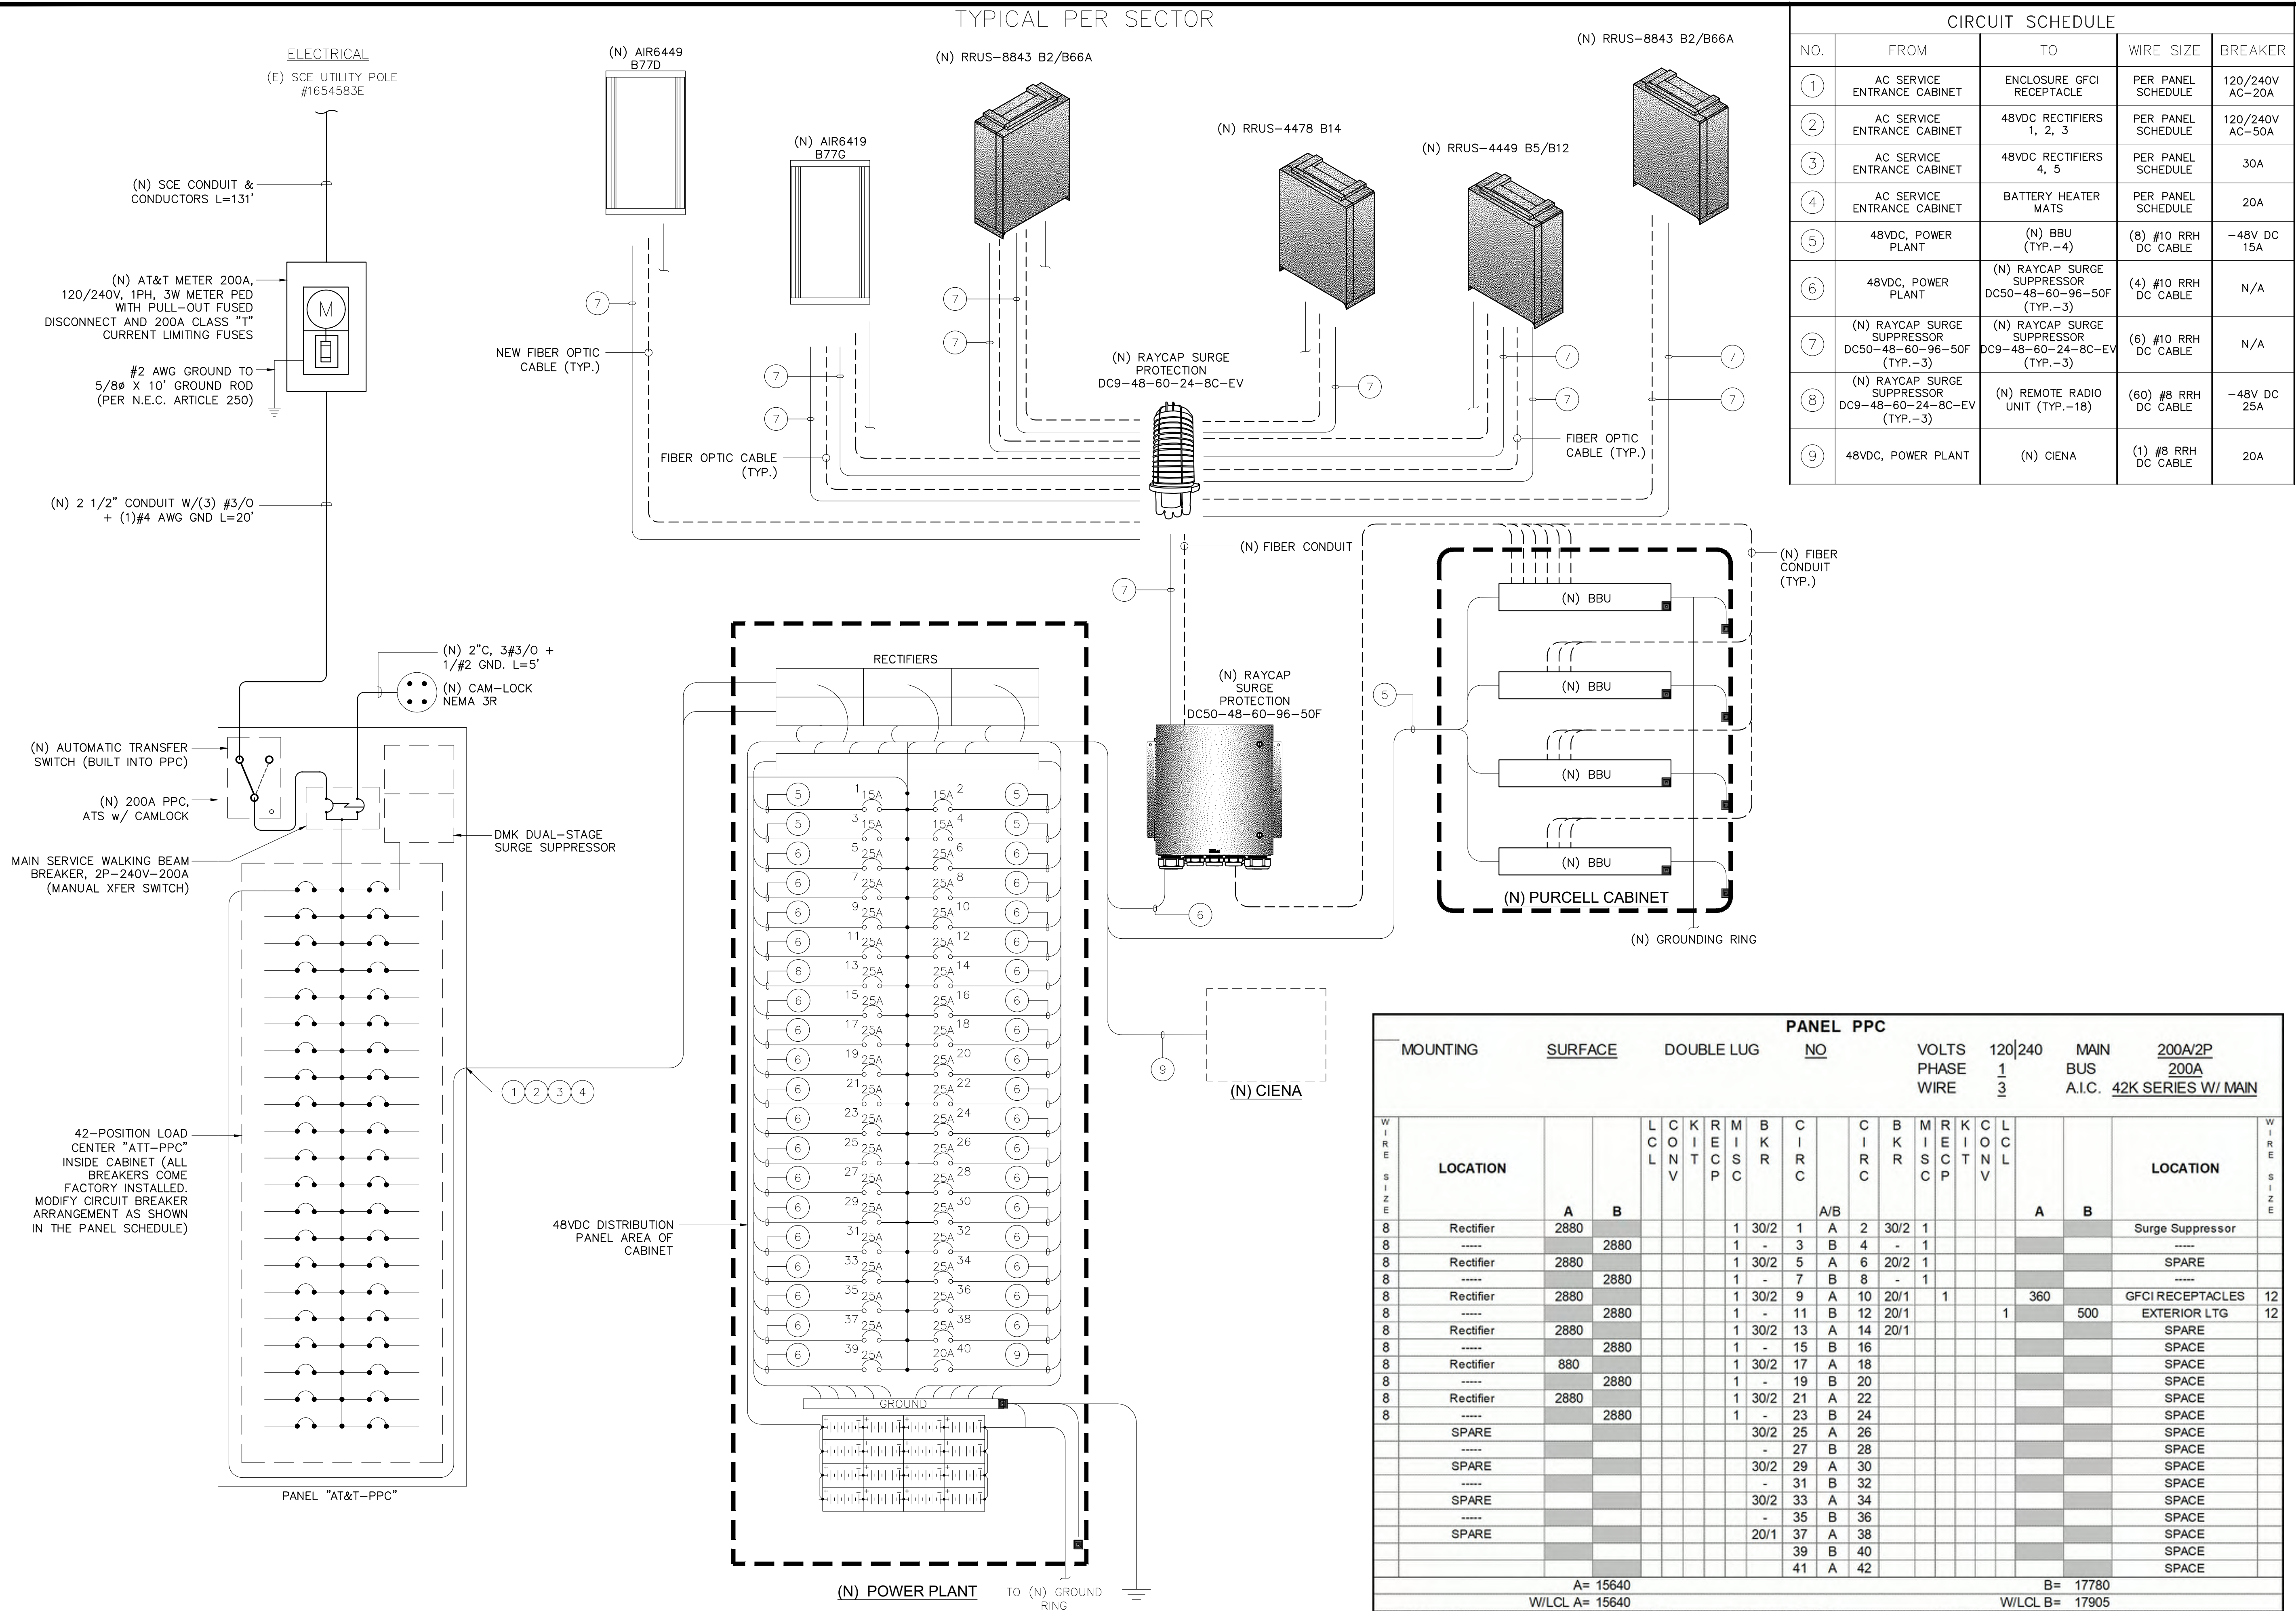

EUKON AT&T 90CD_MONOPOLE_TEMPLATE_V2_11-18-22

NOT USED

2

ELECTRICAL NOTES

1

GENERAL REQUIREMENTS

- A. ALL WORK AND MATERIALS SHALL BE IN ACCORDANCE WITH THE LATEST RULES AND REGULATIONS OF THE NATIONAL ELECTRIC CODE AND ALL STATE AND LOCAL CODES. NOTHING IN THESE PLANS OR SPECIFICATIONS SHALL BE CONSTRUED AS TO PERMIT WORK NOT CONFORMING TO THE MOST STRINGENT OF THESE CODES. SHOULD CHANGES BE NECESSARY IN THE DRAWINGS OR SPECIFICATIONS TO MAKE THE WORK COMPLY WITH THESE REQUIREMENTS, THE CONTRACTOR SHALL IMMEDIATELY NOTIFY THE ARCHITECT IN WRITING AND CEASE WORK ON PARTS OF THE CONTRACT WHICH ARE AFFECTED.
- B. THE CONTRACTOR SHALL MAKE A SITE VISIT PRIOR TO BIDDING AND CONSTRUCTION TO VERIFY ALL EXISTING CONDITIONS AND SHALL NOTIFY THE ARCHITECT IMMEDIATELY UPON DISCOVERY OF ANY DISCREPANCIES. THE CONTRACTOR ASSUMES ALL LIABILITY FOR FAILURE TO COMPLY WITH THIS PROVISION.
- C. THE EXTENT OF THE WORK IS INDICATED BY THE DRAWINGS, SCHEDULES, AND SPECIFICATIONS AND IS SUBJECT TO THE TERMS AND CONDITIONS OF THE CONTRACT. THE WORK SHALL CONSIST OF FURNISHING ALL LABOR, EQUIPMENT, MATERIALS AND SUPPLIES NECESSARY FOR A COMPLETE AND OPERATIONAL ELECTRICAL SYSTEM. THE WORK SHALL ALSO INCLUDE THE COMPLETION OF ALL ELECTRICAL WORK NOT MENTIONED OR SHOWN WHICH ARE NECESSARY FOR SUCCESSFUL OPERATION OF ALL SYSTEMS.
- D. THE CONTRACTOR SHALL PREPARE A BID FOR A COMPLETE AND OPERATIONAL SYSTEM, WHICH INCLUDES THE COST FOR MATERIAL AND LABOR.
- E. WORKMANSHIP AND NEAT APPEARANCE SHALL BE AS IMPORTANT AS THE OPERATION. DEFECTIVE OR DAMAGED MATERIALS SHALL BE REPLACED OR REPAIRED PRIOR TO FINAL ACCEPTANCE IN A MANNER ACCEPTABLE TO OWNER AND ENGINEER.
- F. COMPLETE THE ENTIRE INSTALLATION AS SOON AS THE PROGRESS OF THE WORK WILL PERMIT. ARRANGE ANY OUTAGE OF SERVICE WITH THE OWNER AND BUILDING MANAGER IN ADVANCE. MINIMIZE DOWNTIME ON THE BUILDING ELECTRICAL SYSTEM.
- G. THE ENTIRE ELECTRICAL SYSTEM INSTALLED UNDER THIS CONTRACT SHALL BE DELIVERED IN PROPER WORKING ORDER. REPLACE, WITHOUT ADDITIONAL COST TO THE OWNER, ANY DEFECTIVE MATERIAL AND EQUIPMENT WITHIN ONE YEAR FROM THE DATE OF FINAL ACCEPTANCE.
- H. ANY ERROR, OMISSION OR DESIGN DISCREPANCY ON THE DRAWINGS SHALL BE BROUGHT TO THE ATTENTION OF THE ENGINEER FOR CLARIFICATION OR CORRECTION BEFORE CONSTRUCTION.
- I. "PROVIDE": INDICATES THAT ALL ITEMS ARE TO BE FURNISHED, INSTALLED AND CONNECTED IN PLACE.
- J. CONTRACTOR SHALL SECURE ALL NECESSARY BUILDING PERMITS AND PAY ALL REQUIRED FEES.

EQUIPMENT LOCATION

- A. THE DRAWINGS INDICATE DIAGRAMMATICALLY THE DESIRED LOCATIONS OR ARRANGEMENTS OF CONDUIT RUNS, OUTLETS, EQUIPMENT, ETC., AND ARE TO BE FOLLOWED AS CLOSELY AS POSSIBLE. PROPER JUDGMENT MUST BE EXERCISED IN EXECUTING THE WORK SO AS TO SECURE THE BEST POSSIBLE INSTALLATION IN THE AVAILABLE SPACE AND TO OVERCOME LOCAL DIFFICULTIES DUE TO SPACE LIMITATIONS OR INTERFERENCE OF STRUCTURE CONDITIONS ENCOUNTERED.
- B. IN THE EVENT CHANGES IN THE INDICATED LOCATIONS OR ARRANGEMENTS ARE NECESSARY, DUE TO FIELD CONDITIONS IN THE BUILDING CONSTRUCTION OR REARRANGEMENT OF FURNISHINGS OR EQUIPMENT, SUCH CHANGES SHALL BE MADE WITHOUT COST, PROVIDING THE CHANGE IS ORDERED BEFORE THE CONDUIT RUNS, ETC., AND WORK DIRECTLY CONNECTED TO THE SAME IS INSTALLED AND NO EXTRA MATERIALS ARE REQUIRED.
- C. LIGHTING FIXTURES ARE SHOWN IN THEIR APPROXIMATE LOCATIONS ONLY. COORDINATE THE FIXTURE LOCATION WITH MECHANICAL EQUIPMENT TO AVOID INTERFERENCE.
- D. COORDINATE THE WORK OF THIS SECTION WITH THAT OF ALL OTHER TRADES. WHERE CONFLICTS OCCUR, CONSULT WITH THE RESPECTIVE CONTRACTOR AND COME TO AGREEMENT AS TO CHANGES NECESSARY. OBTAIN WRITTEN ACCEPTANCE FROM ENGINEER FOR THE PROPOSED CHANGES BEFORE PROCEEDING.

SHOP DRAWINGS

- A. SUBMIT SIX (6) COPIES OF SHOP DRAWINGS TO THE ARCHITECT FOR APPROVAL WITHIN 35 DAYS OF AWARD OF CONTRACT. SHOP DRAWINGS SHALL BE SUBMITTED IN A COMPLETE BOUND MANUAL INCLUDING LIGHT FIXTURES, SERVICE METERING, TRANSFER SWITCH, PANELBOARD, AND DISCONNECT SWITCHES. THE CONTRACTOR SHALL VERIFY DIMENSIONS OF EQUIPMENT TO INSURE THAT THEY FIT IN THE DESIGNATED AREA AND COMPLY WITH REQUIREMENTS OF ALL APPLICABLE CODES FOR REQUIRED WORKING CLEARANCES ABOUT ELECTRICAL EQUIPMENT PRIOR TO SUBMITTING SHOP DRAWINGS FOR APPROVAL. DEPARTURE FROM THE ABOVE WILL RESULT IN RE-SUBMITTAL AND DELAYS.

SUBSTITUTIONS

- A. NO SUBSTITUTIONS ARE ALLOWED.

TESTS

- A. BEFORE FINAL ACCEPTANCE OF WORK, THE CONTRACTOR SHALL INSURE THAT ALL EQUIPMENT, SYSTEMS, FIXTURES, ETC., ARE WORKING SATISFACTORILY AND TO THE INTENT OF THE DRAWINGS.

PERMITS

- A. THE CONTRACTOR SHALL BE RESPONSIBLE FOR TAKING OUT AND PAYING FOR ALL THE REQUIRED PERMITS, INSPECTION AND EXAMINATION WITHOUT ADDITIONAL EXPENSE TO THE OWNER.

GROUNDING

- A. THE CONTRACTOR SHALL PROVIDE A COMPLETE, AND APPROVED GROUNDING SYSTEM INCLUDING ELECTRODES. ELECTRODE CONDUCTOR, BONDING CONDUCTORS, AND EQUIPMENT CONDUCTORS AS REQUIRED BY ARTICLE 250 OF NATIONAL ELECTRICAL CODE.

- B. CONDUITS CONNECTED TO EQUIPMENT AND DEVICES SHALL BE METALLICALLY JOINED TOGETHER TO PROVIDE EFFECTIVE ELECTRICAL CONTINUITY.
- C. FEEDERS AND BRANCH CIRCUIT WIRING INSTALLED IN A NONMETALLIC CONDUIT SHALL INCLUDE A CODE SIZED GROUNDING CONDUCTOR HAVING GREEN INSULATION. THE GROUND CONDUCTOR SHALL BE PROPERLY CONNECTED AT BOTH ENDS TO MAINTAIN ELECTRICAL CONTINUITY.
- D. REFER TO GROUND BUS DETAILS. PROVIDE NEW GROUND SYSTEM COMPLETE WITH CONDUCTORS, GROUND ROD AND DESCRIBED TERMINATIONS.
- E. ALL GROUNDING CONDUCTORS SHALL BE SOLIDINNED COPPER AND ANNEALED #8 UNLESS NOTED OTHERWISE.
- F. ALL NON-DIRECT BURIED TELEPHONE EQUIPMENT GROUND CONDUCTORS SHALL BE #2 STRANDED, THHN (GREEN) INSULATION.
- G. ALL GROUND CONNECTIONS SHALL BE MADE WITH "HYGROUND" COMPRESSION SYSTEM BURNDY CONNECTORS EXCEPT WHERE NOTED OTHERWISE.
- H. PAINT AT ALL GROUND CONNECTIONS SHALL BE REMOVED.
- I. GROUNDING SYSTEM RESISTANCE SHALL NOT EXCEED 5 OHMS. IF THE RESISTANCE VALUE IS EXCEEDED, NOTIFY THE OWNER FOR FUTURE INSTRUCTION ON METHODS FOR REDUCING THE RESISTANCE VALUE. SUBMIT TEST REPORTS AND FURNISH TO SMART SMR ONE COMPLETE SET OF PRINTS SHOWING "INSTALLED WORK".

UTILITY SERVICE

- A. TELEPHONE AND ELECTRICAL METERING FACILITIES SHALL CONFORM TO THE REQUIREMENTS OF THE SERVING UTILITY COMPANIES. CONTRACTOR SHALL VERIFY SERVICE LOCATIONS AND REQUIREMENTS. SERVICE INFORMATION WILL BE FURNISHED BY THE SERVING UTILITIES.
- B. CONFORM TO ALL REQUIREMENTS OF THE SERVING UTILITY COMPANIES.

PRODUCTS

- A. ALL MATERIALS SHALL BE NEW, CONFORMING WITH THE NEC, ANSI, NEMA, AND THEY SHALL BE U.L. LISTED AND LABELED.
- B. CONDUIT
1. RIGID CONDUIT SHALL BE U.L. LABEL GALVANIZED ZINC COATED WITH ZINC INTERIOR AND SHALL BE USED WHEN INSTALLED IN OR UNDER CONCRETE SLABS, IN CONTACT WITH THE EARTH, UNDER PUBLIC ROADWAYS, IN MASONRY WALLS OR EXPOSED ON BUILDING EXTERIOR, RIGID CONDUIT IN CONTACT WITH EARTH SHALL BE 1/2 LAPPED WRAPPED WITH HUNTS WRAP PROCESS NO. 3.
2. ELECTRICAL METALLIC TUBING SHALL HAVE U.L. LABEL, FITTINGS SHALL BE COMPRESSION TYPE. EMT SHALL BE USED ONLY FOR INTERIOR RUNS.
3. FLEXIBLE METALLIC CONDUIT SHALL HAVE U.L. LISTED LABEL AND MAY BE USED WHERE PERMITTED BY CODE. FITTINGS SHALL BE "JAKE" OR "SQUEEZE" TYPE. SEAL TIGHT FLEXIBLE CONDUIT. ALL CONDUIT IN EXCESS OF SIX FEET IN LENGTH SHALL HAVE FULL SIZE GROUND WIRE.
4. CONDUIT RUNS MAY BE SURFACE MOUNTED IN CEILING OR WALLS UNLESS INDICATED OTHERWISE. CONDUIT INDICATED SHALL RUN PARALLEL OR AT RIGHT ANGLES TO CEILING, FLOOR OR BEAMS. VERIFY EXACT ROUTING OF ALL EXPOSED CONDUIT WITH ARCHITECT PRIOR TO INSTALLING.
5. ALL UNDERGROUND CONDUITS SHALL BE PVC SCHEDULE 40 (UNLESS NOTED OTHERWISE) AT A MINIMUM DEPTH OF 24" BELOW GRADE.
6. ALL CONDUIT ONLY (C.O.) SHALL HAVE PULL ROPE.
7. CONDUITS RUN ON ROOFS SHALL BE INSTALLED ON 4 X 4 REDWOOD SLEEPERS, 6'-0" ON CENTER, SET IN NON-HARDENING MASTIC.
- C. ALL WIRE AND CABLE SHALL BE COPPER, 600 VOLT, #12 AWG MINIMUM UNLESS SPECIFICALLY NOTED OTHERWISE ON THE DRAWINGS. CONDUCTORS #10 AWG AND SMALLER SHALL BE SOLID. CONDUCTORS #8 AWG AND LARGER SHALL BE STRANDED. TYPE THHN INSULATION USED UNLESS CONDUCTORS INSTALLED IN CONDUIT EXPOSED TO WEATHER, IN WHICH CASE TYPE THWN INSULATION SHALL BE USED.
- D. PROVIDE GALVANIZED COATED STEEL BOXES AND ACCESSORIES SIZED PER CODE TO ACCOMMODATE ALL DEVICES AND WIRING.
- E. DUPLEX RECEPTACLES SHALL BE SPECIFICATION GRADE WITH WHITE FINISH (UNLESS NOTED BY ENGINEER), 20 AMP, 125 VOLT, THREE WIRE GROUNDING TYPE, NEMA 5-20R, MOUNT RECEPTACLE AT +12" ABOVE FINISHED FLOOR UNLESS OTHERWISE INDICATED ON DRAWINGS OR IN DETAILS. WEATHERPROOF RECEPTACLES SHALL BE GROUND FAULT INTERRUPTER TYPE WITH SIERRA #WPD-8 LIFT COVERPLATES.
- F. TOGGLE SWITCHES SHALL BE 20 AMP, 120 VOLT AC, SPECIFICATION GRADE WHITE (UNLESS NOTED OTHERWISE) FINISH. MOUNT SWITCHES AT +48" ABOVE FINISHED FLOOR.
- G. PANELBOARDS SHALL BE DEAD FRONT SAFETY TYPE WITH ANTI-BURN SOLDERLESS COMPRESSION APPROVED FOR COPPER CONDUCTORS, COPPER BUS BARS, FULL SIZED NEUTRAL BUS, GROUND BUS AND EQUIPPED WITH QUICK- MAKE QUICK-BREAK BOLT-IN TYPE THERMAL MAGNETIC CIRCUIT BREAKERS. MOUNT TOP OF THE PANELBOARDS AT 6'-3" ABOVE FINISHED FLOOR. PROVIDE TYPEWRITTEN CIRCUIT DIRECTORY.
- H. ALL CIRCUIT BREAKERS, MAGNETIC STARTERS AND OTHER ELECTRICAL EQUIPMENT SHALL HAVE AN INTERRUPTING RATING NOT LESS THAN MAXIMUM SHORT CIRCUIT CURRENT TO WHICH THEY MAY BE SUBJECTED.
- I. GROUND RODS SHALL BE COPPER CLAD STEEL, 5/8" ROUND AND 10' LONG. COPPER WELD OR APPROVED EQUAL.

INSTALLATION

- A. PROVIDE SUPPORTING DEVICES FOR ALL ELECTRICAL EQUIPMENT, FIXTURES, BOXES, PANEL, ETC., SUPPORT LUMINARIES FROM UNDERSIDE OF STRUCTURAL CEILING. EQUIPMENT SHALL BE BRACED TO WITHSTAND HORIZONTAL FORCES IN ACCORDANCE WITH STATE AND LOCAL CODE REQUIREMENTS. PROVIDE PRIOR ALIGNMENT AND LEVELING OF ALL DEVICES AND FIXTURES.
- B. CUTTING, PATCHING, CHASES, OPENINGS: PROVIDE LAYOUT IN ADVANCE TO ELIMINATE UNNECESSARY CUTTING OR DRILLING OF WALLS, FLOORS, CEILINGS, AND ROOFS. ANY DAMAGE TO BUILDING STRUCTURE OR EQUIPMENT SHALL BE REPAIRED BY THE CONTRACTOR. OBTAIN PERMISSION FROM THE ENGINEER BEFORE CORING.
- C. IN DRILLING HOLES INTO CONCRETE WHETHER FOR FASTENING OR ANCHORING PURPOSES, OR PENETRATIONS THROUGH THE FLOOR FOR CONDUIT RUNS, PIPE RUNS, ETC., IT MUST BE CLEARLY UNDERSTOOD THAT TENDONS AND/OR REINFORCING STEEL WILL NOT BE DRILLED INTO, CUT OR DAMAGED UNDER ANY CIRCUMSTANCES.
- D. LOCATION OF TENDONS AND/OR REINFORCING STEEL ARE NOT DEFINITELY KNOWN AND THEREFORE, MUST BE SEARCHED FOR BY APPROPRIATE METHODS AND EQUIPMENT VIA X-RAY OR OTHER DEVICES THAT CAN ACCURATELY LOCATE THE REINFORCING AND/OR STEEL TENDONS.
- E. PENETRATIONS IN FIRE RATED WALLS SHALL BE FIRE STOPPED IN ACCORDANCE WITH THE REQUIREMENTS OF THE C.B.C.

PROJECT CLOSEOUT

- A. UPON COMPLETION OF WORK, CONDUCT CONTINUITY, SHORT CIRCUIT, AND FALL POTENTIAL GROUNDING TESTS FOR APPROVAL. SUBMIT TEST REPORTS TO PROJECT MANAGER. CLEAN PREMISES OF ALL DEBRIS RESULTING FROM WORK AND LEAVE WORK IN A COMPLETE AND UNDAMAGED CONDITION.
- B. PROVIDE PROJECT MANAGER WITH ONE SET OF COMPLETE ELECTRICAL "AS INSTALLED" DRAWINGS AT THE COMPLETION OF THE JOB, SHOWING ACTUAL DIMENSIONS, ROUTINGS AND CIRCUITS.
- C. ALL BROCHURES, OPERATING MANUALS, CATALOG, SHOP DRAWINGS, ETC., SHALL BE TURNED OVER TO OWNER AT JOB COMPLETION.

GROUNDING NOTES

1. ALL DETAILS ARE SHOWN IN GENERAL TERMS. ACTUAL GROUNDING INSTALLATION REQUIREMENTS AND CONSTRUCTION ACCORDING TO SITE CONDITIONS.
2. ALL GROUNDING CONDUCTORS: #2 AWG SOLID BARE TINNED COPPER WIRE UNLESS OTHERWISE NOTED.
3. GROUND BAR LOCATED IN BASE OF EQUIPMENT WILL BE PROVIDED, FURNISHED AND INSTALLED BY THE VENDOR.
4. ALL BELOW GRADE CONNECTIONS: EXOTHERMIC WELD TYPE, ABOVE GRADE CONNECTIONS: EXOTHERMIC WELD TYPE.
5. GROUND RING SHALL BE LOCATED A MINIMUM OF 24" BELOW GRADE OR 6" MINIMUM BELOW THE FROST LINE.
6. INSTALL GROUND CONDUCTORS AND GROUND ROD MINIMUM OF 1'-0" FROM EQUIPMENT CONCRETE SLAB, SPREAD FOOTING, OR FENCE.
7. EXOTHERMIC WELD GROUND CONNECTION TO FENCE POST: TREAT WITH A COLD GALVANIZED SPRAY.
8. GROUND BARS:
- 8.1. EQUIPMENT GROUND BUS BAR (EGB) LOCATED AT BOTTOM OF ANTENNA POLE/MAST FOR MAKING GROUNDING JUMPER CONNECTIONS TO COAX FEEDER CABLES SHALL BE FURNISHED AND INSTALLED BY ELECTRICAL CONTRACTOR. JUMPERS (FURNISHED BY OWNERS) SHALL BE INSTALLED AND CONNECTED BY ELECTRICAL CONTRACTOR.
- 8.2. MAIN GROUND BUS BAR (MGB) LOCATED NEAR THE BASE OF THE RADIO EQUIPMENT CABINET(S) SHALL BE FURNISHED AND INSTALLED BY ELECTRICAL CONTRACTOR.
9. ALL GROUNDING INSTALLATIONS AND CONNECTIONS SHALL BE MADE BY ELECTRICAL CONTRACTOR.
10. OBSERVE N.E.C. AND LOCAL UTILITY REQUIREMENTS FOR ELECTRICAL SERVICE GROUNDING.
11. GROUNDING ATTACHMENT TO TOWER SHALL BE AS PER MANUFACTURER'S RECOMMENDATIONS OR AT GROUNDING POINTS PROVIDED (2 MINIMUM).
12. IF EQUIPMENT IS IN A C.L. FENCE ENCLOSURE, GROUND ONLY CORNER POSTS AND SUPPORT POSTS OF GATE. IF CHAIN LINK LID IS USED, THEN GROUND LID ALSO.
13. GROUNDING @ PPC CABINET SHALL BE VERTICALLY INSTALLED.
14. ALL GROUNDING FOR ANTENNAS SHALL BE CONNECTED SO THAT IT WILL BY-PASS MAIN BUSS BAR.
15. ALL EMT RUNS SHALL BE GROUNDED AND HAVE A BUSHING. NO PVC ABOVE GROUND.
16. USE SEPARATE HOLES FOR GROUNDING @ BUSS BAR. NO "DOUBLING-UP" OF LUGS.
17. POWER AND TELCO CABS. SHALL BE GROUNDED (BONDED) TOGETHER. 18. NO "L AND B" ALLOWED ON GROUNDING.
18. PROVIDE STAINLESS STEEL CLAM AND BRASS TAGS ON COAX @ ANTENNAS AND DOGHOUSE.



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NOT FOR
CONSTRUCTION

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UNLESS THEY ARE ACTING UNDER THE DIRECTION
OF THE LICENSED PROFESSIONAL ENGINEER,
TO ALTER THIS DOCUMENT.

DRAWN BY:	UTILITIES CHECKED BY:	A&E CHECKED BY:
DW/AS	GD	RB

CONSTRUCTION
DRAWINGS

SUBMITTALS		
REV	DATE	DESCRIPTION
A	04/26/24	90% CONSTRUCTION DRAWINGS
B	08/29/24	JX COMMENTS
0	03/12/24	100% CONSTRUCTION DRAWINGS

PROJECT INFORMATION

CLL05463

1700 N. TOWNE AVE.
CLAREMONT, CA 91711

SHEET TITLE

ELECTRICAL NOTES

SHEET NUMBER



E-3

EUKON AT&T_90CD_MONOPOLE_TEMPLATE_V2_11-18-22

EXOTHERMIC	■
COMPRESSION TYPE CONNECTIONS	●
CHEMICAL ELECTROLYTIC GROUNDING SYSTEM	⊗
GROUND ROD	⏏
GROUND ROD WITH INSPECTION SLEEVE	⏏
TEST GROUND ROD WITH INSPECTION SLEEVE	⏏
EXOTHERMIC WITH INSPECTION SLEEVE	■
GROUNDING CONDUCTOR	---
GROUNDING BAR	⬢⬢⬢⬢⬢⬢

THIS PLAN IS A SCHEMATIC ONLY AND DOES NOT SHOW ALL THE GROUNDING PROVIDED BY THE SHELTER MANUFACTURER. CONTRACTOR SHALL NOTIFY AT&T IF ANY GROUNDING TO BE PROVIDED IS INCOMPLETE OR MISSING.

NOTE:
CONTRACTOR TO IMPLEMENT ALL GROUNDING REQUIREMENTS AS SPECIFIED BY CARRIER CONSTRUCTION AND INSTALLATION GUIDELINES.

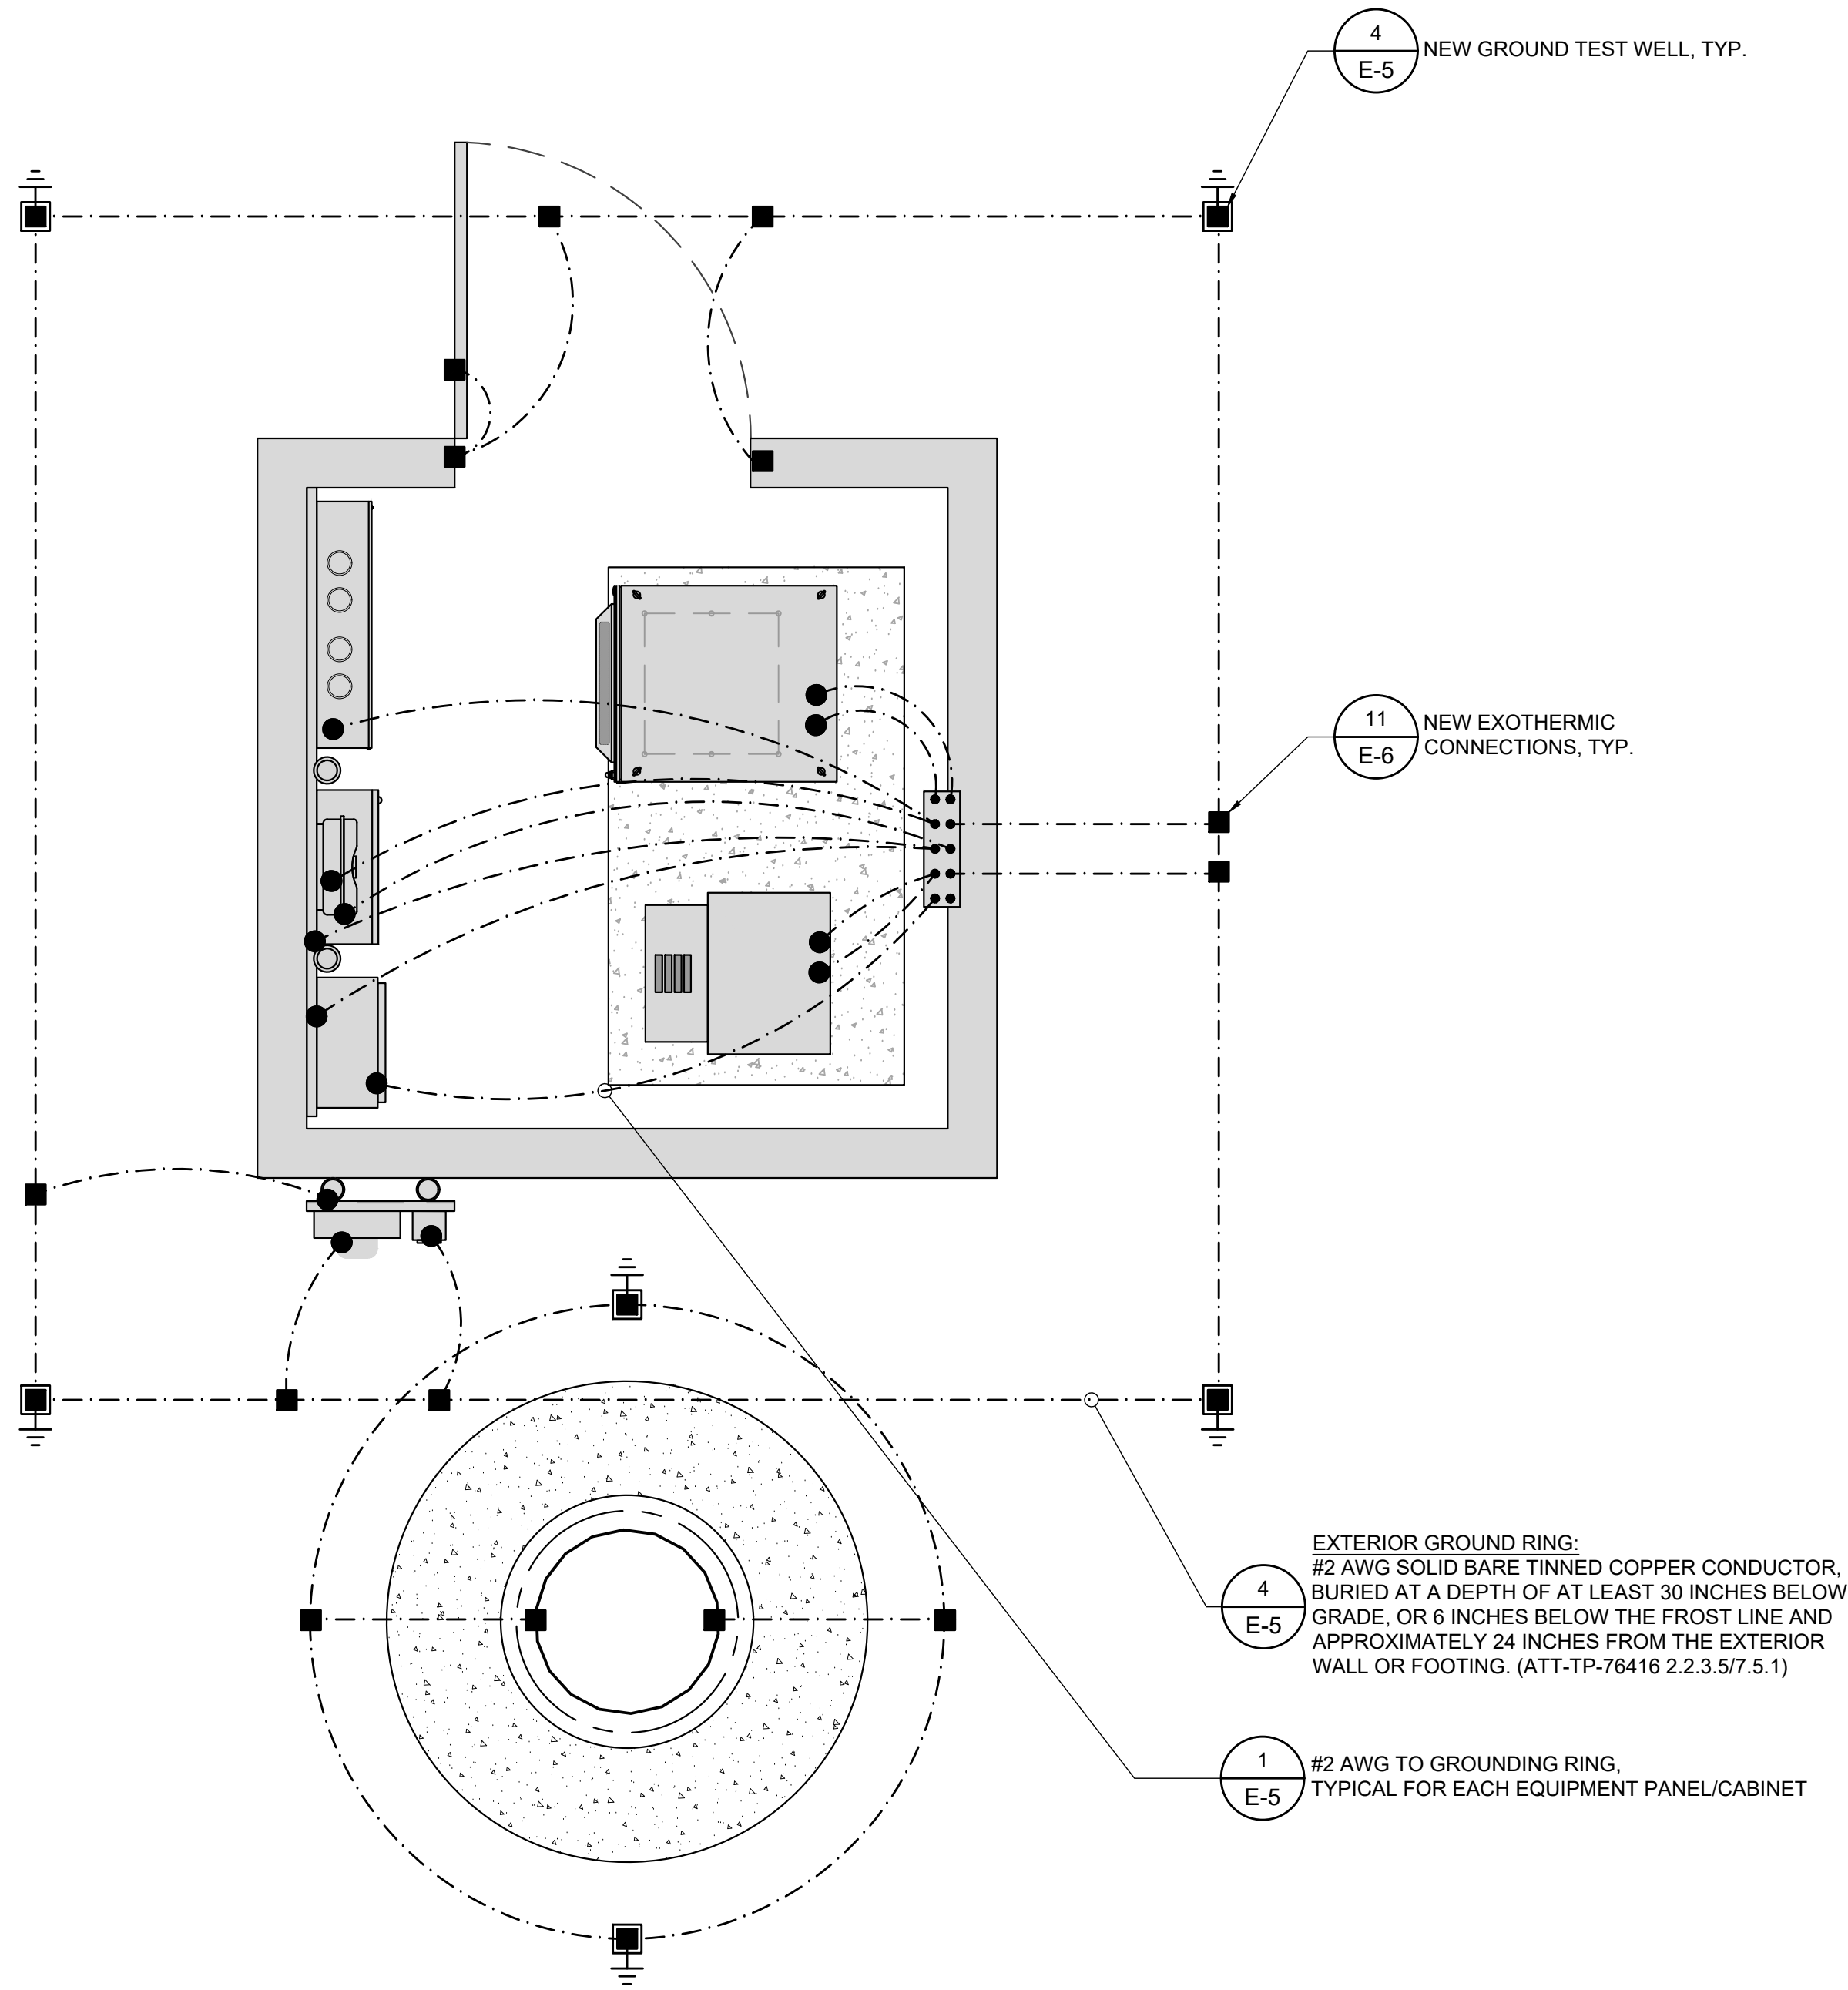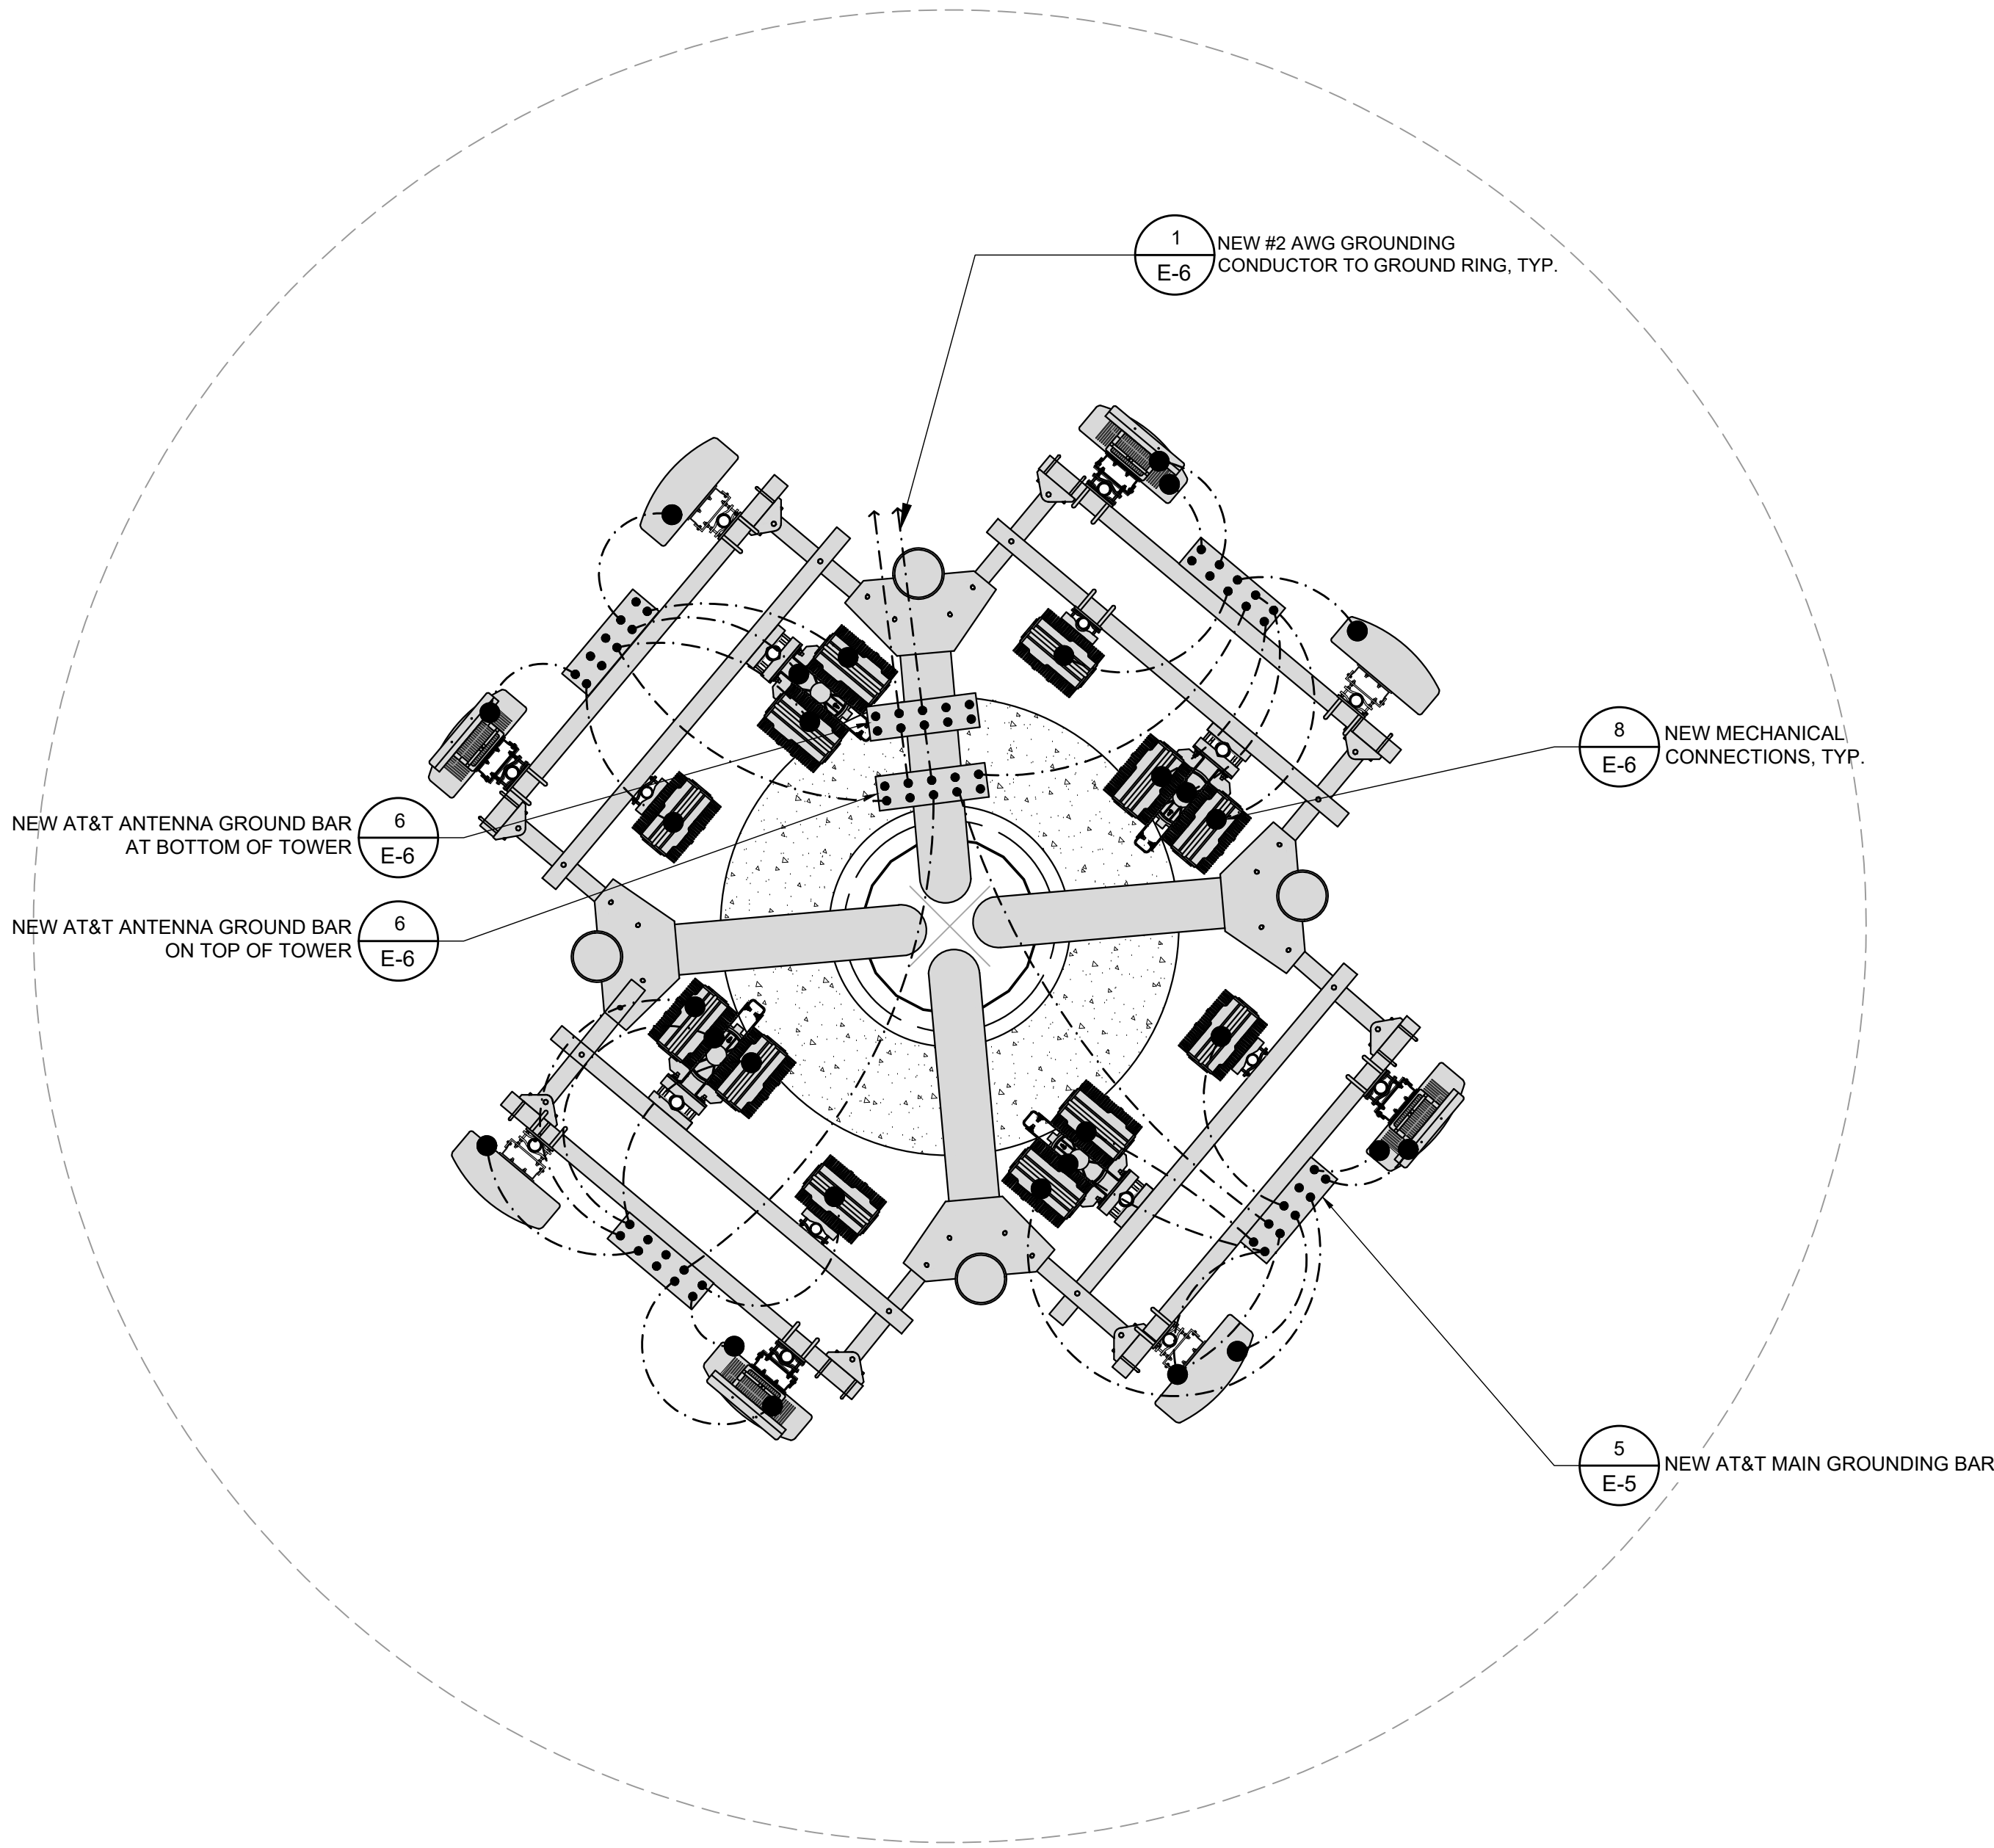

1452 EDINGER AVE.
3RD FLOOR
TUSTIN, CA 92780



65 POST, SUITE 1000
IRVINE, CA 92618
TEL: (949) 553-8566
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DW/AS	GD	RB

CONSTRUCTION DRAWINGS

SUBMITTALS		
REV	DATE	DESCRIPTION
A	04/26/24	90% CONSTRUCTION DRAWINGS
B	08/29/24	JX COMMENTS
0	03/12/24	100% CONSTRUCTION DRAWINGS

PROJECT INFORMATION

CLL05463

1700 N. TOWNE AVE.
CLAREMONT, CA 91711

SHEET TITLE

GROUNDING PLANS


SHEET NUMBER

E-4

EUKON AT&T_90CD_MONOPOLE_TEMPLATE_V2_11-18-22




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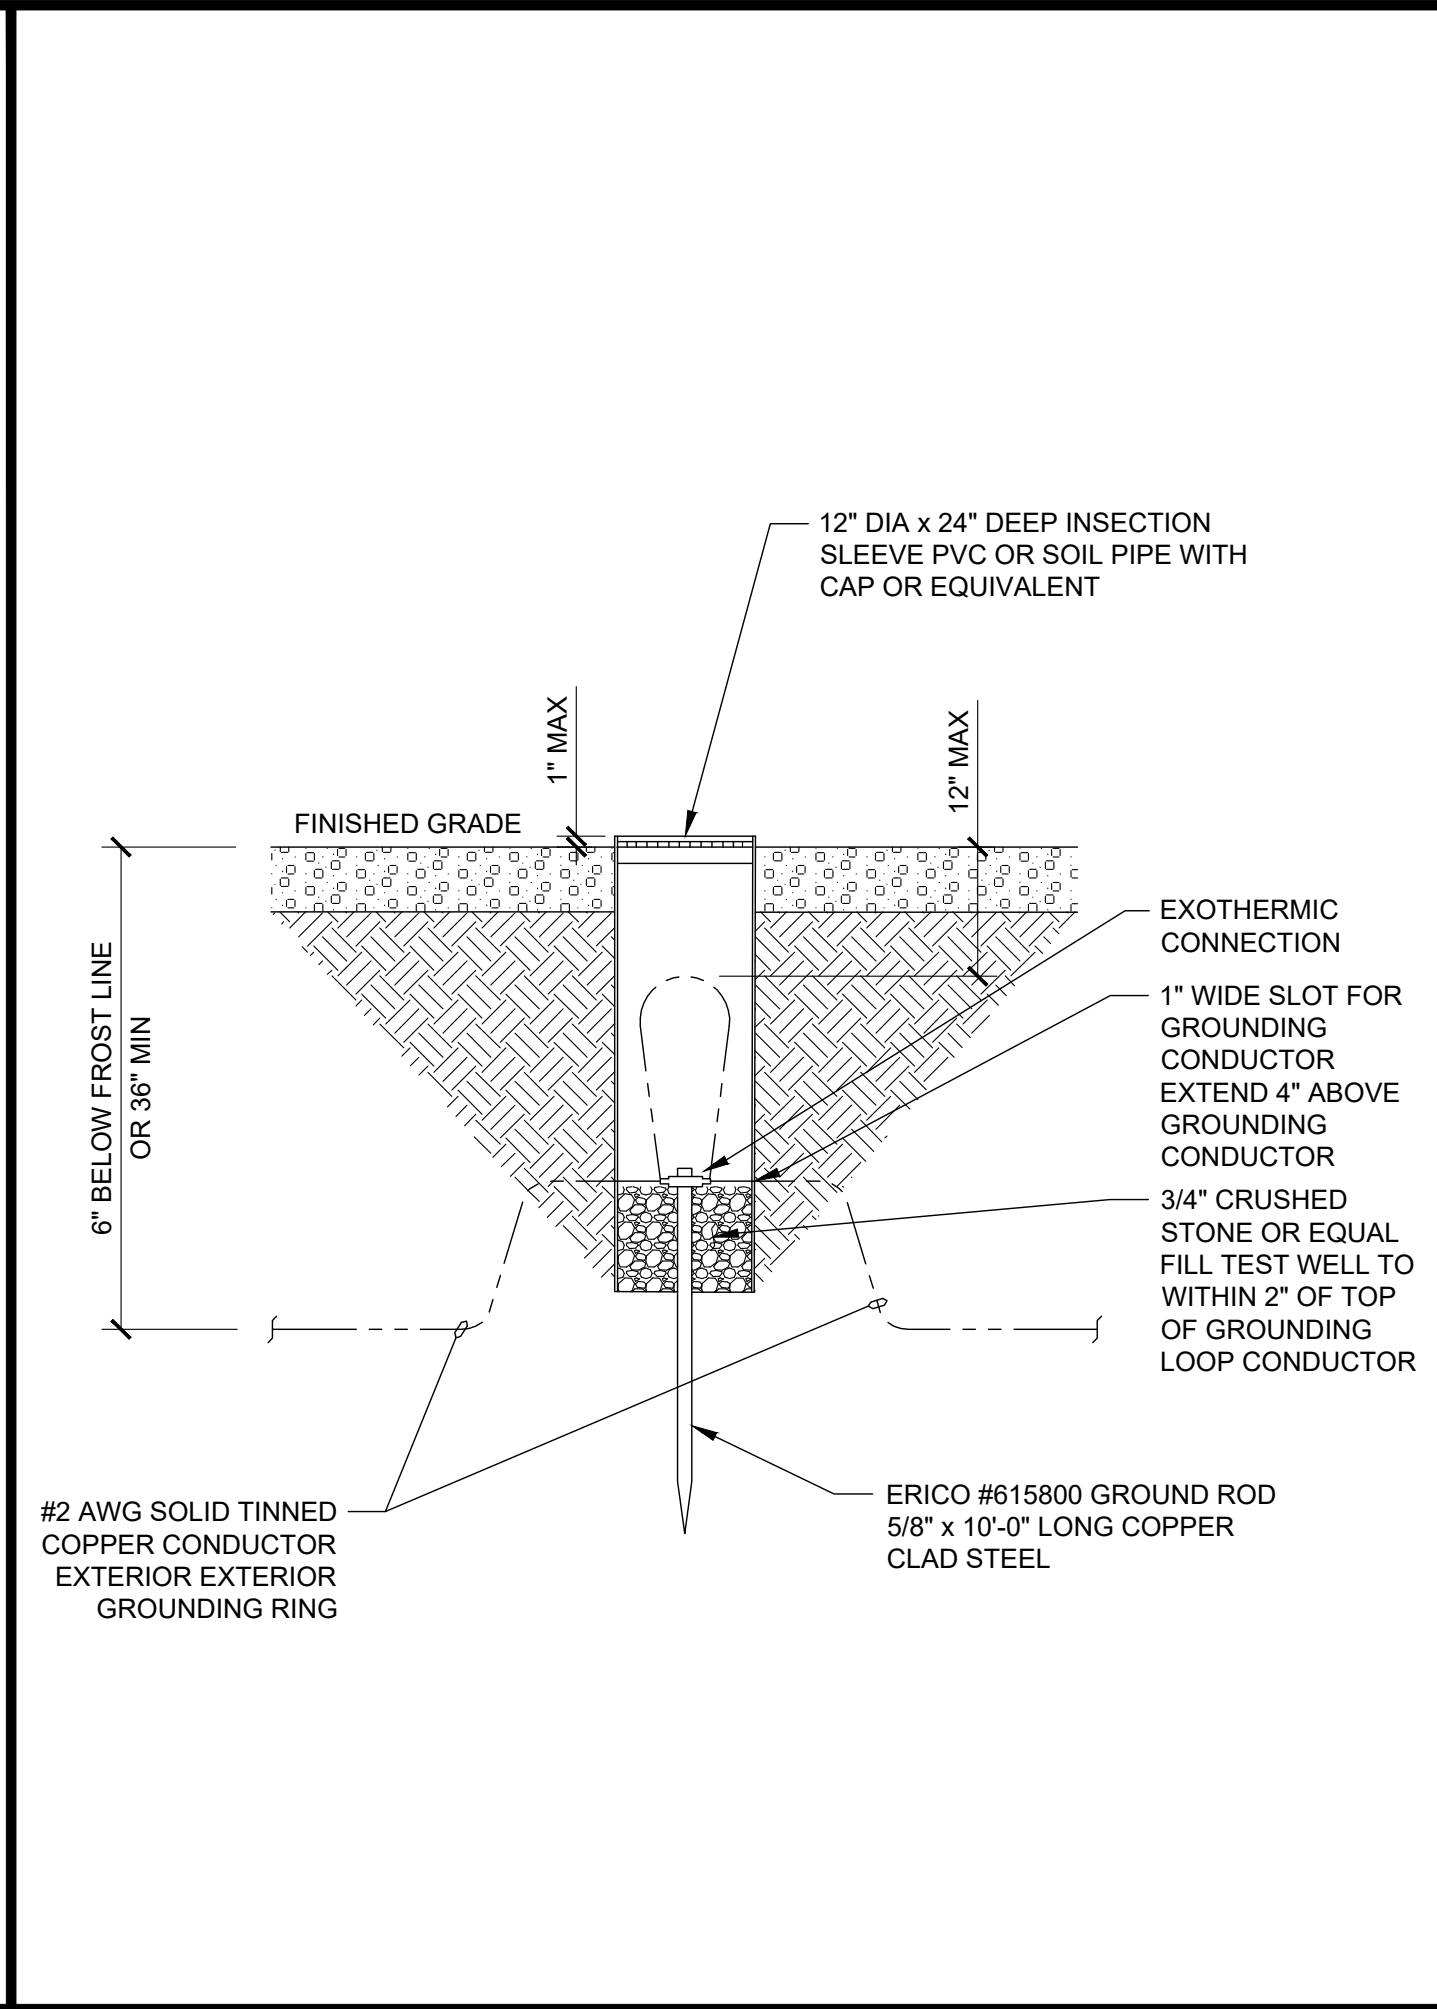
EXTERIOR TWO HOLE LUG

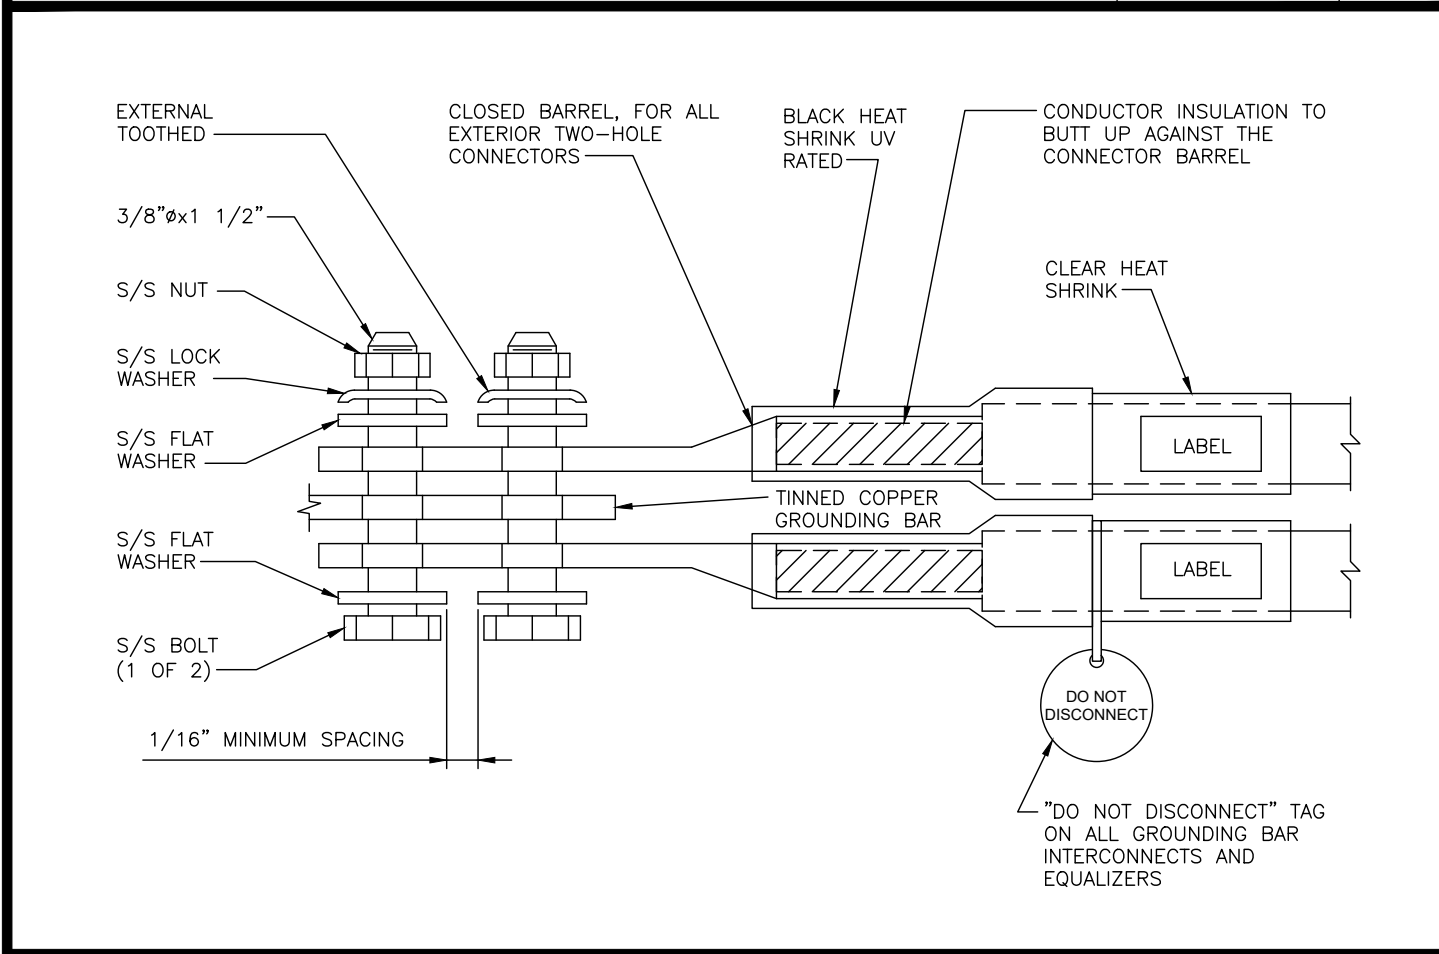SCALE NONE 7




TOWER GROUNDING

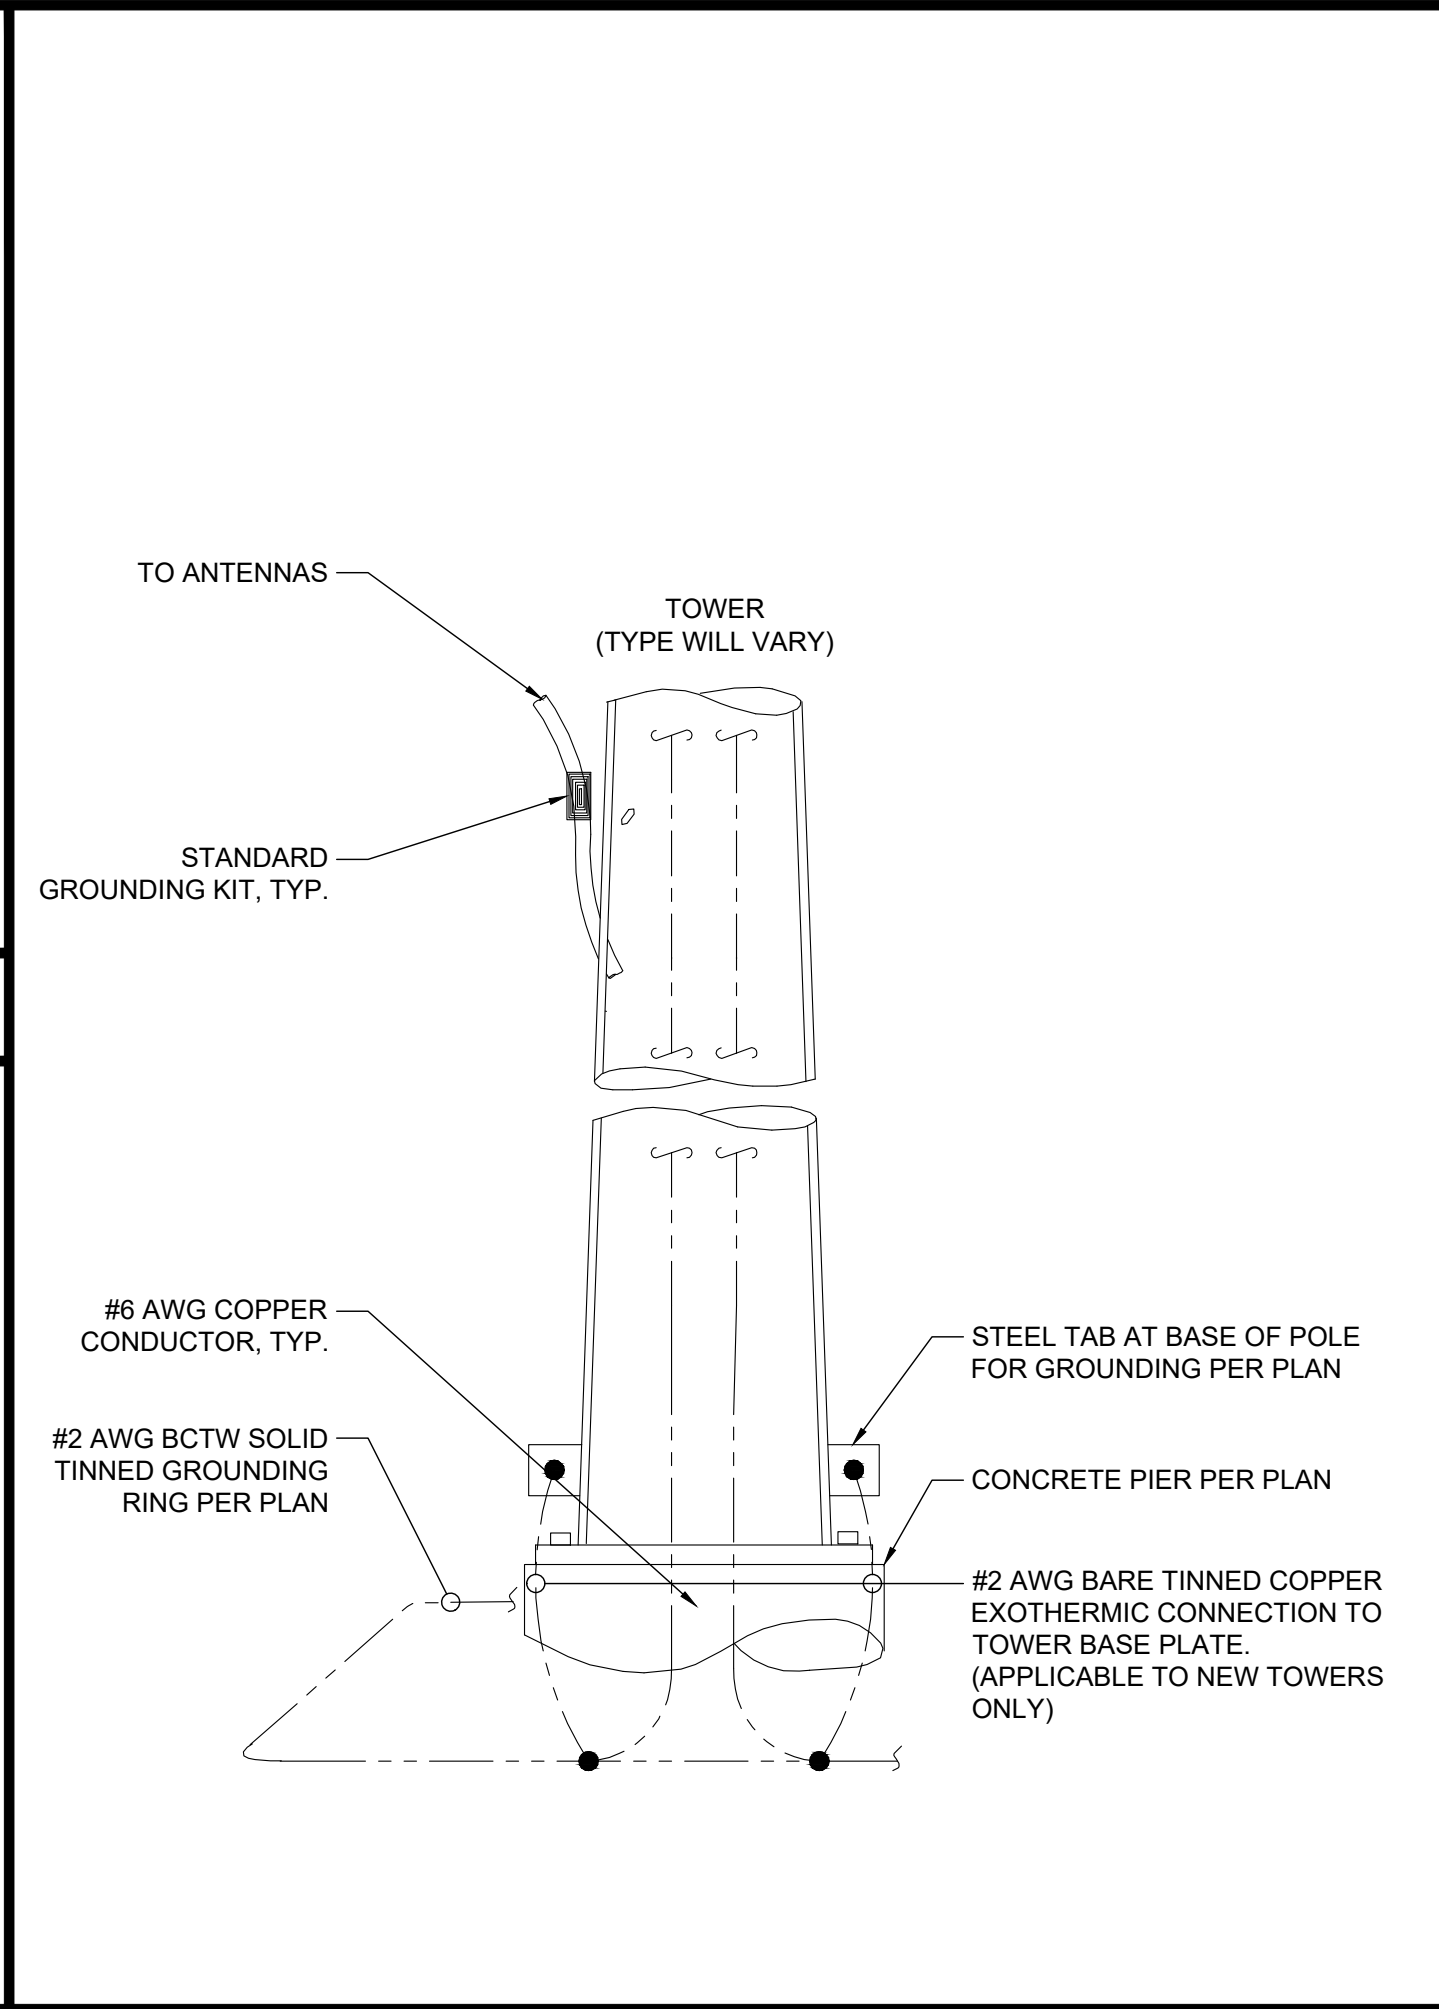SCALE NONE 6




GROUND ROD W/ INSPECTION SLEEVE

SCALE NONE 4

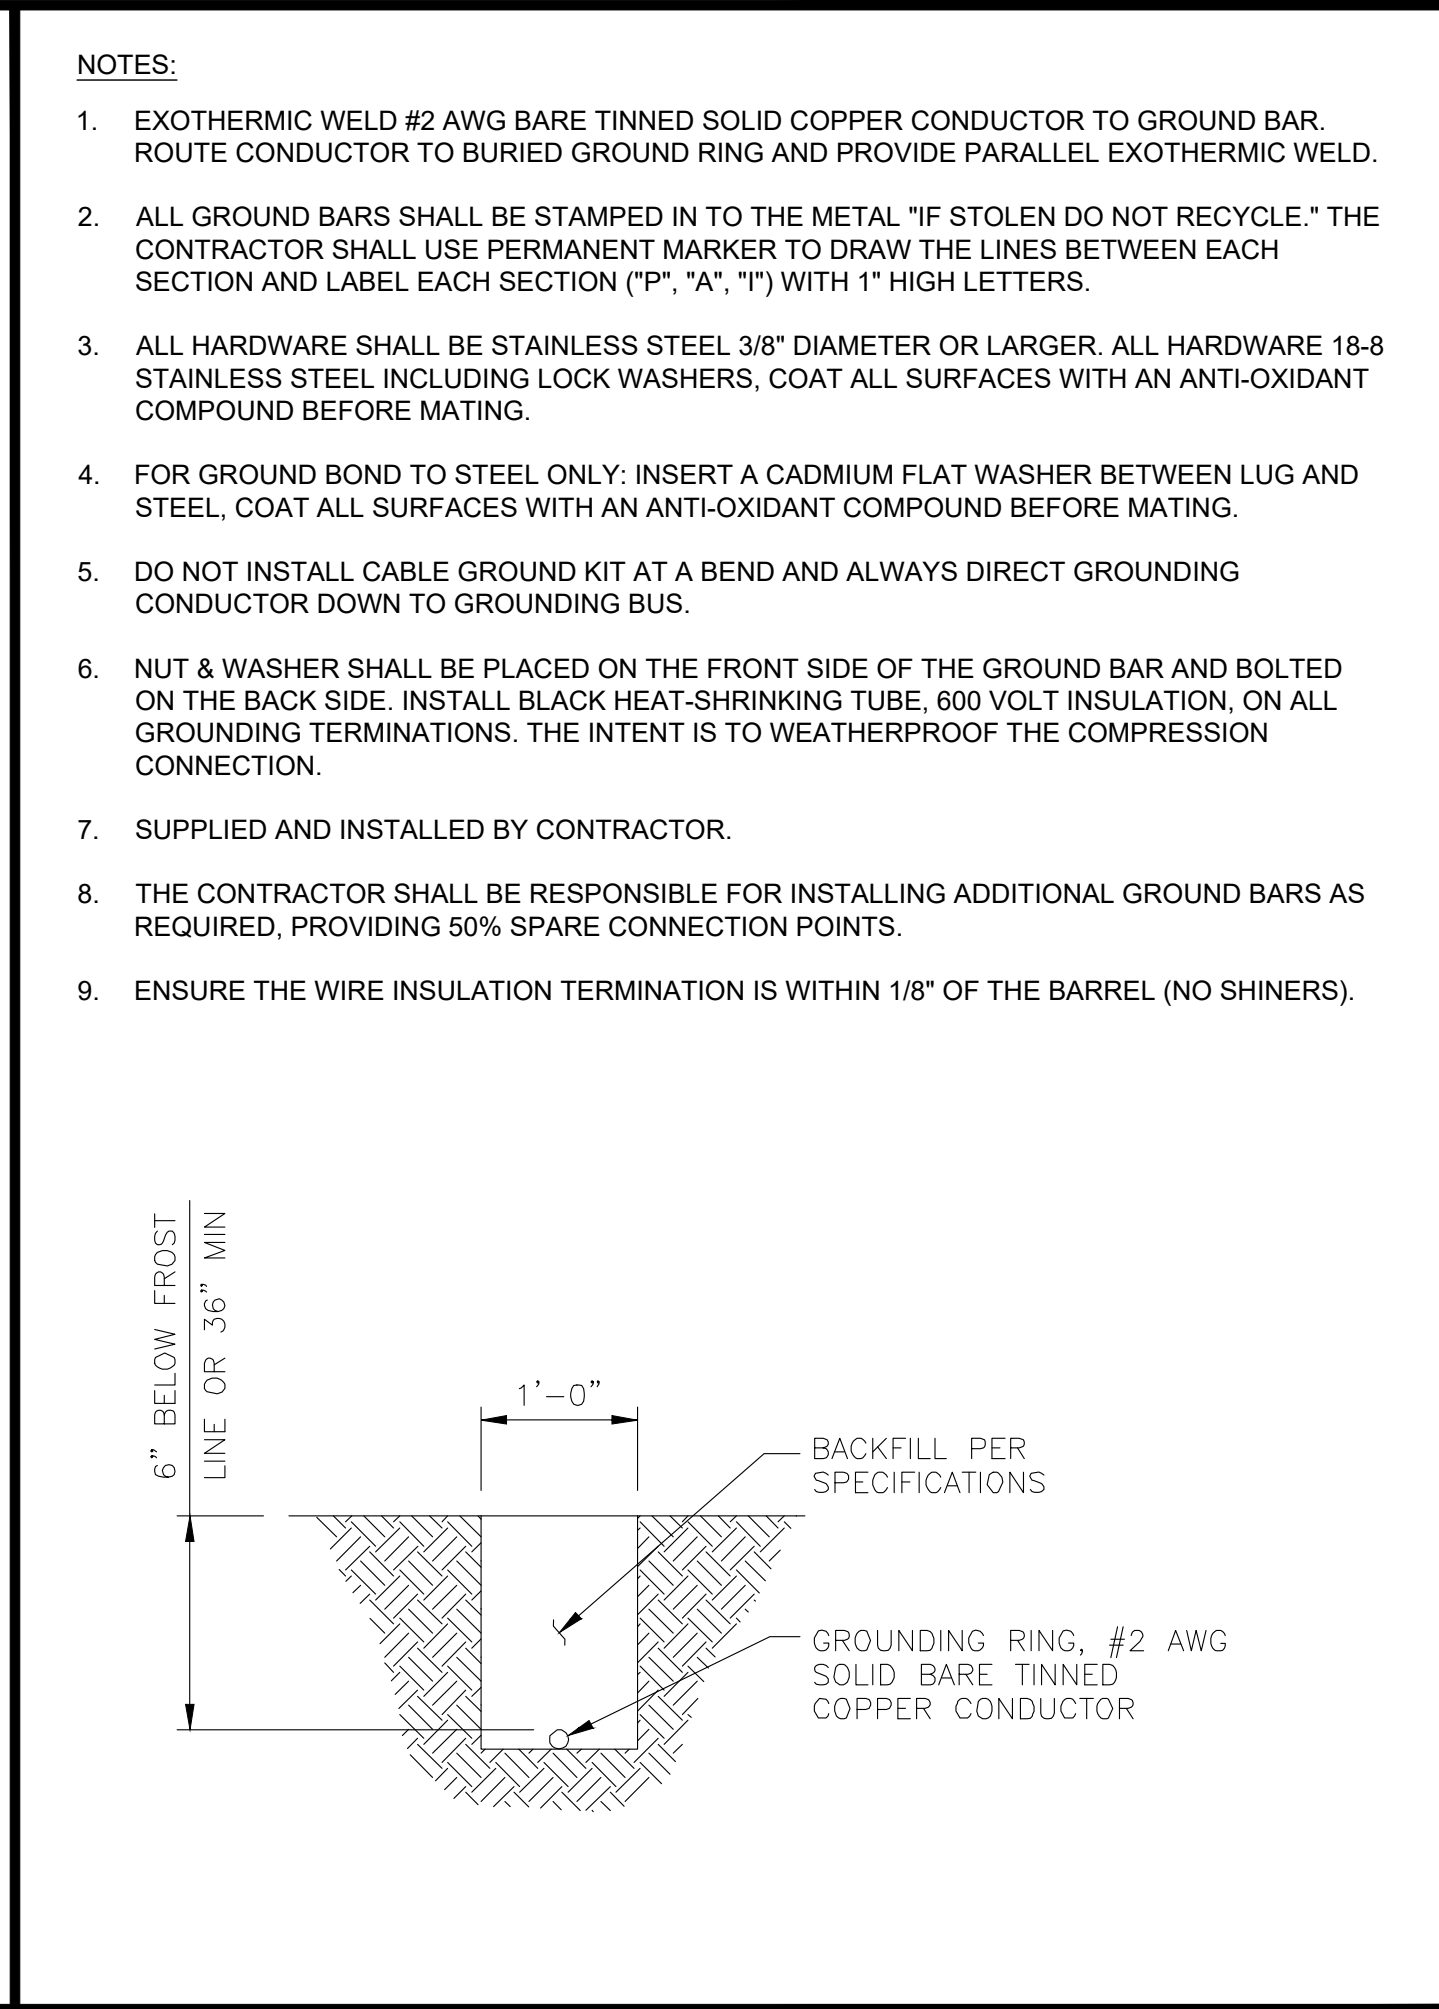

GROUND RING TRENCH

SCALE NONE 2

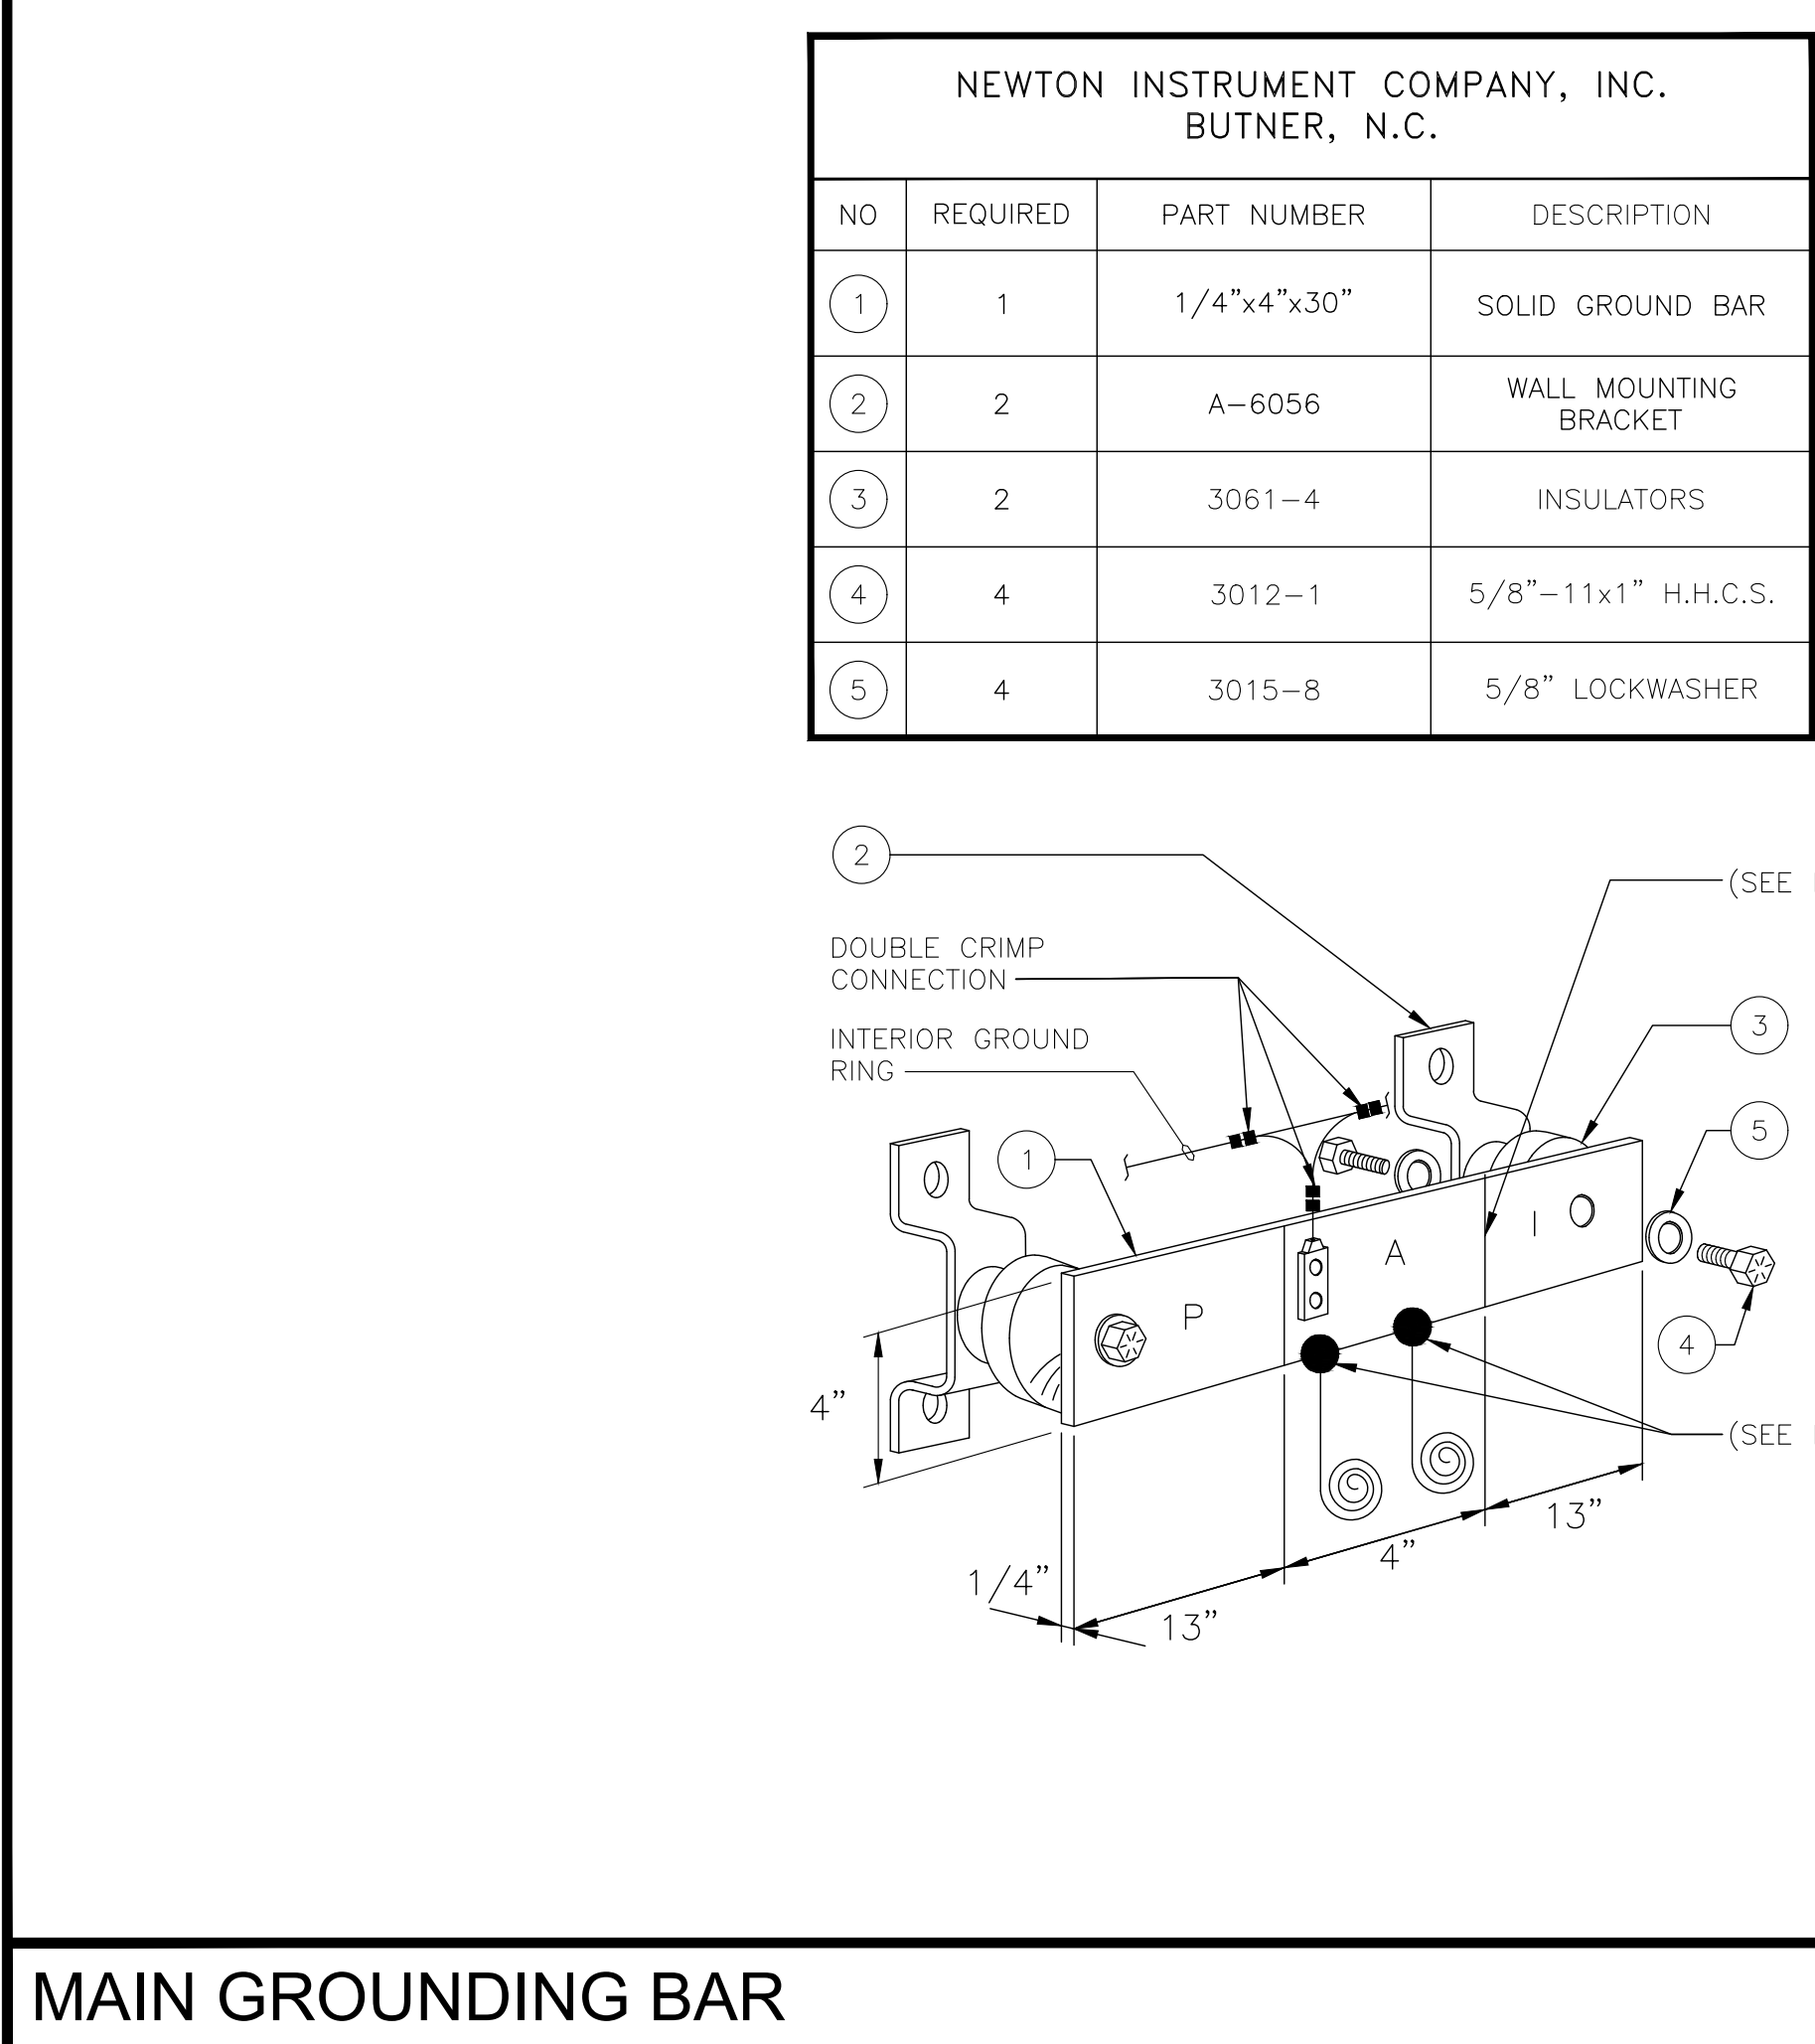


MAIN GROUNDING BAR

SCALE NONE 5




ANTENNA GROUNDING

SCALE NONE 3

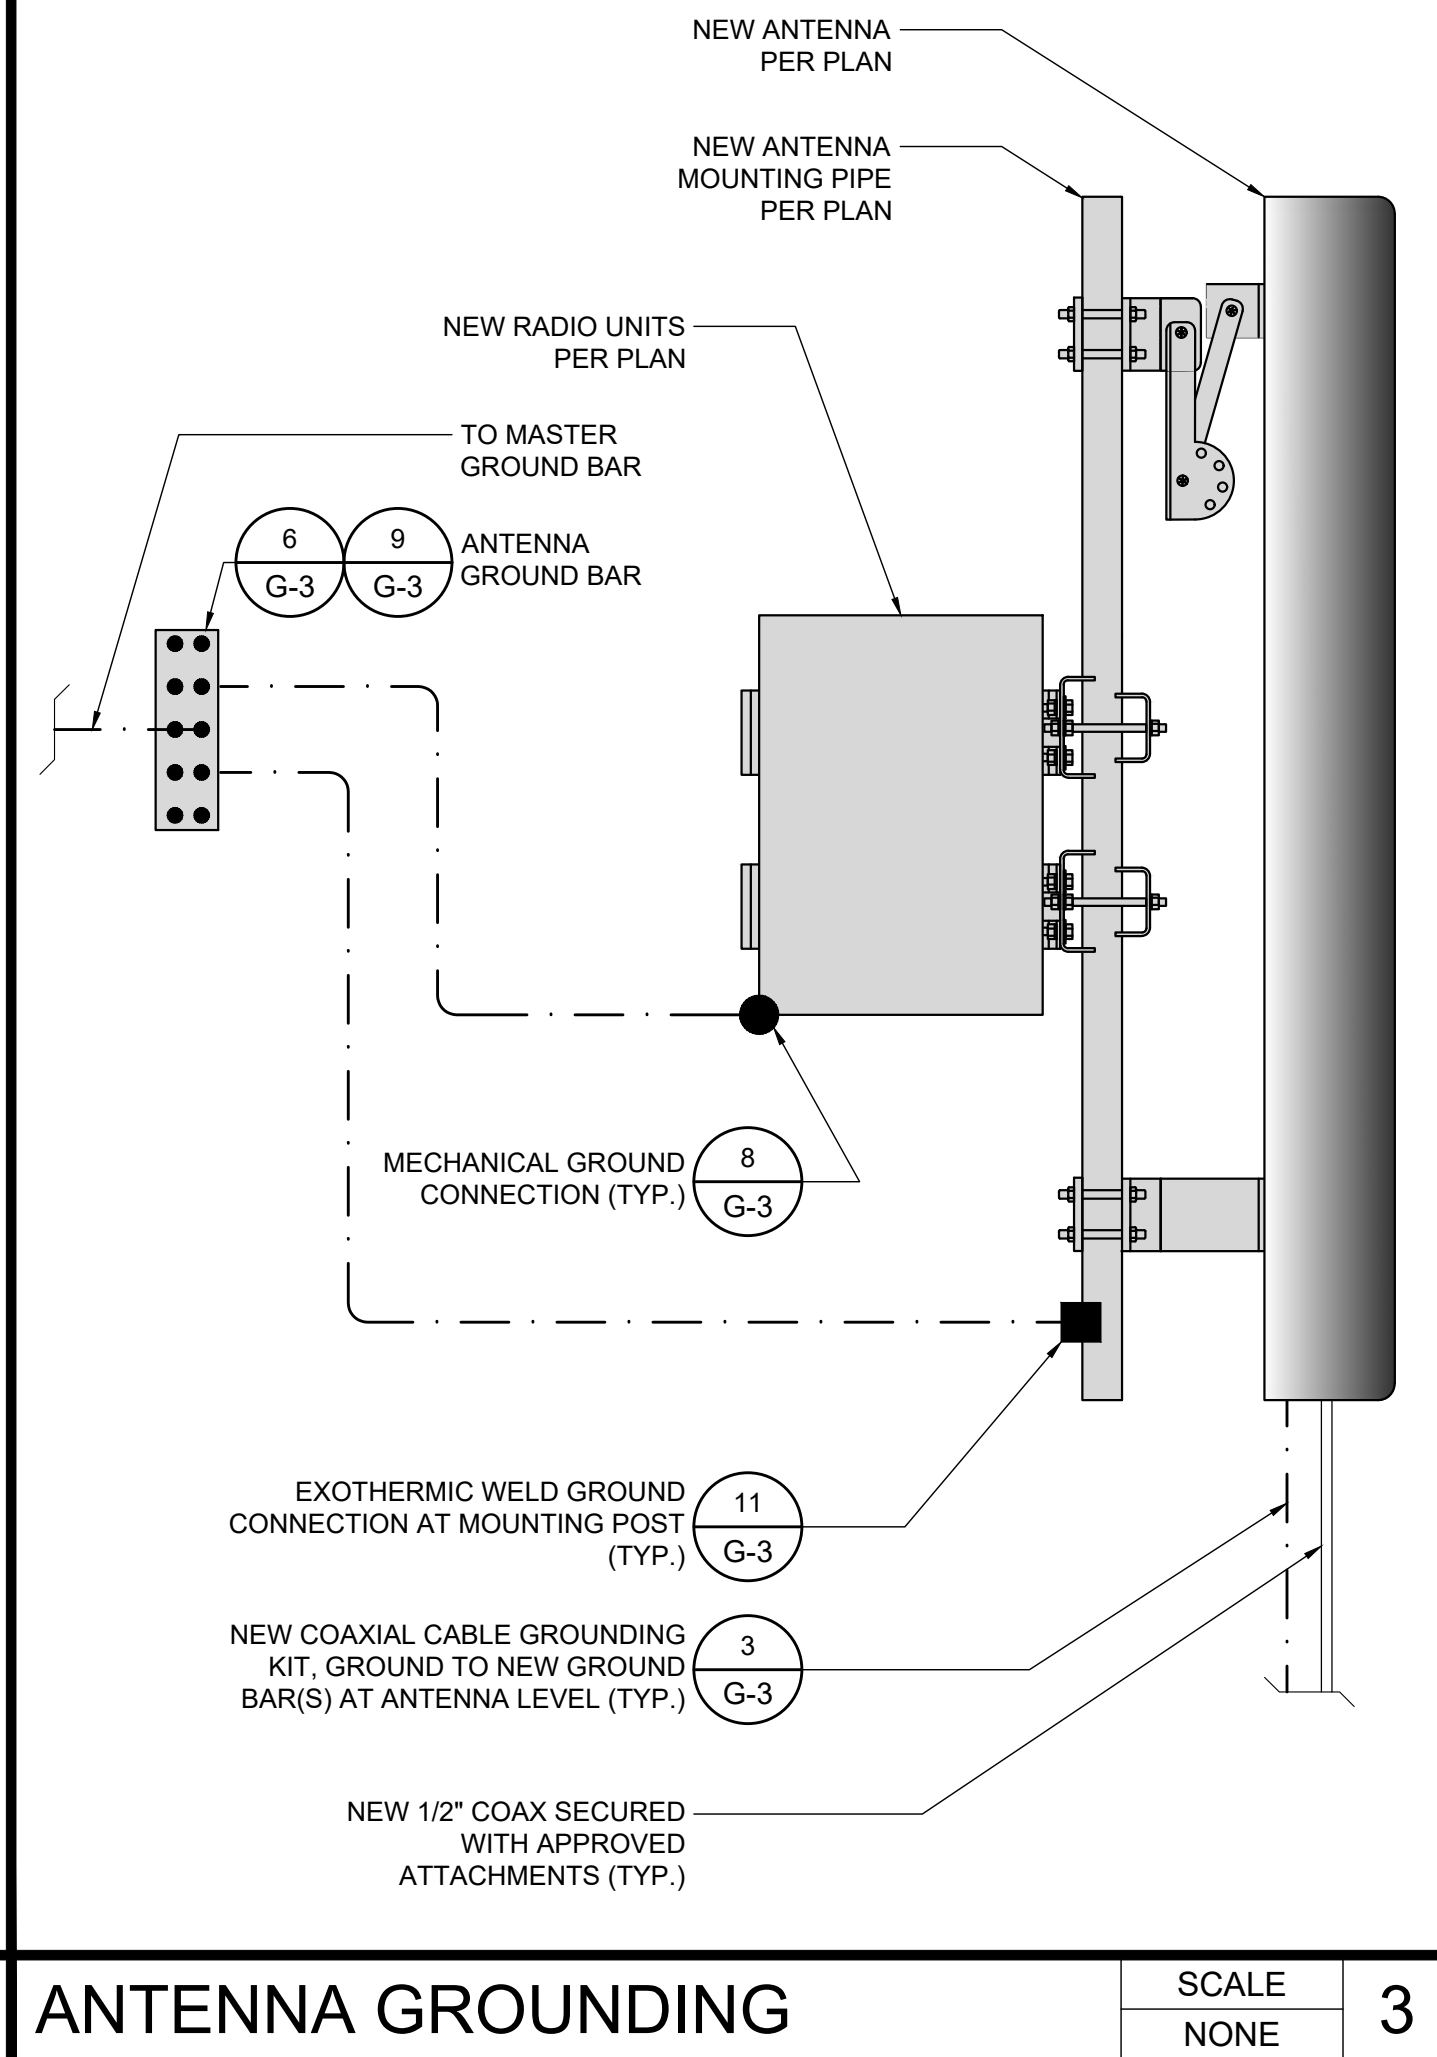


EQUIPMENT GROUNDING

SCALE NONE 1

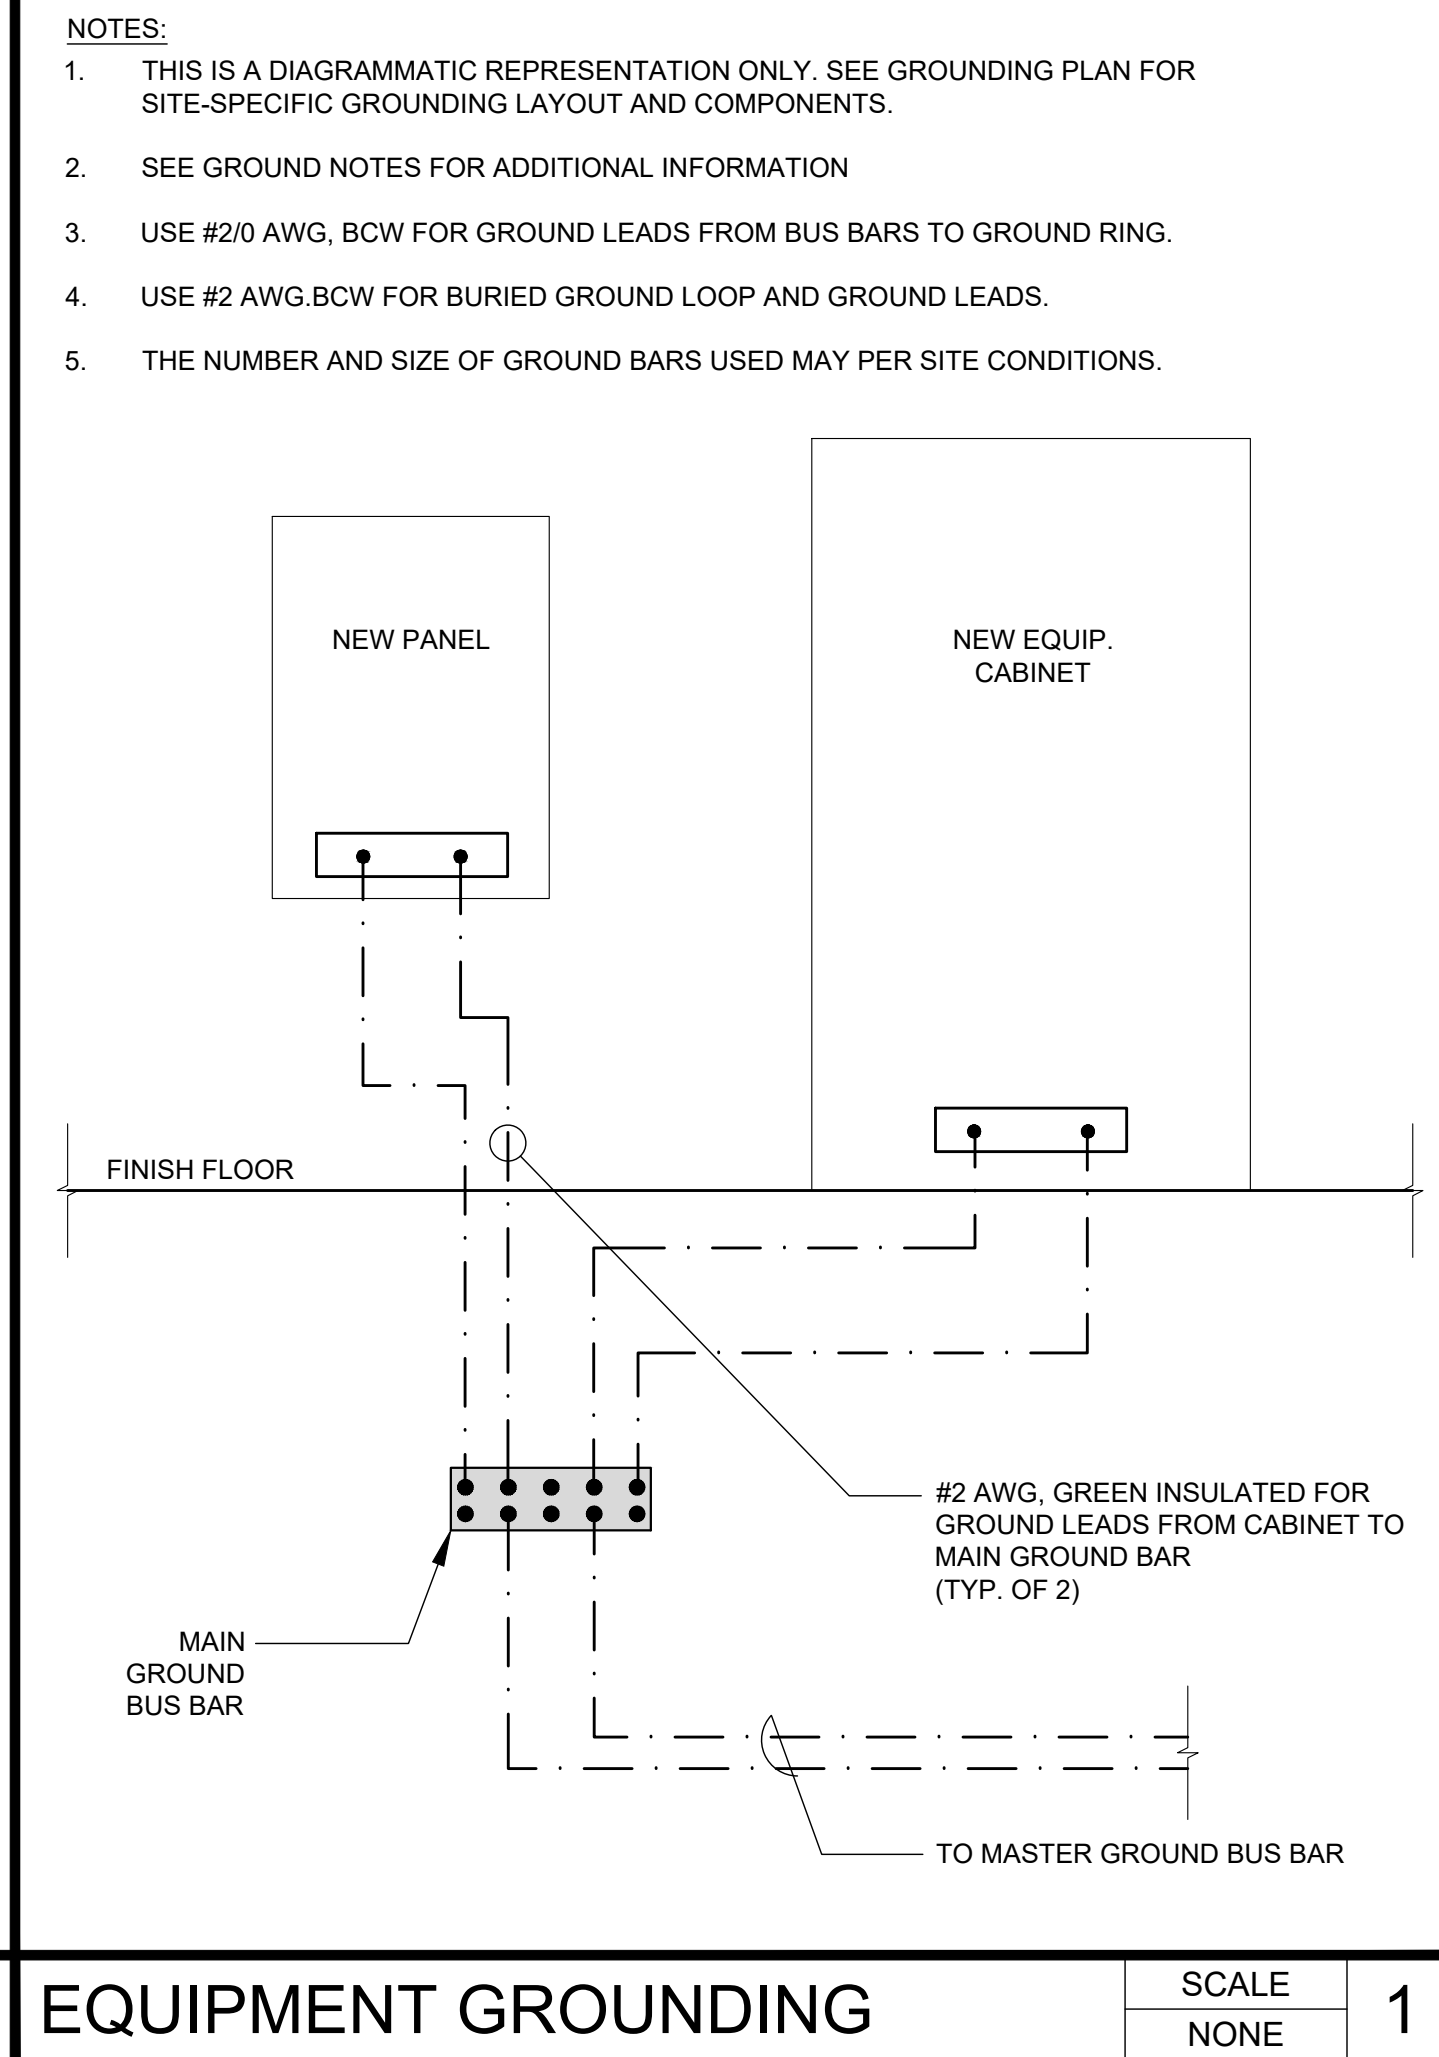


MAIN GROUNDING BAR

SCALE NONE 5



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PROJECT INFORMATION	
CLL05463	
1700 N. TOWNE AVE. CLAREMONT, CA 91711	
SHEET TITLE	
GROUNDING DETAILS	
SHEET NUMBER	
E-5	

EUKON AT&T_90CD_MONOPOLE_TEMPLATE_V2_11-18-22

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CONN. OF CABLE GND KIT TO ANT.		12	INSTALLATION OF GND WIRE TO GND BAR		9	GROUND BAR DETAIL		6	CONN. OF GRND WIRE TO GRND BAR, TOWER		3
<div></div>		<div></div>		<div></div>		<div><p>NOTES</p><ol style="list-style-type: none">1. NUMBER OF GROUNDING BARS MAY VARY DEPENDING ON THE TYPE OF TOWER, ANTENNA LOCATION, AND CONNECTION ORIENTATION, THE SUBCONTRACTOR SHALL BE RESPONSIBLE FOR INSTALLING ADDITIONAL GROUNDING BAR AS REQUIRED, PROVIDING 50% SPARE CONNECTION POINTS.2. DO NOT INSTALL CABLE GROUNDING KIT AT A BEND AND ALWAYS DIRECT GROUNDING CONDUCTOR DOWN TO GROUNDING BAR.3. GROUNDING KIT SHALL BE TYPE AND PART NUMBER AS SUPPLIED OR RECOMMENDED BY CABLE MANUFACTURER.4. WEATHER PROOFING SHALL BE TYPE AND PART NUMBER AS SUPPLIED OR RECOMMENDED BY CABLE MANUFACTURER.5. PROVIDE GROUNDING KIT 6\"BEFORE TURN TRANSITION FROM TOWER TO ICE BRIDGE.6. WHEN THE SCOPE OF WORK REQUIRES THE ADDITION OF A GROUNDING BAR TO AN EXISTING TOWER, THE SUBCONTRACTOR SHALL OBTAIN APPROVAL FROM THE TOWER OWNER PRIOR TO MOUNTING THE GROUNDING BARS TO THE TOWER.7. EXTEND TWO (2) #2 AWG TINNED CU CONDUCTOR FROM BURIED GROUNDING RING AND CONNECT TO THE NEW TOWER, FOLLOW MANUFACTURERS RECOMMENDATIONS FOR GROUNDING CONNECTIONS TO THE TOWER. (APPLICABLE TO NEW TOWERS ONLY.)8. BUILDINGS AND/OR NEW TOWERS GREATER THAN 75 FEET IN HEIGHT AND THE MAIN GROUNDING CONDUCTORS ARE REQUIRED TO BE ROUTED TO GRADE, THE CONTRACTOR SHALL ROUTE TWO GROUNDING CONDUCTORS FROM THE ROOF-TOP, TOWERS, AND WATER TOWERS GROUNDING RING, TO THE EXISTING GROUNDING SYSTEM, THE GROUNDING CONDUCTORS SHALL NOT BE SMALLER THAN 2/0 AWG COPPER, ROOF-TOP GROUNDING RING SHALL BE BONDED TO THE EXISTING GROUNDING SYSTEM, THE BUILDING STEEL COLUMNS, LIGHTNING PROTECTION SYSTEM, AND BUILDING MAIN WATER LINE (FERROUS OR NONFERROUS METAL PIPING ONLY), SEE AT&T GROUNDING AND BONDING STANDARDS TP-76416 SPECIFICATION 6.5.2.2.9. FLEX CONDUIT TO BE INSTALLED ON NEW COPPER CONDUCTOR UP TO GROUNDING BAR AND, SEALED AT ENDS TO PROTECT FROM OUTSIDE MOISTURE AND DEBRIS.</div>		<div>NOT FOR CONSTRUCTION</div>			
EXOTHERMIC WELD CONNECTION		11	MECHANICAL CONNECTION		8	GPS ANTENNA GROUNDING		5	GROUNDING NOTES		2
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PYL12V185FT 12V 185Ah-8Hr
HIGH TEMPERATURE SUPER LONG LIFE
BATTERY with HT X Alloy™

TECHNICAL DATA SHEET



- HIGH TEMPERATURE LONG LIFE DESIGN
- + HT X Alloy™ extends life in high temp applications
 - + Additives to maintain compression
 - + Designed to control charging current as temperature increases
 - + No thermal runaway
 - + Epoxy sealed terminals to prevent post leaks
 - + Rugged ABS cases to minimize handling damage

- 10+ YEAR DESIGN LIFE
- + Exceeds Telcordia GR-1200 criteria
 - + Greater than 5 years at 35°C

- | COMPLIANCE | SAFETY |
|---------------|------------|
| + VZ 17P-9902 | + UL 94V-0 |
| + GR-4228 | + UL 1000 |
| + GR-1089 | |
| + GR-63 NEBS | |



SPECIFICATIONS

MODEL	NOMINAL VOLTAGE (V)	*RATED CAPACITY at 8 Hr (Ah)	** OPERATING RANGE	L		W		H		TH	WEIGHT		TERMINAL
				mm	in.	mm	in.	mm	in.		kg	lbs.	
PYL12V185FT	12	185	-40 to 65°C (-40 to 149°F)	536	21.9	125	4.9	317	12.5	317	60.7	133.8	Front-M6 Bolt Top-M6 Bolt

*Maximum Charge Current is 25% of the 8 Hr. Rate

** Refer to Product Manual for optimum temperature range

AMPERES TO FINAL VOLTAGE: 1.75V@25°C (77°F)




MODEL	DISCHARGE TIME (Hr)										
	2	3	4	5	6	7	8	9	10	12	20
PYL12V185FT	71.2	52.0	41.3	34.4	30.0	26.0	23.1	21.0	19.3	17.7	10.2

WATTS TO FINAL VOLTAGE: 1.75V@25°C (77°F)

MODEL	DISCHARGE TIME (Hr)										
	2	3	4	5	6	7	8	9	10	12	20
PYL12V185FT	829	609	487	407	351	315	275	250	232	215	123



PYL12V185FT 12V 185Ah-8Hr
HIGH TEMPERATURE SUPER LONG LIFE
BATTERY with HT X Alloy™

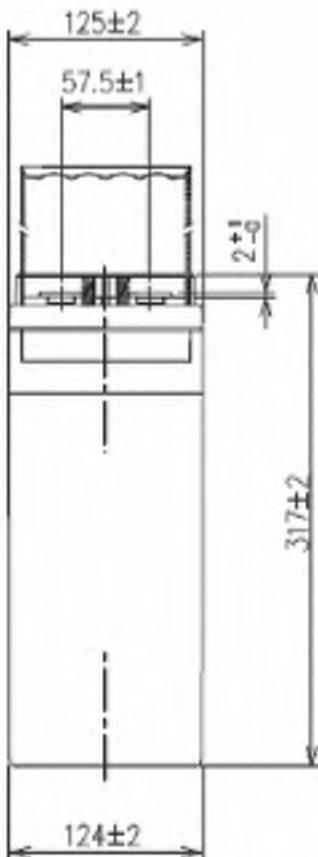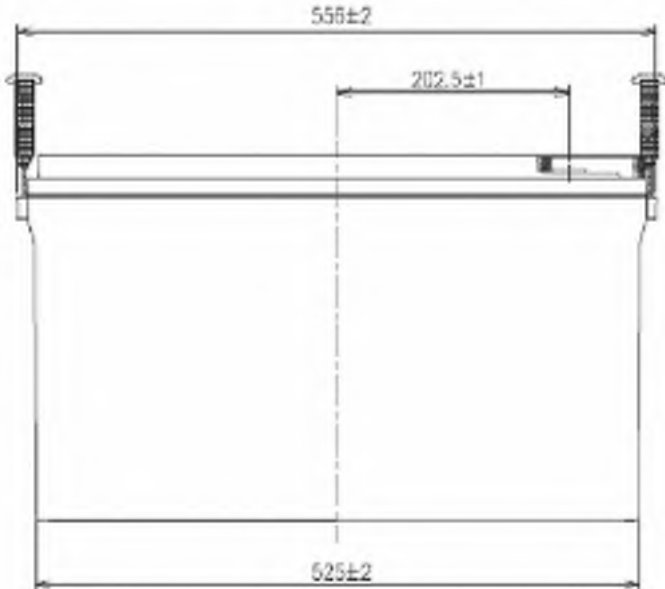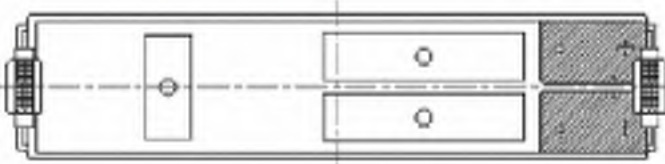

units: mm

- Float Charge Voltage: 13.65 ±0.15 @ 25°C
- Temperature Compensation: Adjust float charge voltage +3mV/°C/cell for temperatures <25°C; -3mV/°C/cell for temperatures >25°C.
- Internal Resistance: Approximately 3.5mΩ measured with 1kHz AC bridge
- Terminal Hardware Torque: (Top, 8mm): 90 in.-lbs. (10.17 Nm)
(Front, 6mm): 43.4 in.-lbs. (4.9 Nm)

ABOUT GS YUASA ENERGY SOLUTIONS, INC.
GS Yuasa Energy Solutions, Inc. is an American subsidiary of GS Yuasa Corporation, the world's second largest battery company and a 100+ year old Japanese corporation. GS Yuasa Energy Solutions (GYES) was formed in 2019 to address the growing energy storage and reserve power markets. GYES brings together and leverages GS Yuasa Group's advanced technologies with proven American market successes in lithium, telecom, UPS, alarm & security, and energy storage into a single business unit.



GS Yuasa Energy Solutions, Inc.
1150 Northmeadow Pkwy, Suite 110
Roswell, GA 30076 (800) 472-2879
www.gsyuasa-es.com



500-110-022 ver4.0 8-2022

FIRE DEPARTMENT NOTES

GENERAL

- 1.0 ADDRESS NUMBERS:
- A. APPROVED ADDRESS NUMBERS, BUILDING NUMBERS OR APPROVED BUILDING IDENTIFICATION SHALL BE PLACED IN A POSITION THAT PLAINLY LEGIBLE AND VISIBLE FROM THE STREET, ROAD, ALLEY, AND WALKWAYS GIVING ACCESS TO AND WITHIN THE PROPERTY.
- 2.0 FIRE EXTINGUISHERS:
- A. PROVIDE A FIRE EXTINGUISHER (MINIMUM 2A-10BC) WITHIN A RECESSED OR SEMI-RECESSED CABINET WITHIN 75 FEET TRAVEL DISTANCE FROM ALL POINTS IN THE OCCUPANCY; THE EXTINGUISHER SHALL BE MOUNTED ON A HOOK WITHIN THE CABINET (ELEVATED OFF CABINET FLOOR); THE TOP OF THE EXTINGUISHER SHALL BE NO HIGHER THAN 48 INCHES (1219 mm) ABOVE THE FLOOR; EXTINGUISHER SHALL BE PLACED IN A EASILY ACCESSIBLE LOCATIONS WHERE THEY WILL BE READILY ACCESSIBLE AND IMMEDIATELY AVAILABLE FOR USE.
- 3.0 DOOR OPERATIONS:
- A. ALL EXIT DOORS SHALL BE OPENABLE FROM THE INSIDE WITHOUT KEY, SPECIAL KNOWLEDGE, OR EFFORT. THE UNLATCHING OF ANY EXIT DOOR SHALL NOT REQUIRE MORE THAN ONE OPERATION.
- 4.0 ADDITIONAL PERMIT:
- A. PRIOR TO THE FINAL INSPECTION, OBTAIN A HAZARDOUS MATERIALS PERMIT FROM THE FIRE DEPARTMENT. CONTACT THE ENVIRONMENTAL MANAGEMENT CENTER AT (916) 455-8200
- 5.0 REQUIRED INSPECTIONS:
- A. THE FIRE DEPARTMENT INSPECTION FOR THIS PROJECT INCLUDE THE FOLLOWING:
1. HAZARDOUS MATERIALS FINAL INSPECTION.
2. FIRE PREVENTION BUREAU FINAL INSPECTION - CONTRACTOR MUST REQUEST A SEPERATE INSPECTION. INSPECTION INCLUDES: BUT IS NOT LIMITED TO: FIRE EXTINGUISHERS; SIGNAGE; DOOR HARDWARE AND MEANS OF EGRESS; EMERGENCY/EXIT LIGHTING; ETC.

NOTE: TO SCHEDULE INSPECTIONS: CALL OFFICE OF STATE FIRE MARSHALL AT (916-445-8200) AT LEAST 48 HOURS IN ADVANCE.

BATTERY NOTES

1. PER CFC 2022 SECTION 1207.1.1 - STATIONARY STORAGE BATTERY SYSTEMS HAVING CAPACITIES EXCEEDING THE VALUES SHOWN IN TABLE 1207.1.1 SHALL COMPLY WITH SECTION 1207, AS APPLICABLE. SINCE THE TOTAL CAPACITY OF THE LEAD-ACID-TYPE BATTERY SYSTEM IS LESS THAN 70kWh THIS MODIFICATION IS EXEMPT FROM CFC 2022 SECTION 1207.
- CAPACITY CALCULATION:
(12 BATTERIES x 185Ah x 12V) / 1000 = 26.64kWh
2. DEFINITIONS PER CFC 2022 CHAPTER 2:
- LEAD ACID BATTERY:
A STORAGE BATTERY THAT IS COMPRISED OF LEAD ELECTRODES IMMERSED IN A SOLUTION OF WATER AND SULPHURIC ACID ELECTROLYTE.
- CORROSIVE:
A CHEMICAL THAT CAUSES VISIBLE DESTRUCTION OF, OR IRREVERSIBLE ALTERATIONS IN, LIVING TISSUE BY CHEMICAL ACTION AT THE POINT OF CONTACT. A CHEMICAL SHALL BE CONSIDERED CORROSIVE IF, WHEN TESTED ON THE INTACT SKIN OF ALBINO RABBITS BY THE METHOD DESCRIBED IN DOTN 49 CFR 173.137, SUCH CHEMICAL DESTROYS OR CHANGES IRREVERSIBLY THE STRUCTURE OF THE TISSUE AT THE POINT OF CONTACT FOLLOWING AN EXPOSURE PERIOD OF 4 HOURS. THIS TERM DOES NOT REFER TO ACTION ON INANIMATE SURFACES.
- HAZARDOUS MATERIALS:
THOSE CHEMICALS OR SUBSTANCES WHICH ARE PHYSICAL HAZARDS OR HEALTH HAZARDS AS DEFINED AND CLASSIFIED IN THIS CHAPTER, WHETHER THE MATERIALS ARE IN USABLE OR WASTE CONDITION.
- HEALTH HAZARD:
A CLASSIFICATION OF A CHEMICAL FOR WHICH THERE IS STATISTICALLY SIGNIFICANT EVIDENCE THAT ACUTE OR CHRONIC HEALTH EFFECTS ARE CAPABLE OF OCCURRING IN EXPOSED PERSONS. THE TERM "HEALTH HAZARD" INCLUDES CHEMICALS THAT ARE TOXIC, HIGHLY TOXIC AND CORROSIVE.
- PHYSICAL HAZARD:
A CHEMICAL FOR WHICH THERE IS EVIDENCE THAT IT IS A COMBUSTIBLE LIQUID, CRYOGENIC FLUID, EXPLOSIVE, FLAMMABLE (SOLID, LIQUID OR GAS), ORGANIC PEROXIDE (SOLID OR LIQUID), OXIDIZER (SOLID OR LIQUID), OXIDIZING GAS, PYROPHORIC (SOLID, LIQUID OR GAS), UNSTABLE (REACTIVE) MATERIAL (SOLID, LIQUID OR GAS) OR WATER-REACTIVE MATERIAL (SOLID OR LIQUID).



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TUSTIN, CA 92780



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DW/AS	GD	RB


CONSTRUCTION
DRAWINGS

SUBMITTALS		
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PROJECT INFORMATION
CLL05463
1700 N. TOWNE AVE. CLAREMONT, CA 91711

SHEET TITLE
FIRE DEPARTMENT NOTES AND BATTERY INFORMATION

SHEET NUMBER
FD-1

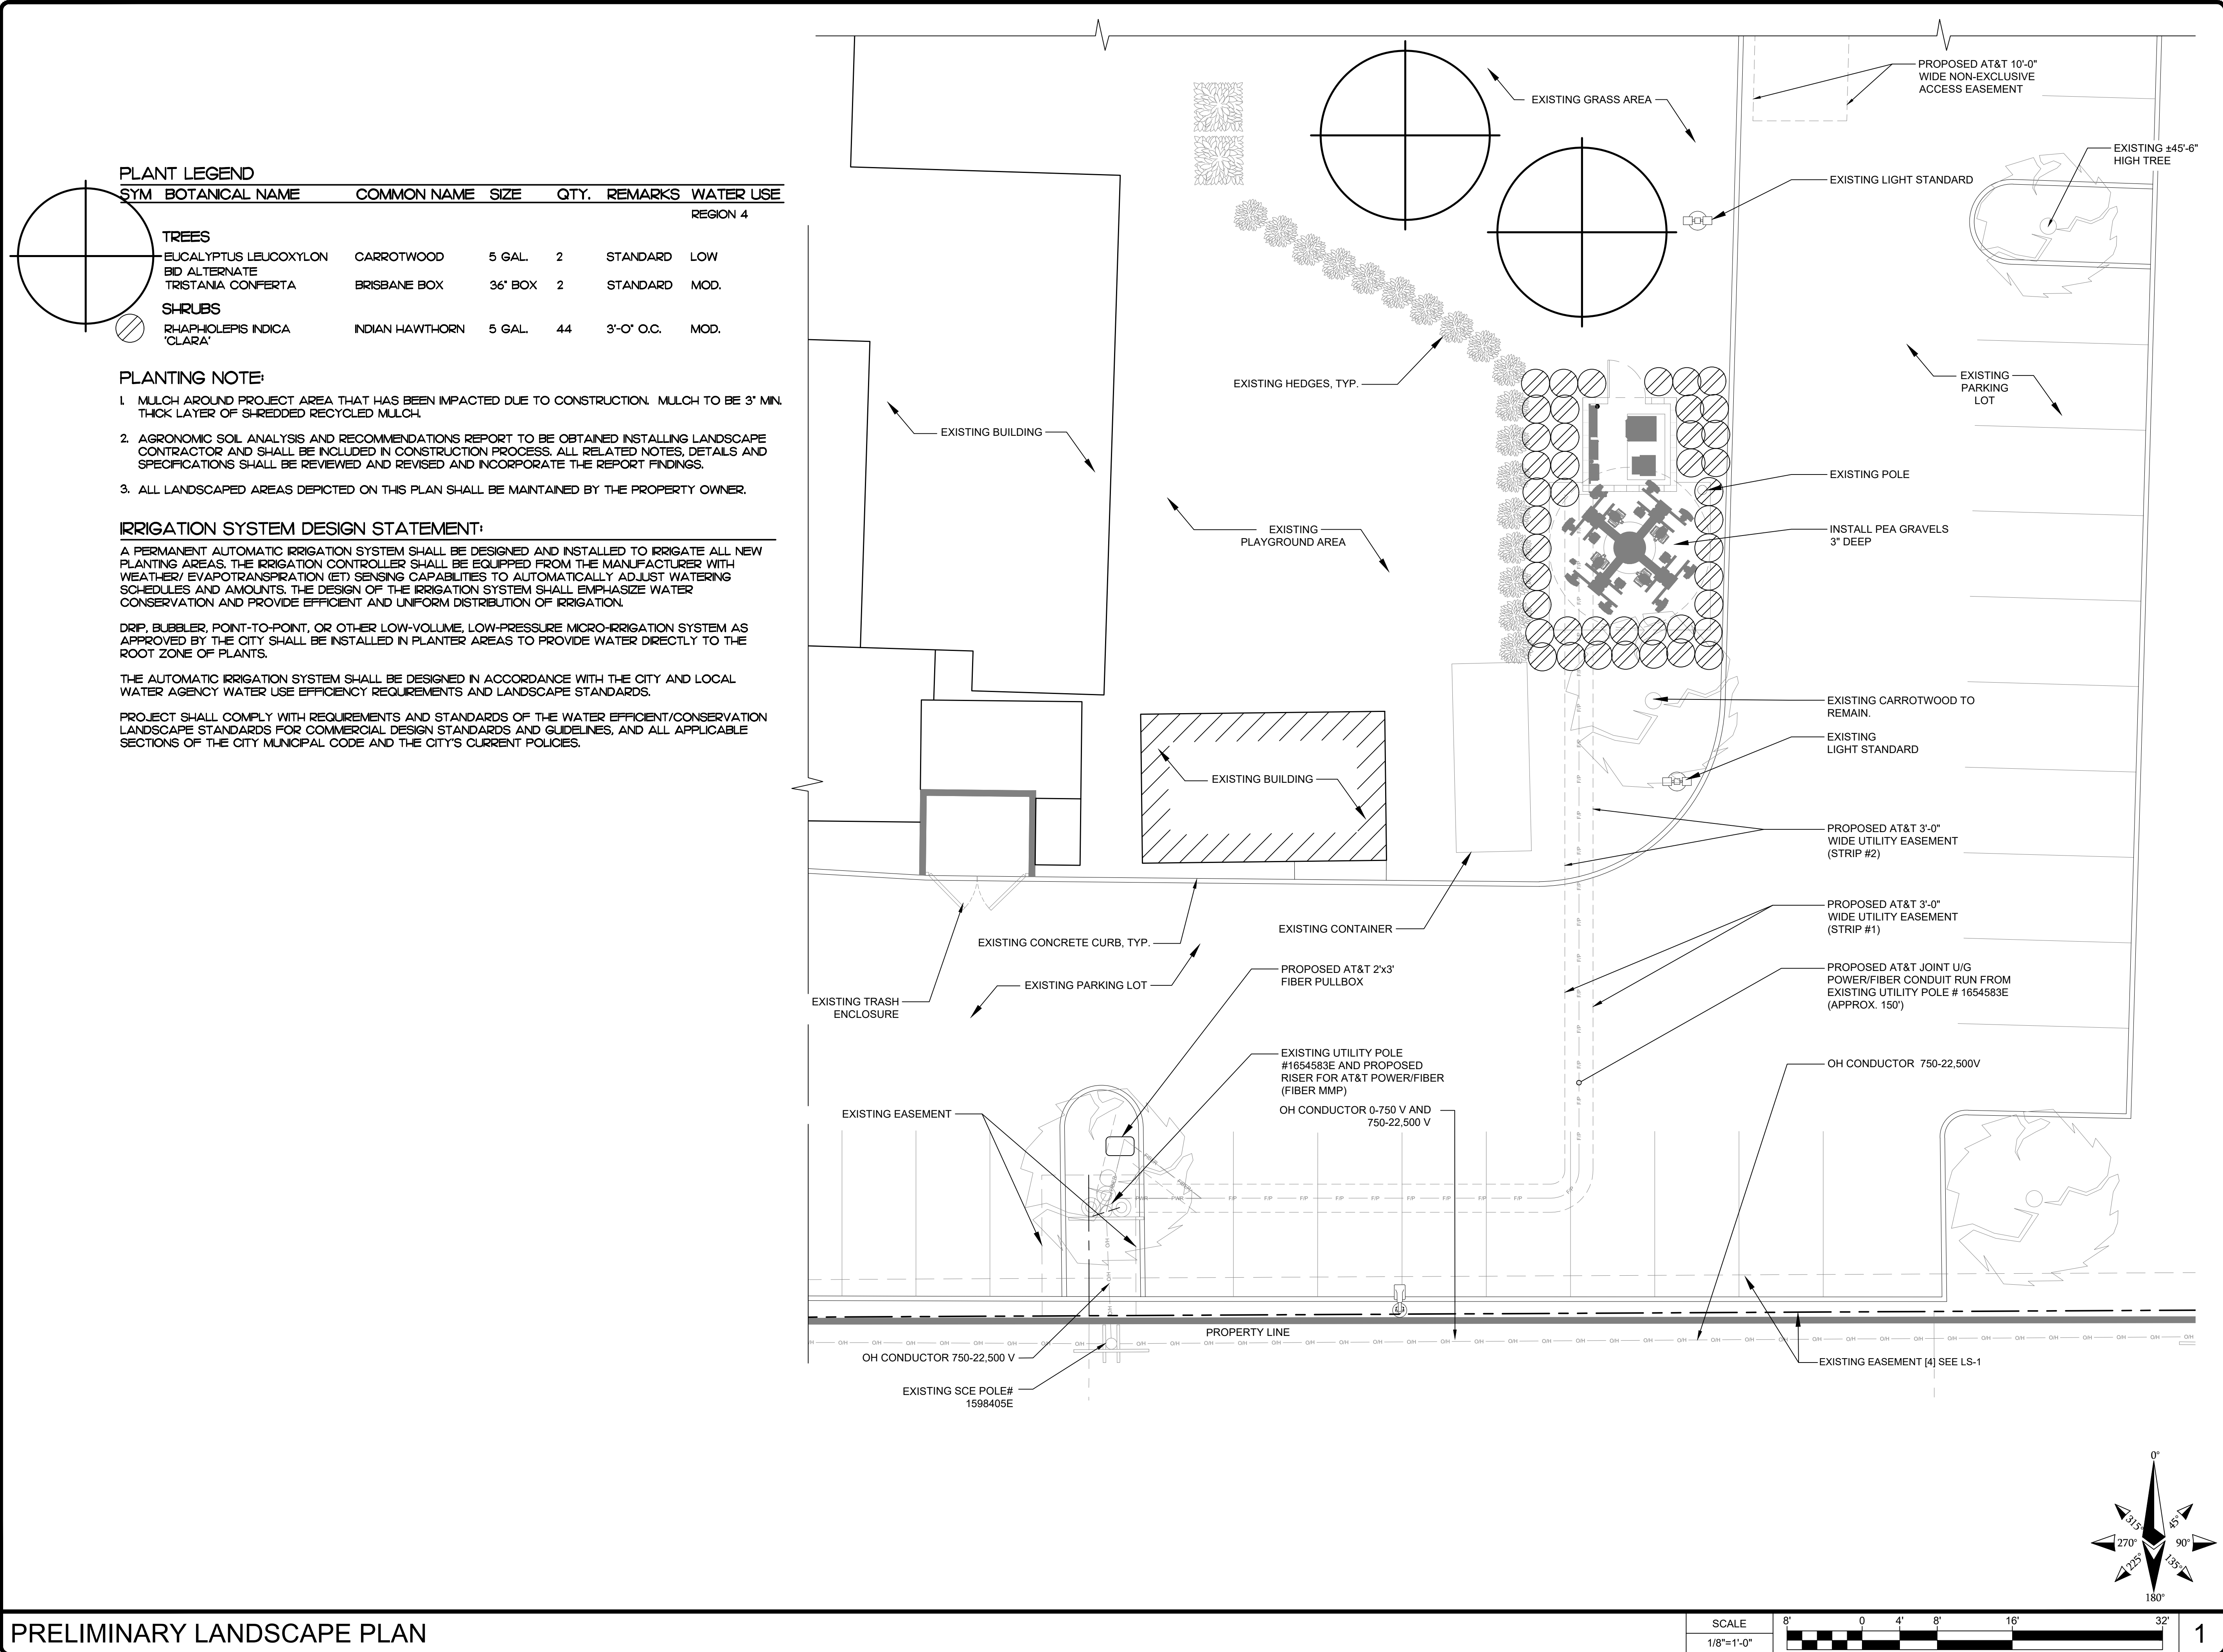

APPLICANT:

1452 EDINGER AVENUE,
3RD FLOOR
TUSTIN, CA 92780

ENGINEER:

an SFC Communications, Inc. Company

65 POST, SUITE 1000
IRVINE, CA 92618
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www.eukongroup.com

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DRAWN BY: mdm
CHECKED BY: RJC

REVISIONS:

REV	DATE	DESCRIPTION
C	07/25/24	100% ZONING DRAWINGS
B	06/16/24	100% ZONING DRAWINGS
A	11/07/23	90% ZONING DRAWINGS

LICENSEE:

RJCLA
LANDSCAPE ARCHITECTURE

Landscape Architects
Il Villamours
Laguna Niguel, CA 92677
(949) 661-3938
rjcla@rjclalocal.net

06/16/2024

PROJECT INFORMATION:

CLL05463
1700 N. TOWNE AVE.
CLAREMONT, CA. 91711

SHEET TITLE:


PRELIMINARY
LANDSCAPE PLAN

SHEET NUMBER:

L-1



at&t

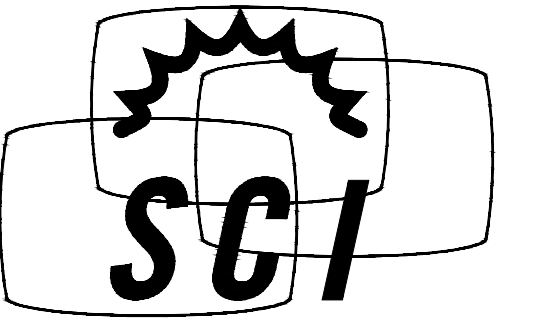

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Temecula, CA 92592
Phone: (951) 698-5985
www.RFTransparent.com

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AT&T

CLL05463

62'-0" QUAD-EUC

U.S. PATENT # 7616170 & 8035574

LOCATION:

1700 NORTH TOWNE AVENUE
CLAREMONT, CA 91711
LOS ANGELES COUNTY


DRAWING INDEX

- T1 TITLE SHEET
- N1 NOTES & SPECIFICATIONS
- S1 ELEVATION VIEWS
- S2-S4 DETAILS
- S5 FOUNDATION

TITLE SHEET

CLL05463

US PATENT # 7616170 & 8035574
62'-0" QUAD-EUC
1700 NORTH TOWNE AVENUE
CLAREMONT, CA 91711

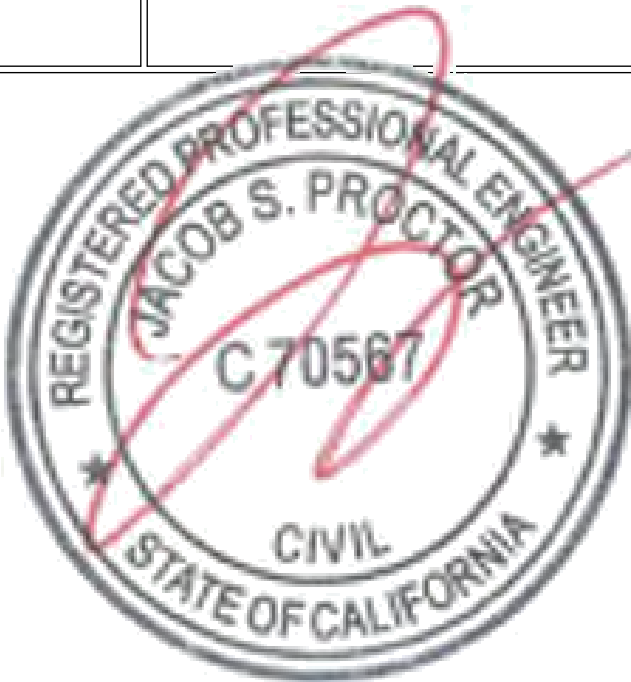

06/20/2024

DATE: 6/20/24 DESIGNED: EME DRAFTER: EME

REVISIONS		
REV	DATE	DESCRIPTION

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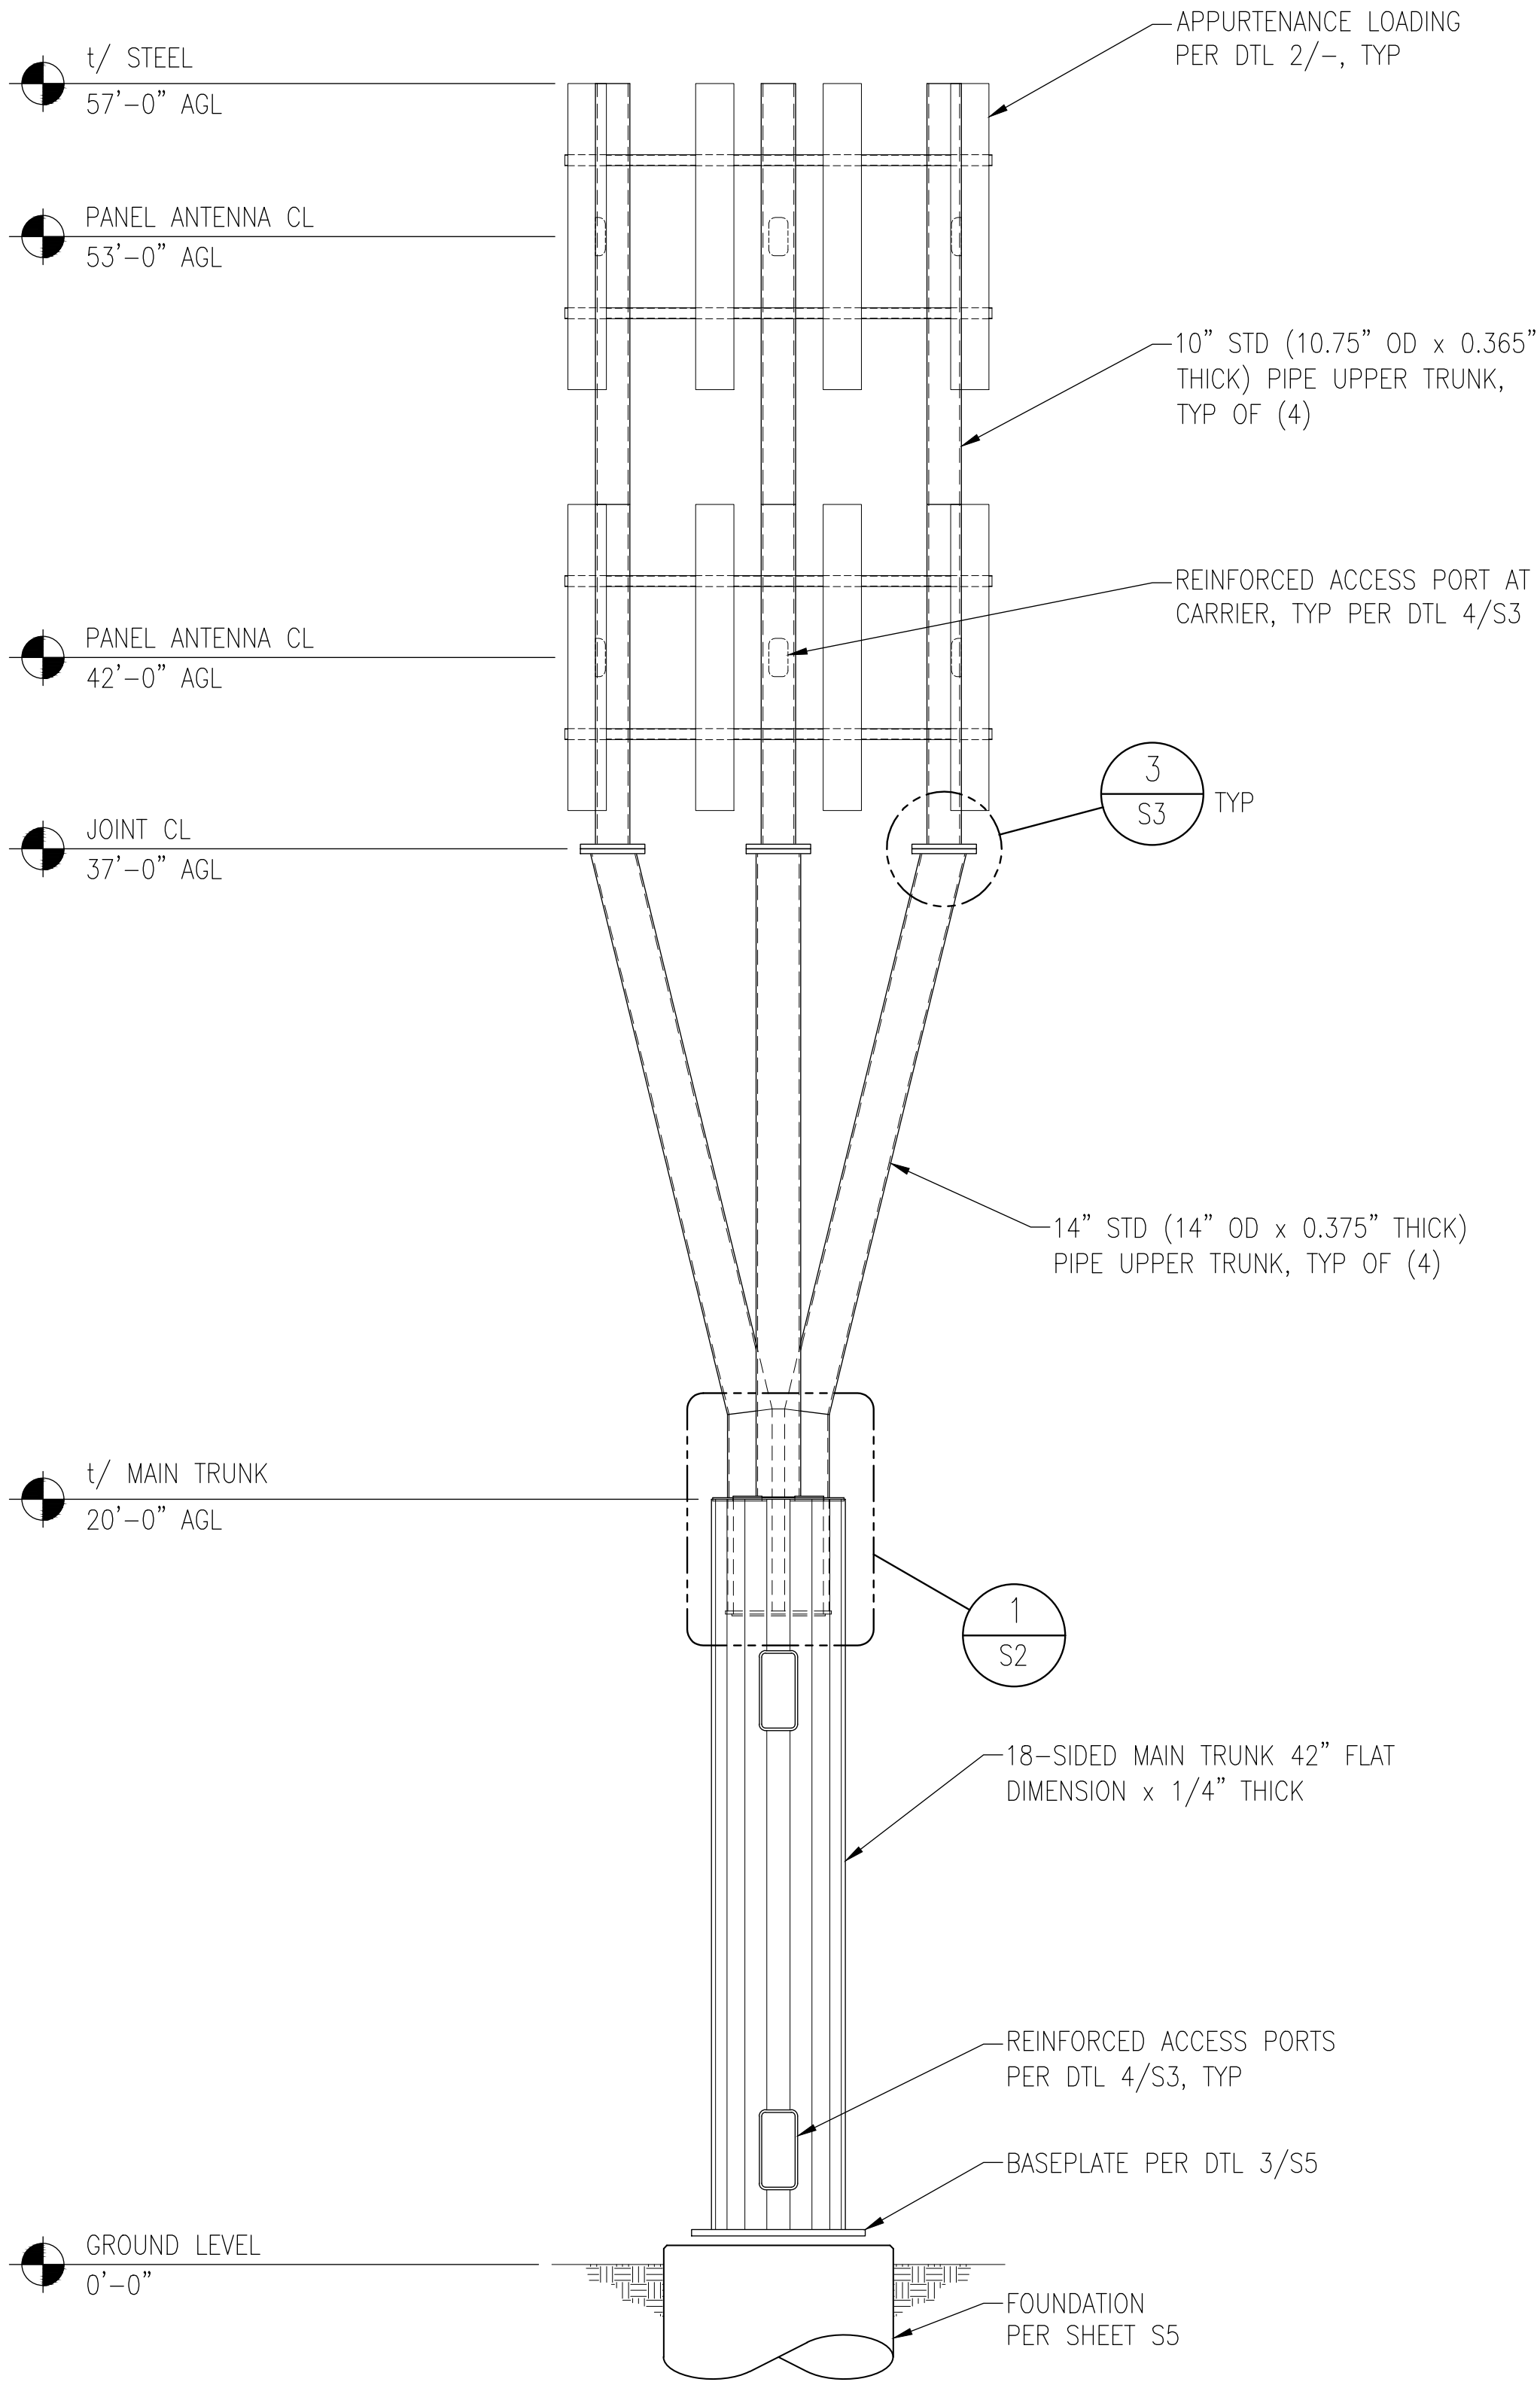
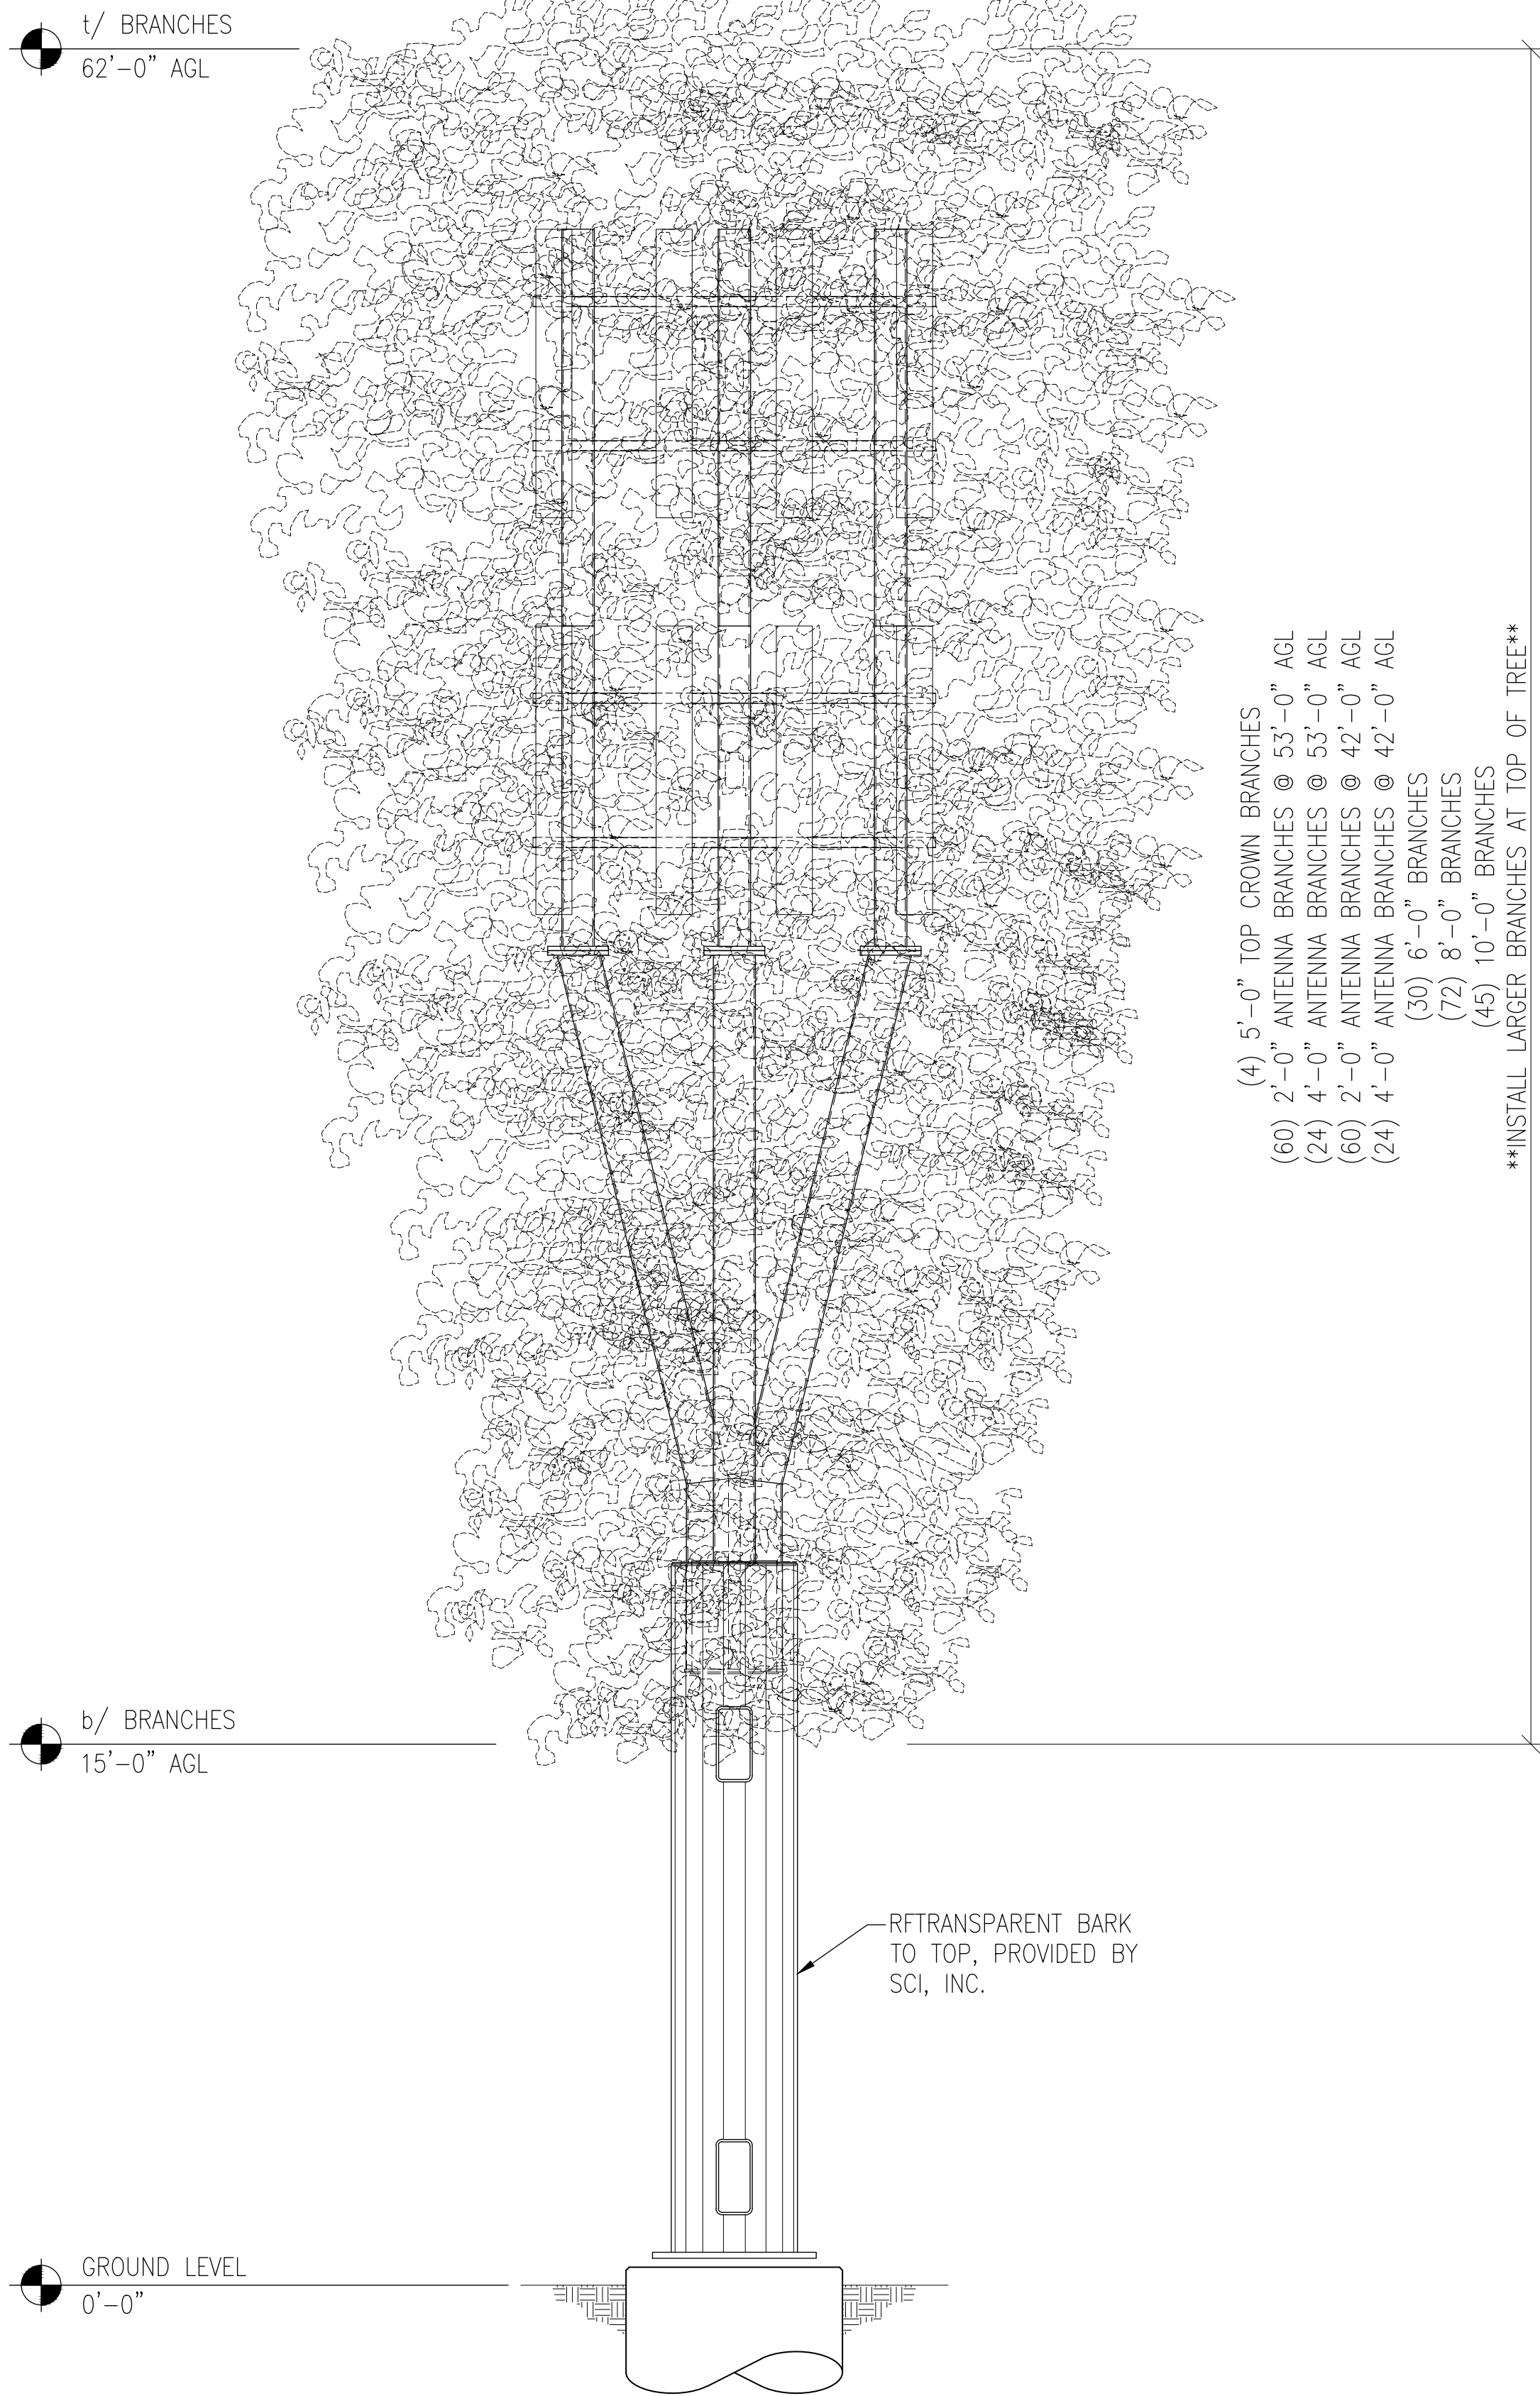
DESIGN LOADING:
ANTENNA CL @ 53'-0" AGL:
(4) CCI TPA-45R-KU8AA-K (98.7"x15.4"x8.2") PANEL ANTENNAS
(4) ERICSSON AIR6449 B77D (31"x15.9"x10.6") PANEL ANTENNAS
(4) ERICSSON AIR6419 B77G (28.3"x16.1"x7.9") PANEL ANTENNAS
(8) RRU 4449 B5/B12
(8) RRU 8843 B2/B66A
(8) RRU 4478 B14
(4) RAYCAP SURGE SUPPRESSORS
MOUNT PER SHEET S4

ANTENNA CL @ 42'-0" AGL:
(8) CCI TPA-45R-KU8AA-K (98.7"x15.4"x8.2") PANEL ANTENNAS
(8) RRU 4449 B5/B12
(8) RRU 8843 B2/B66A
(8) RRU 4478 B14
(4) RAYCAP SURGE SUPPRESSORS
MOUNT PER SHEET S4

APPURTENANCES


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NOTE:
1. BRANCHES ARE SHOWN FOR ILLUSTRATIVE PURPOSES ONLY AND ARE NOT DRAWN TO SCALE.
2. SEE DETAIL 1/S3 FOR UPPER TRUNK SPACING AND MAX BRANCH DIAMETER.
3. ANTENNAS TO BE COVERED w/ FOLIAGE COLORED ANTENNA SOCKS
4. SEE DETAIL 2/S3 FOR BRANCH RECEPTACLES.



ELEVATIONS

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ELEVATION VIEWS

CLL05463

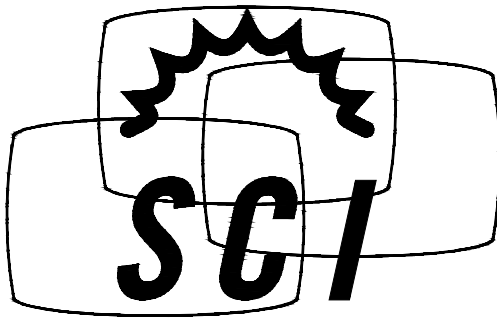US PATENT # 7616170 & 8035574
62'-0" QUAD-EUC
1700 NORTH TOWNE AVENUE
CLAREMONT, CA 91711



06/20/2024








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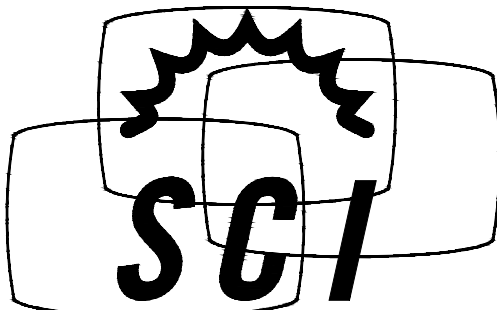
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
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DETAILS

CLL05463

US PATENT # 7616170 & 8035574
62'-0" QUAD-EUC
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CLAREMONT, CA 91711




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REV	DATE	DESCRIPTION
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S2		REV 0

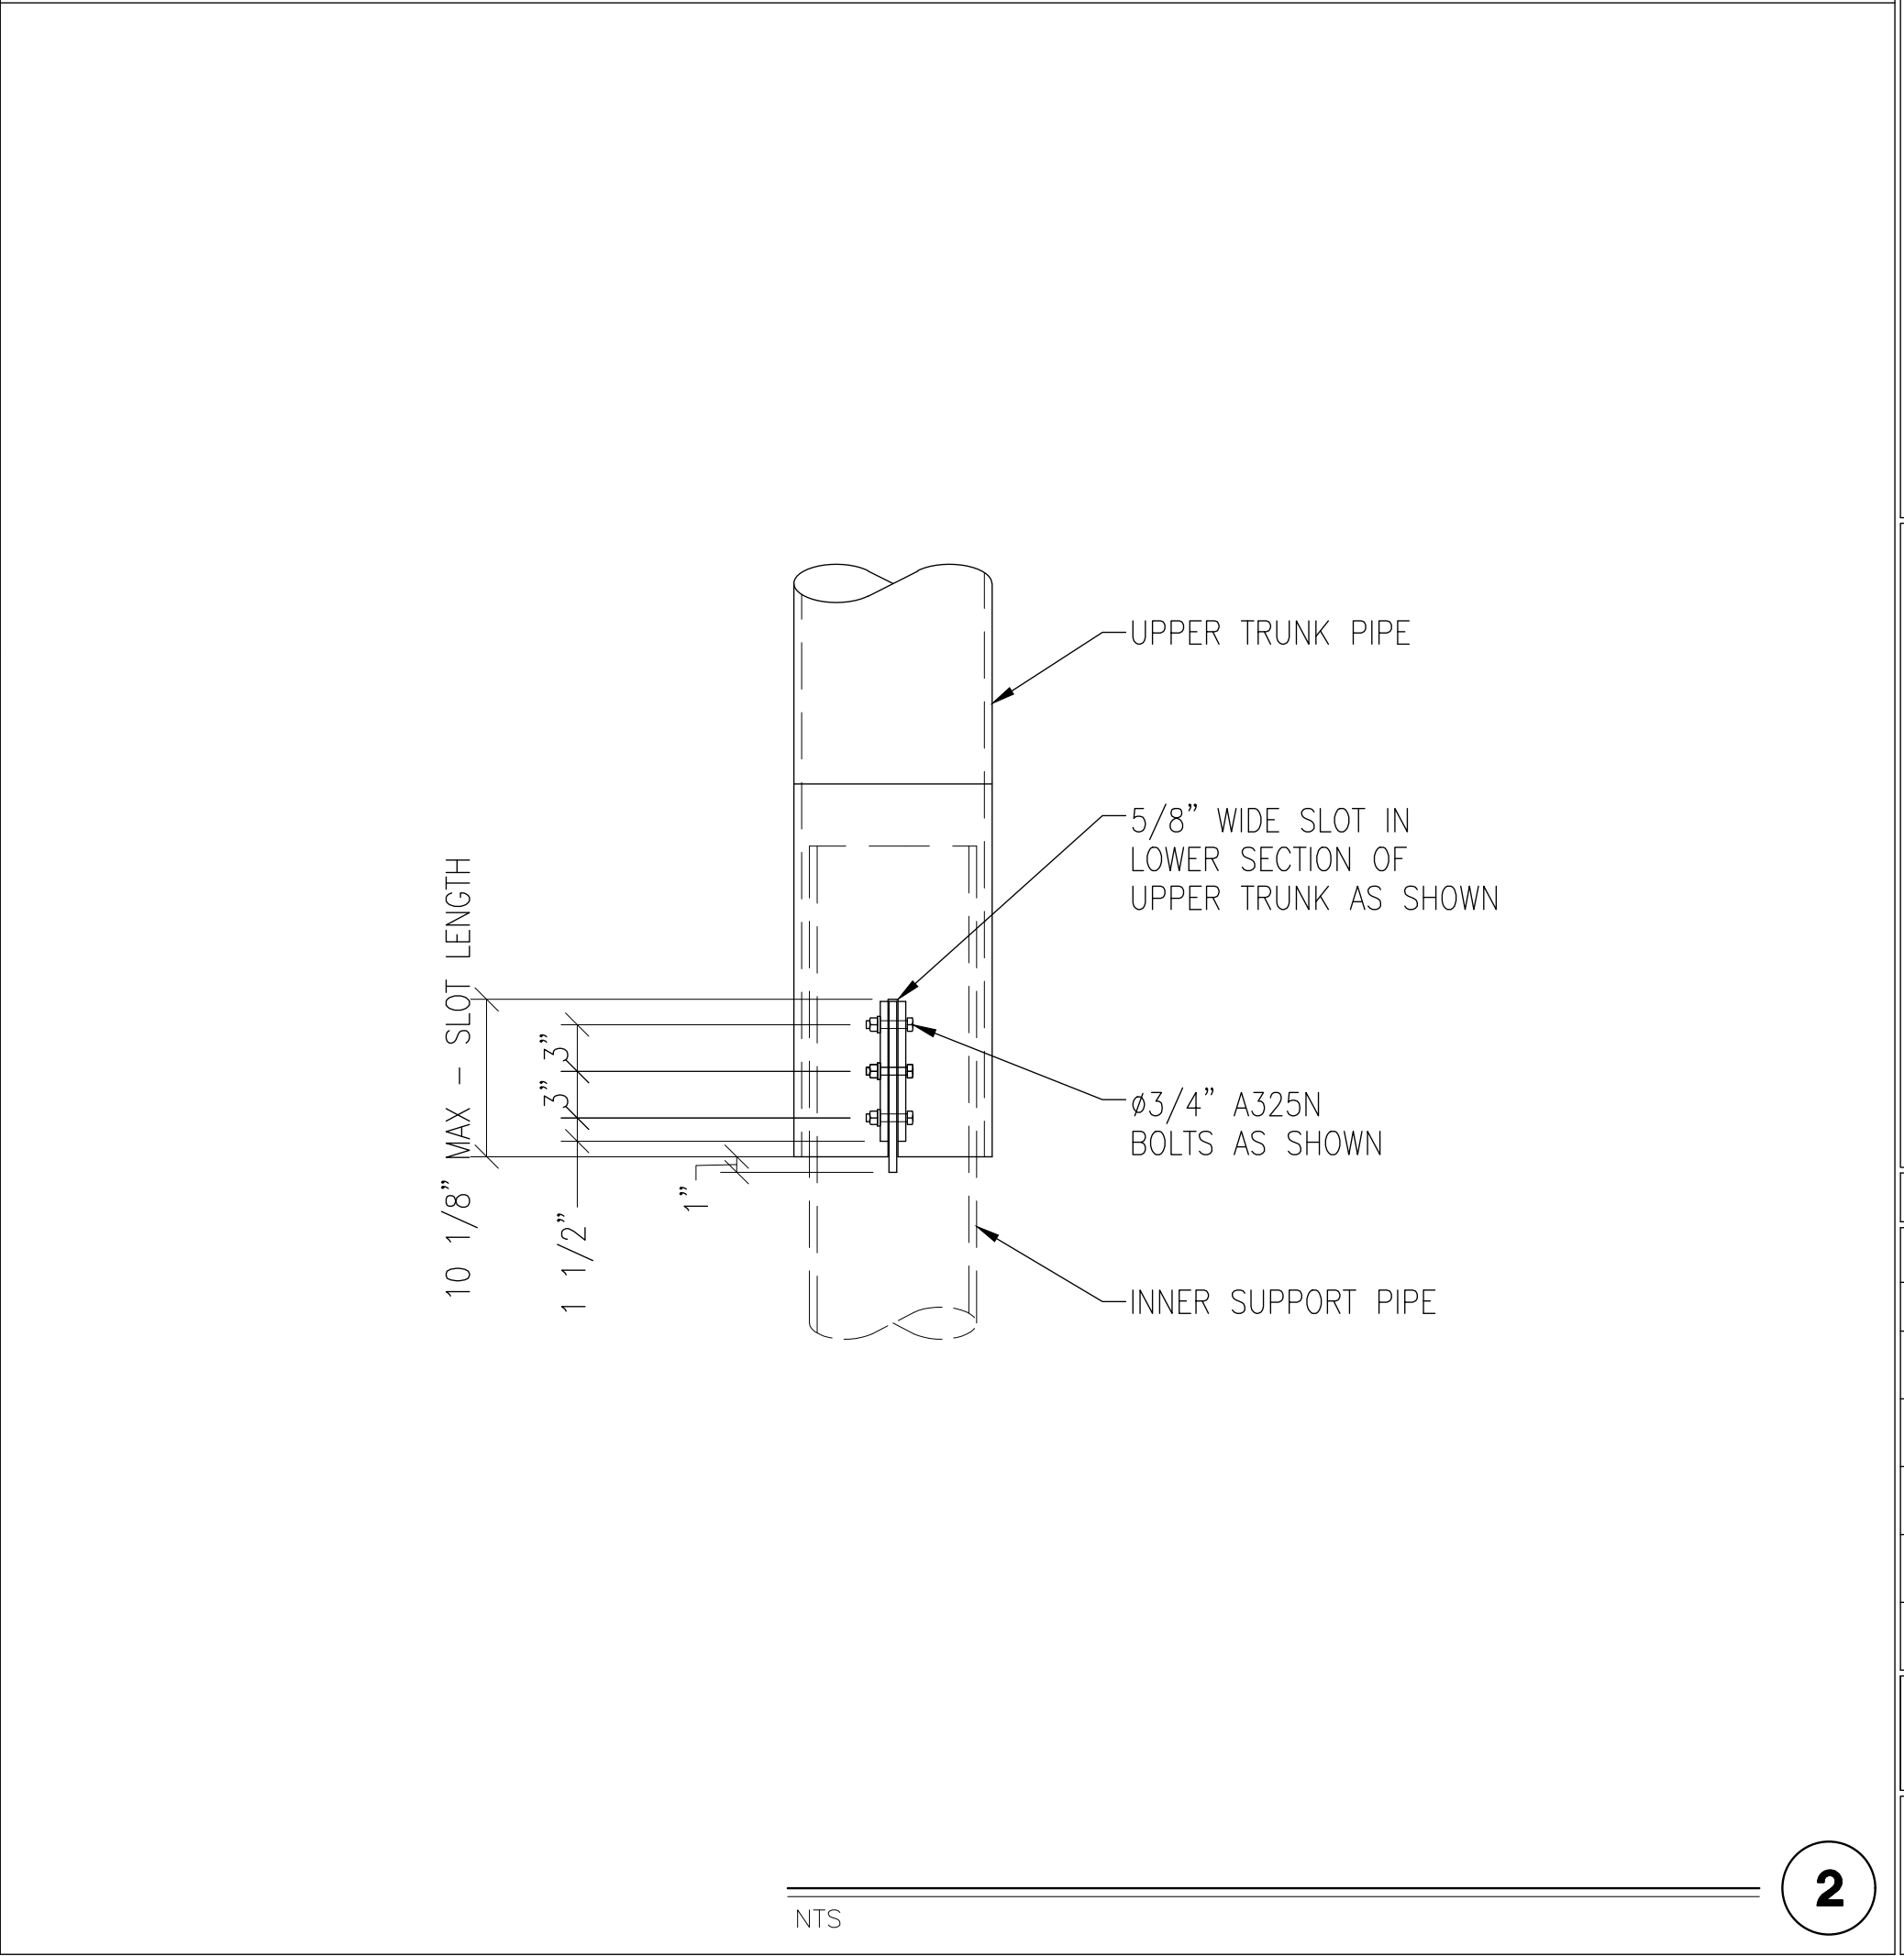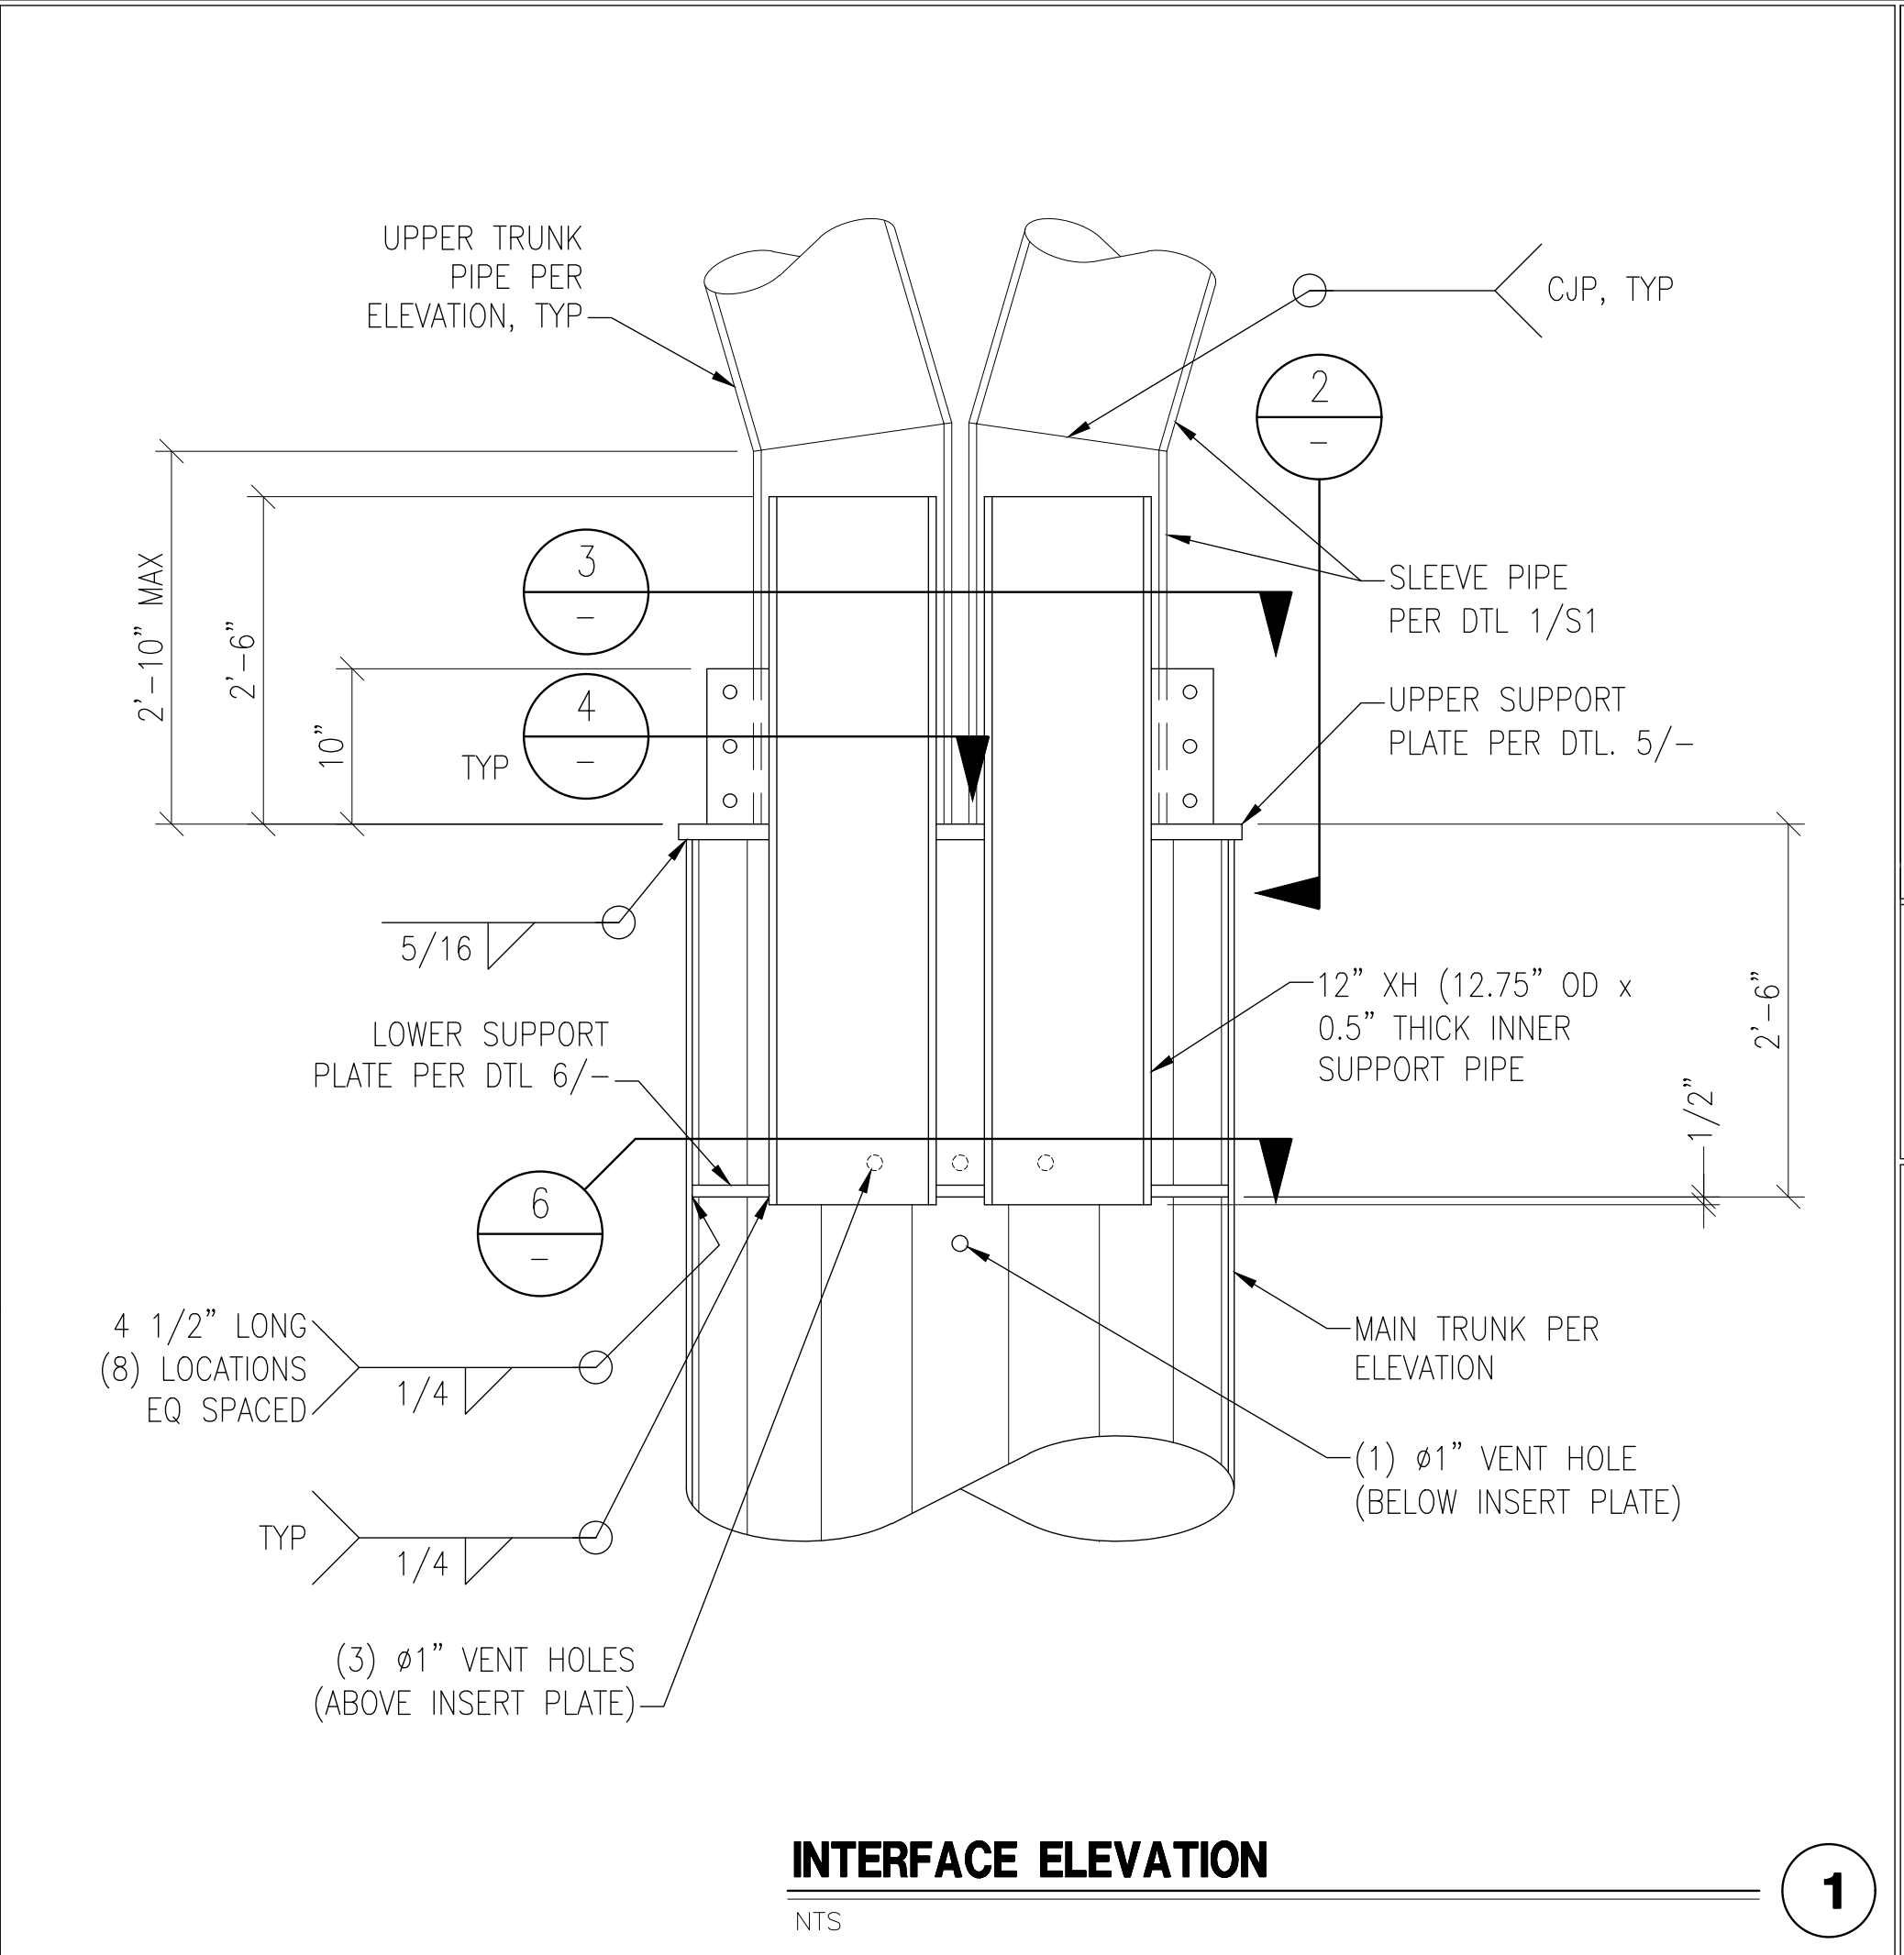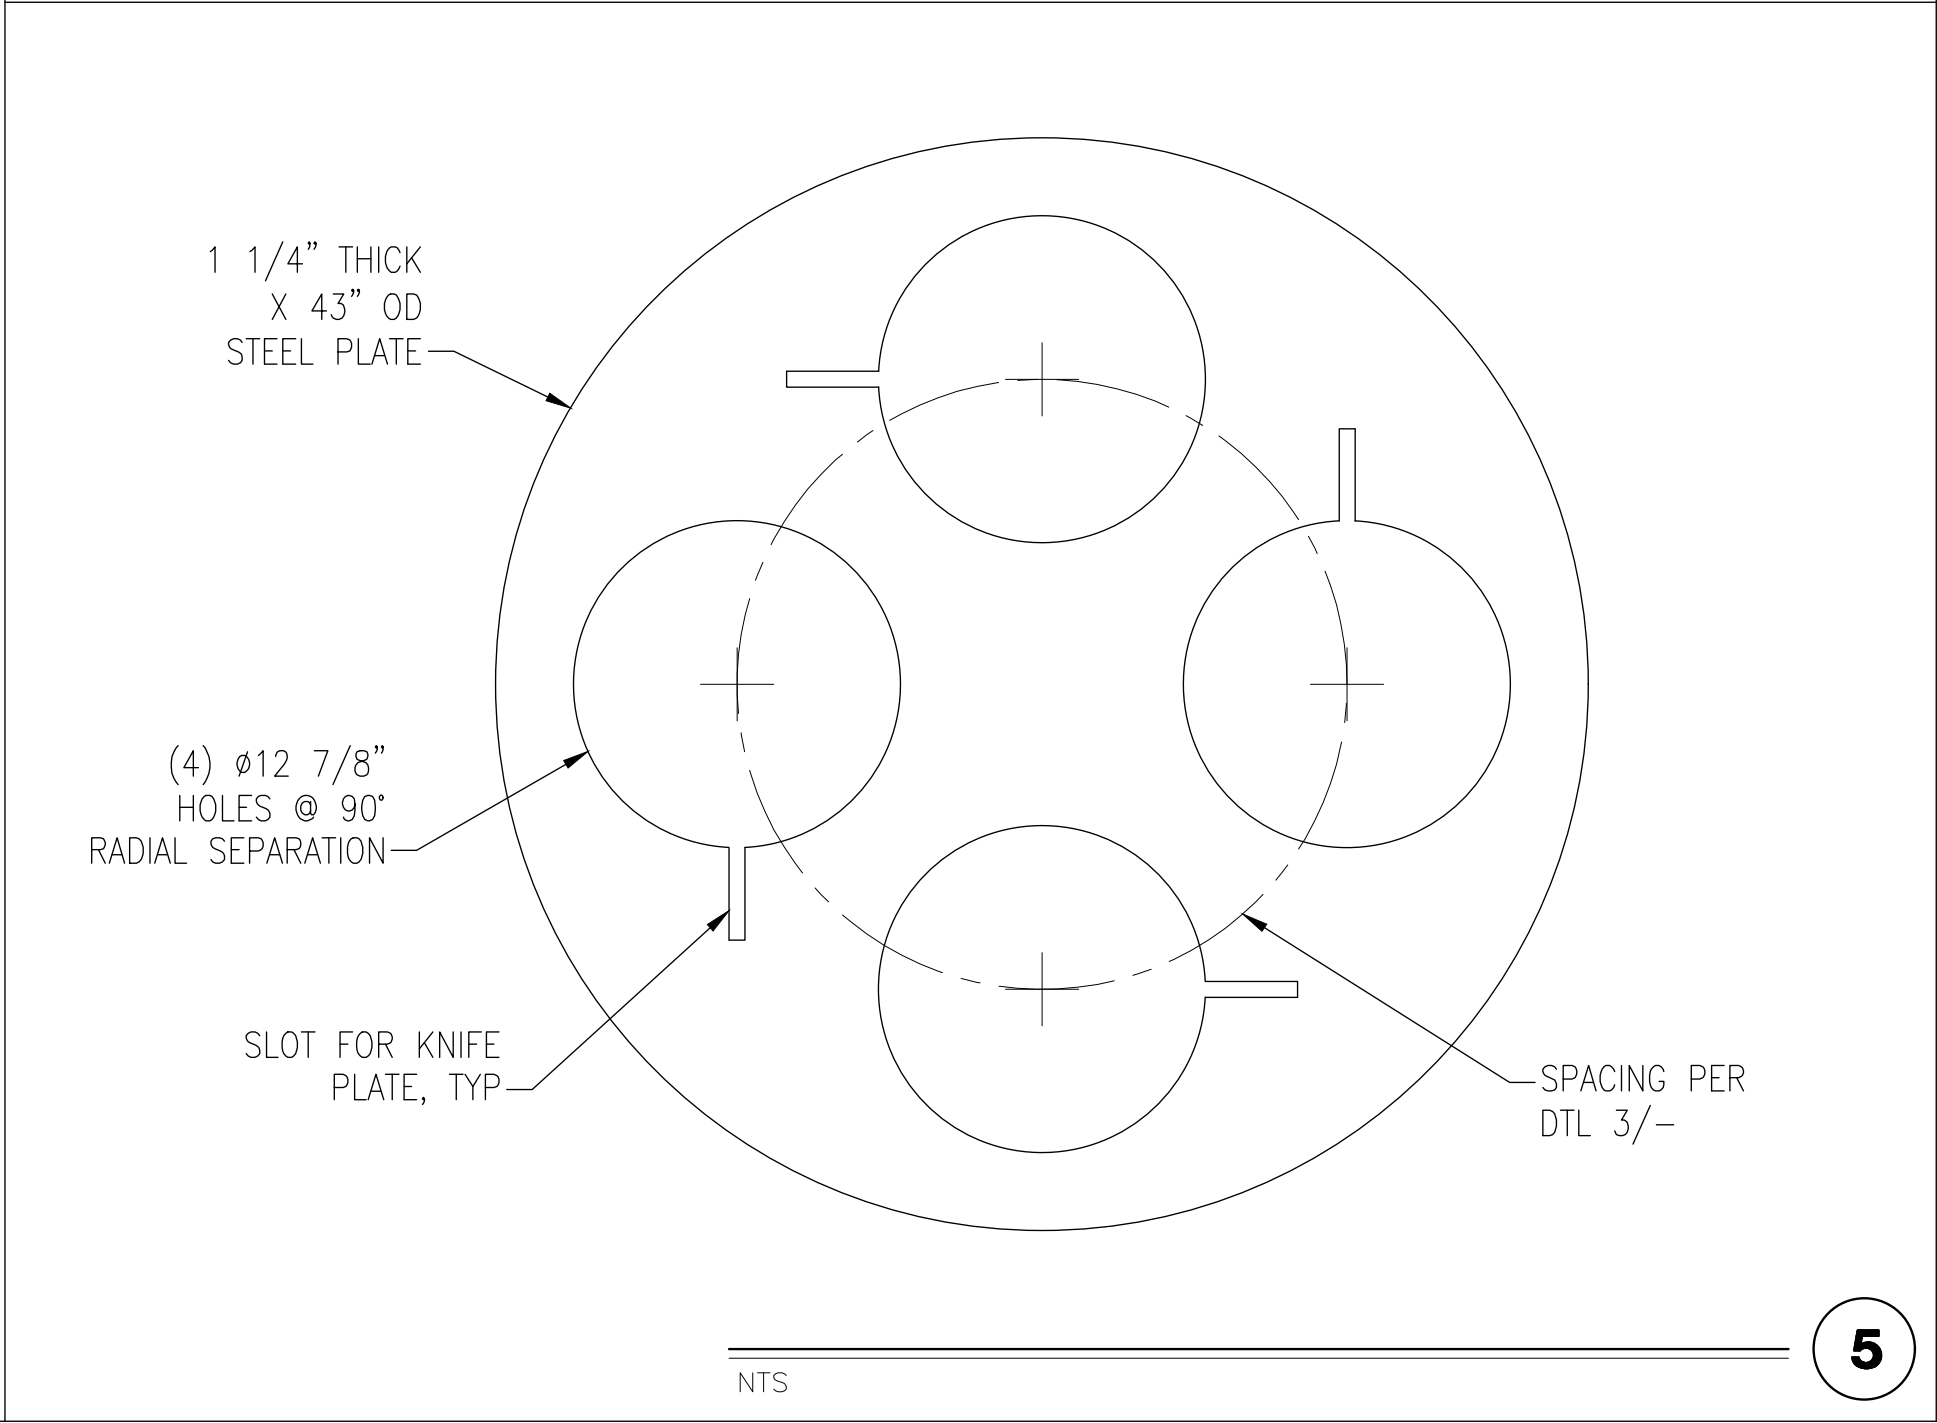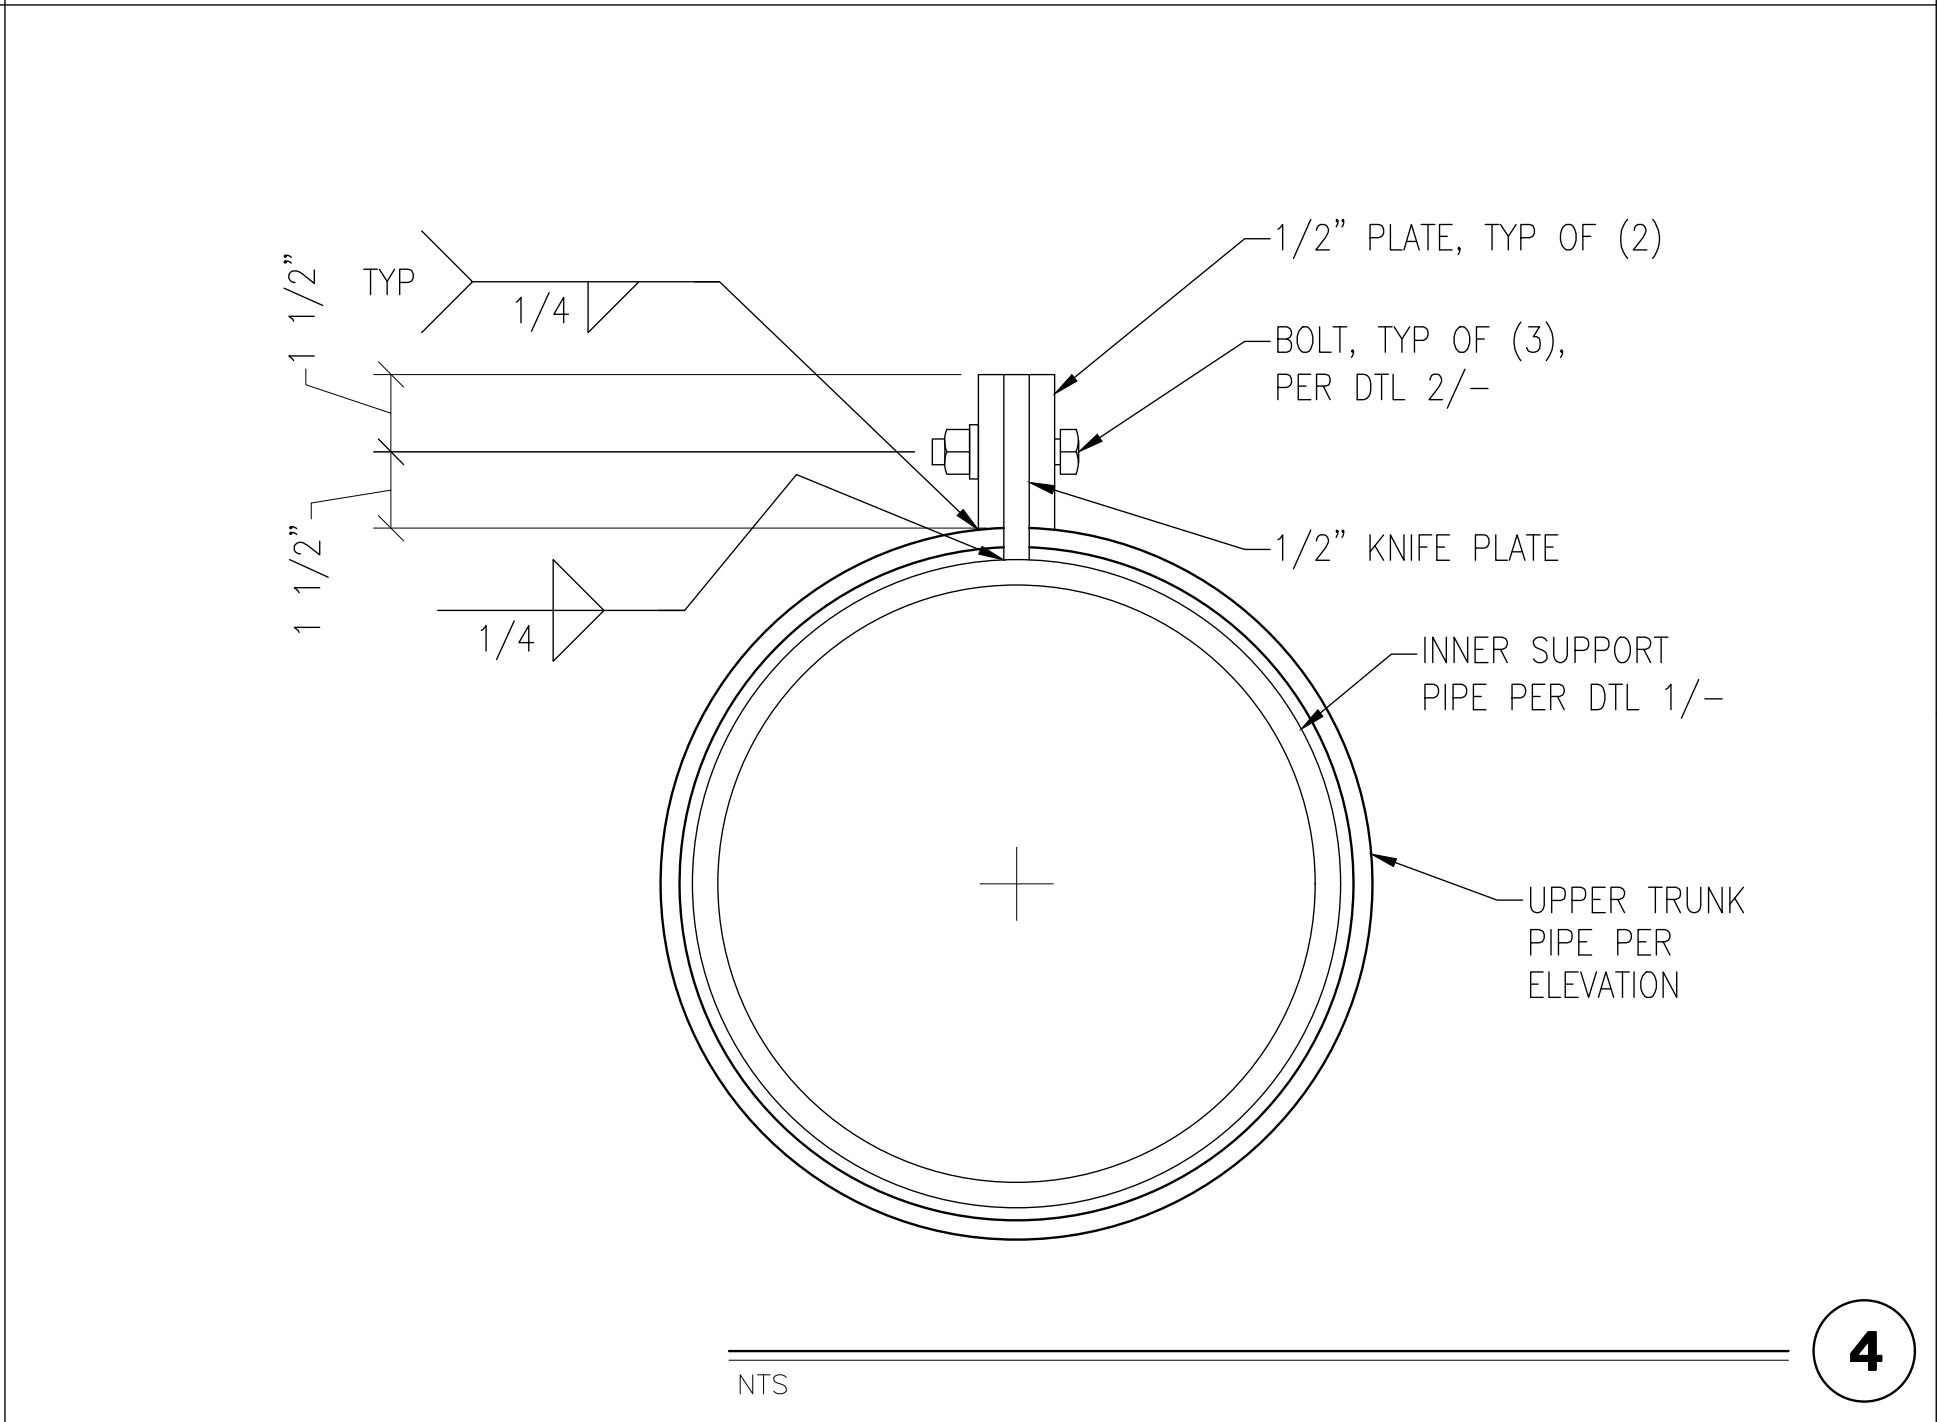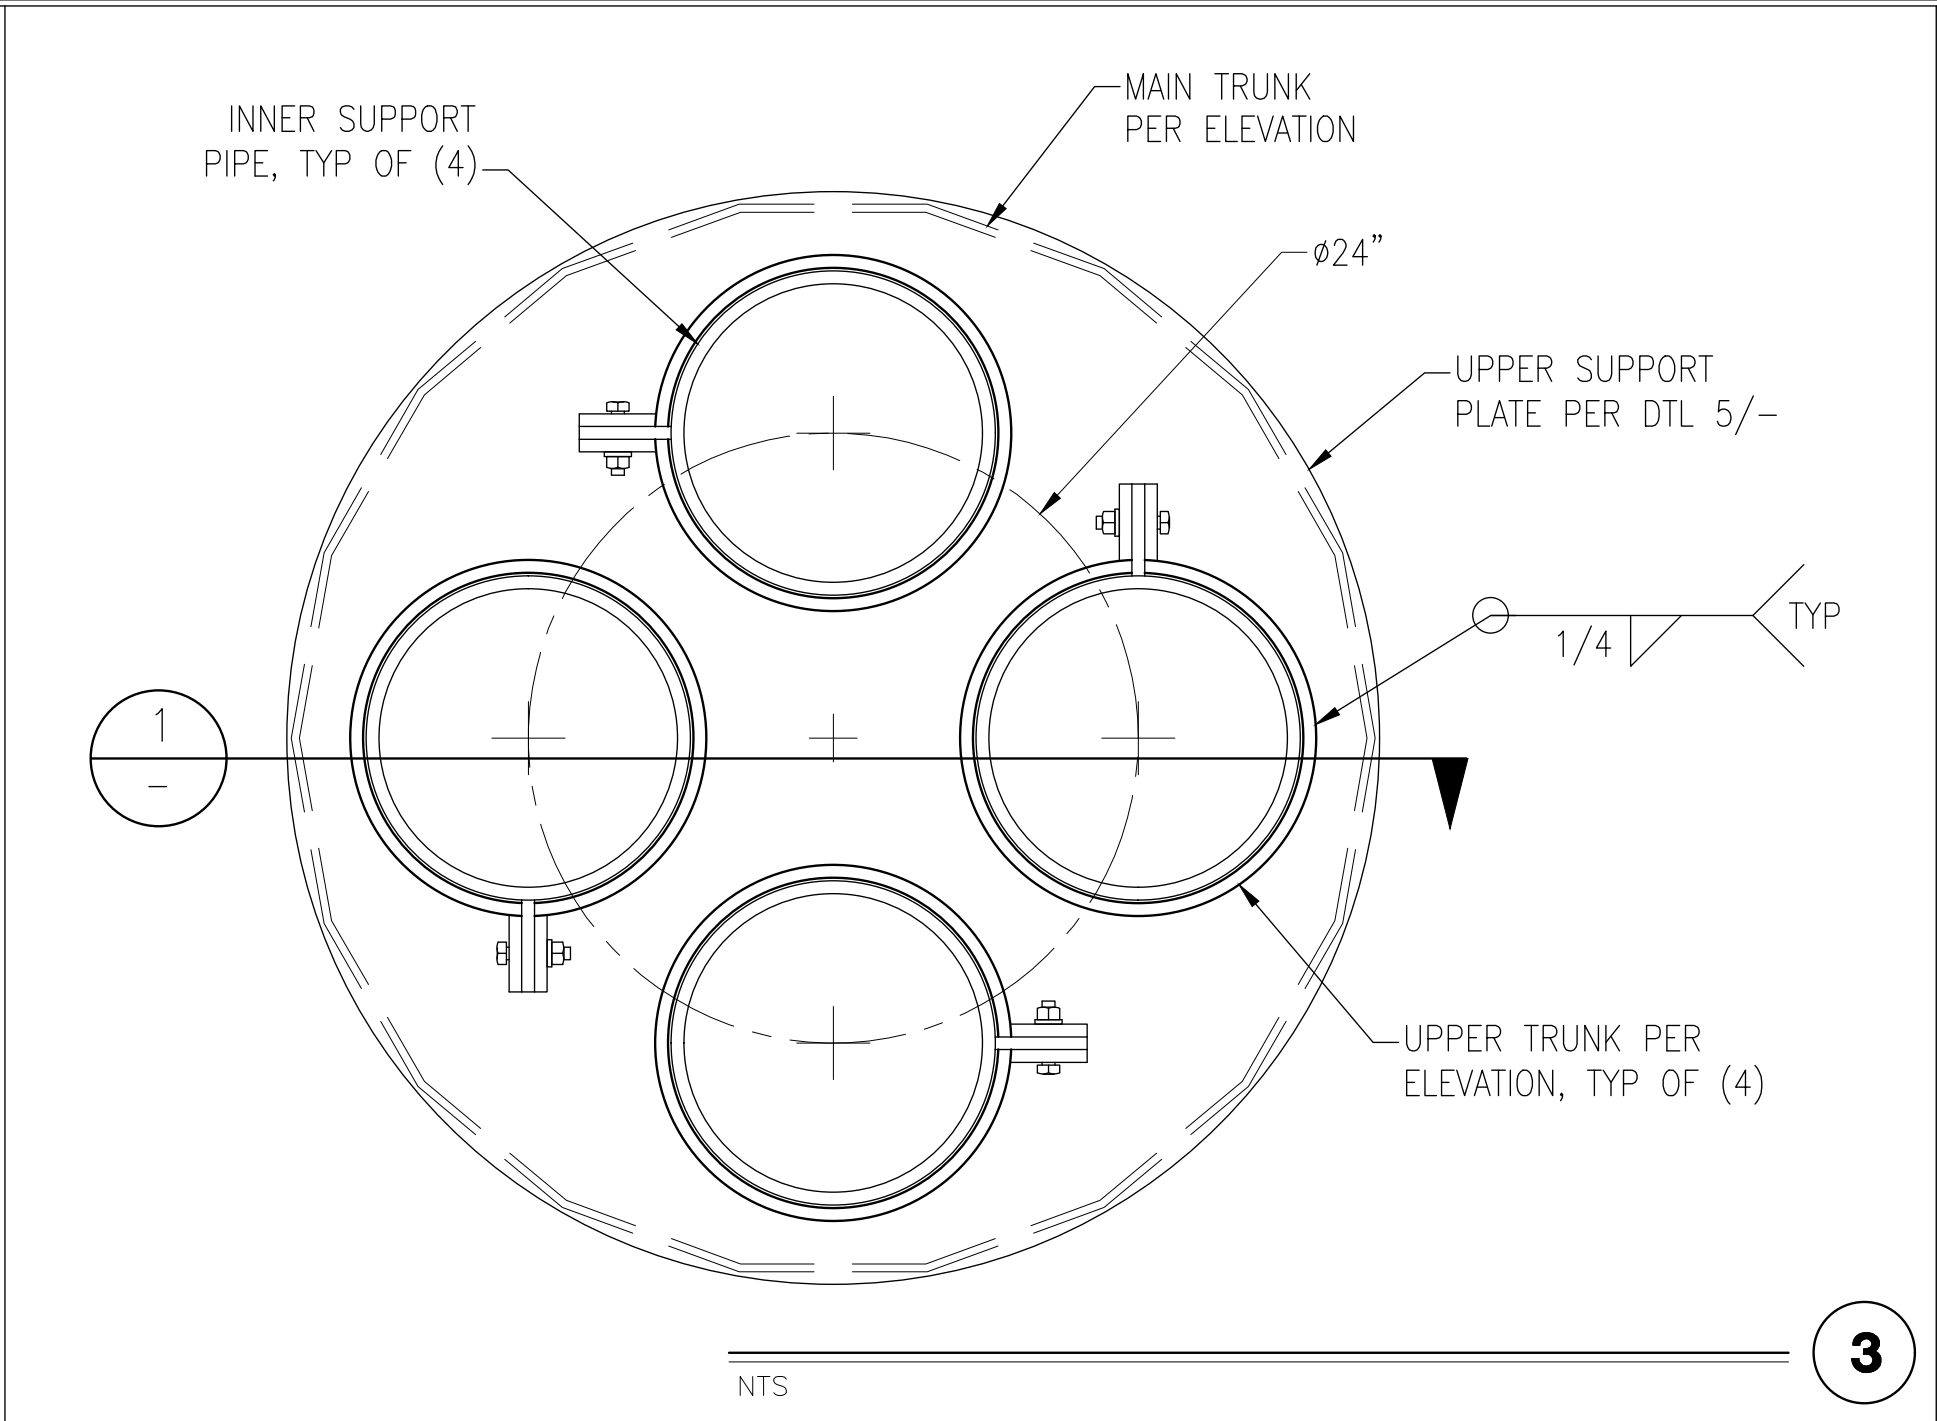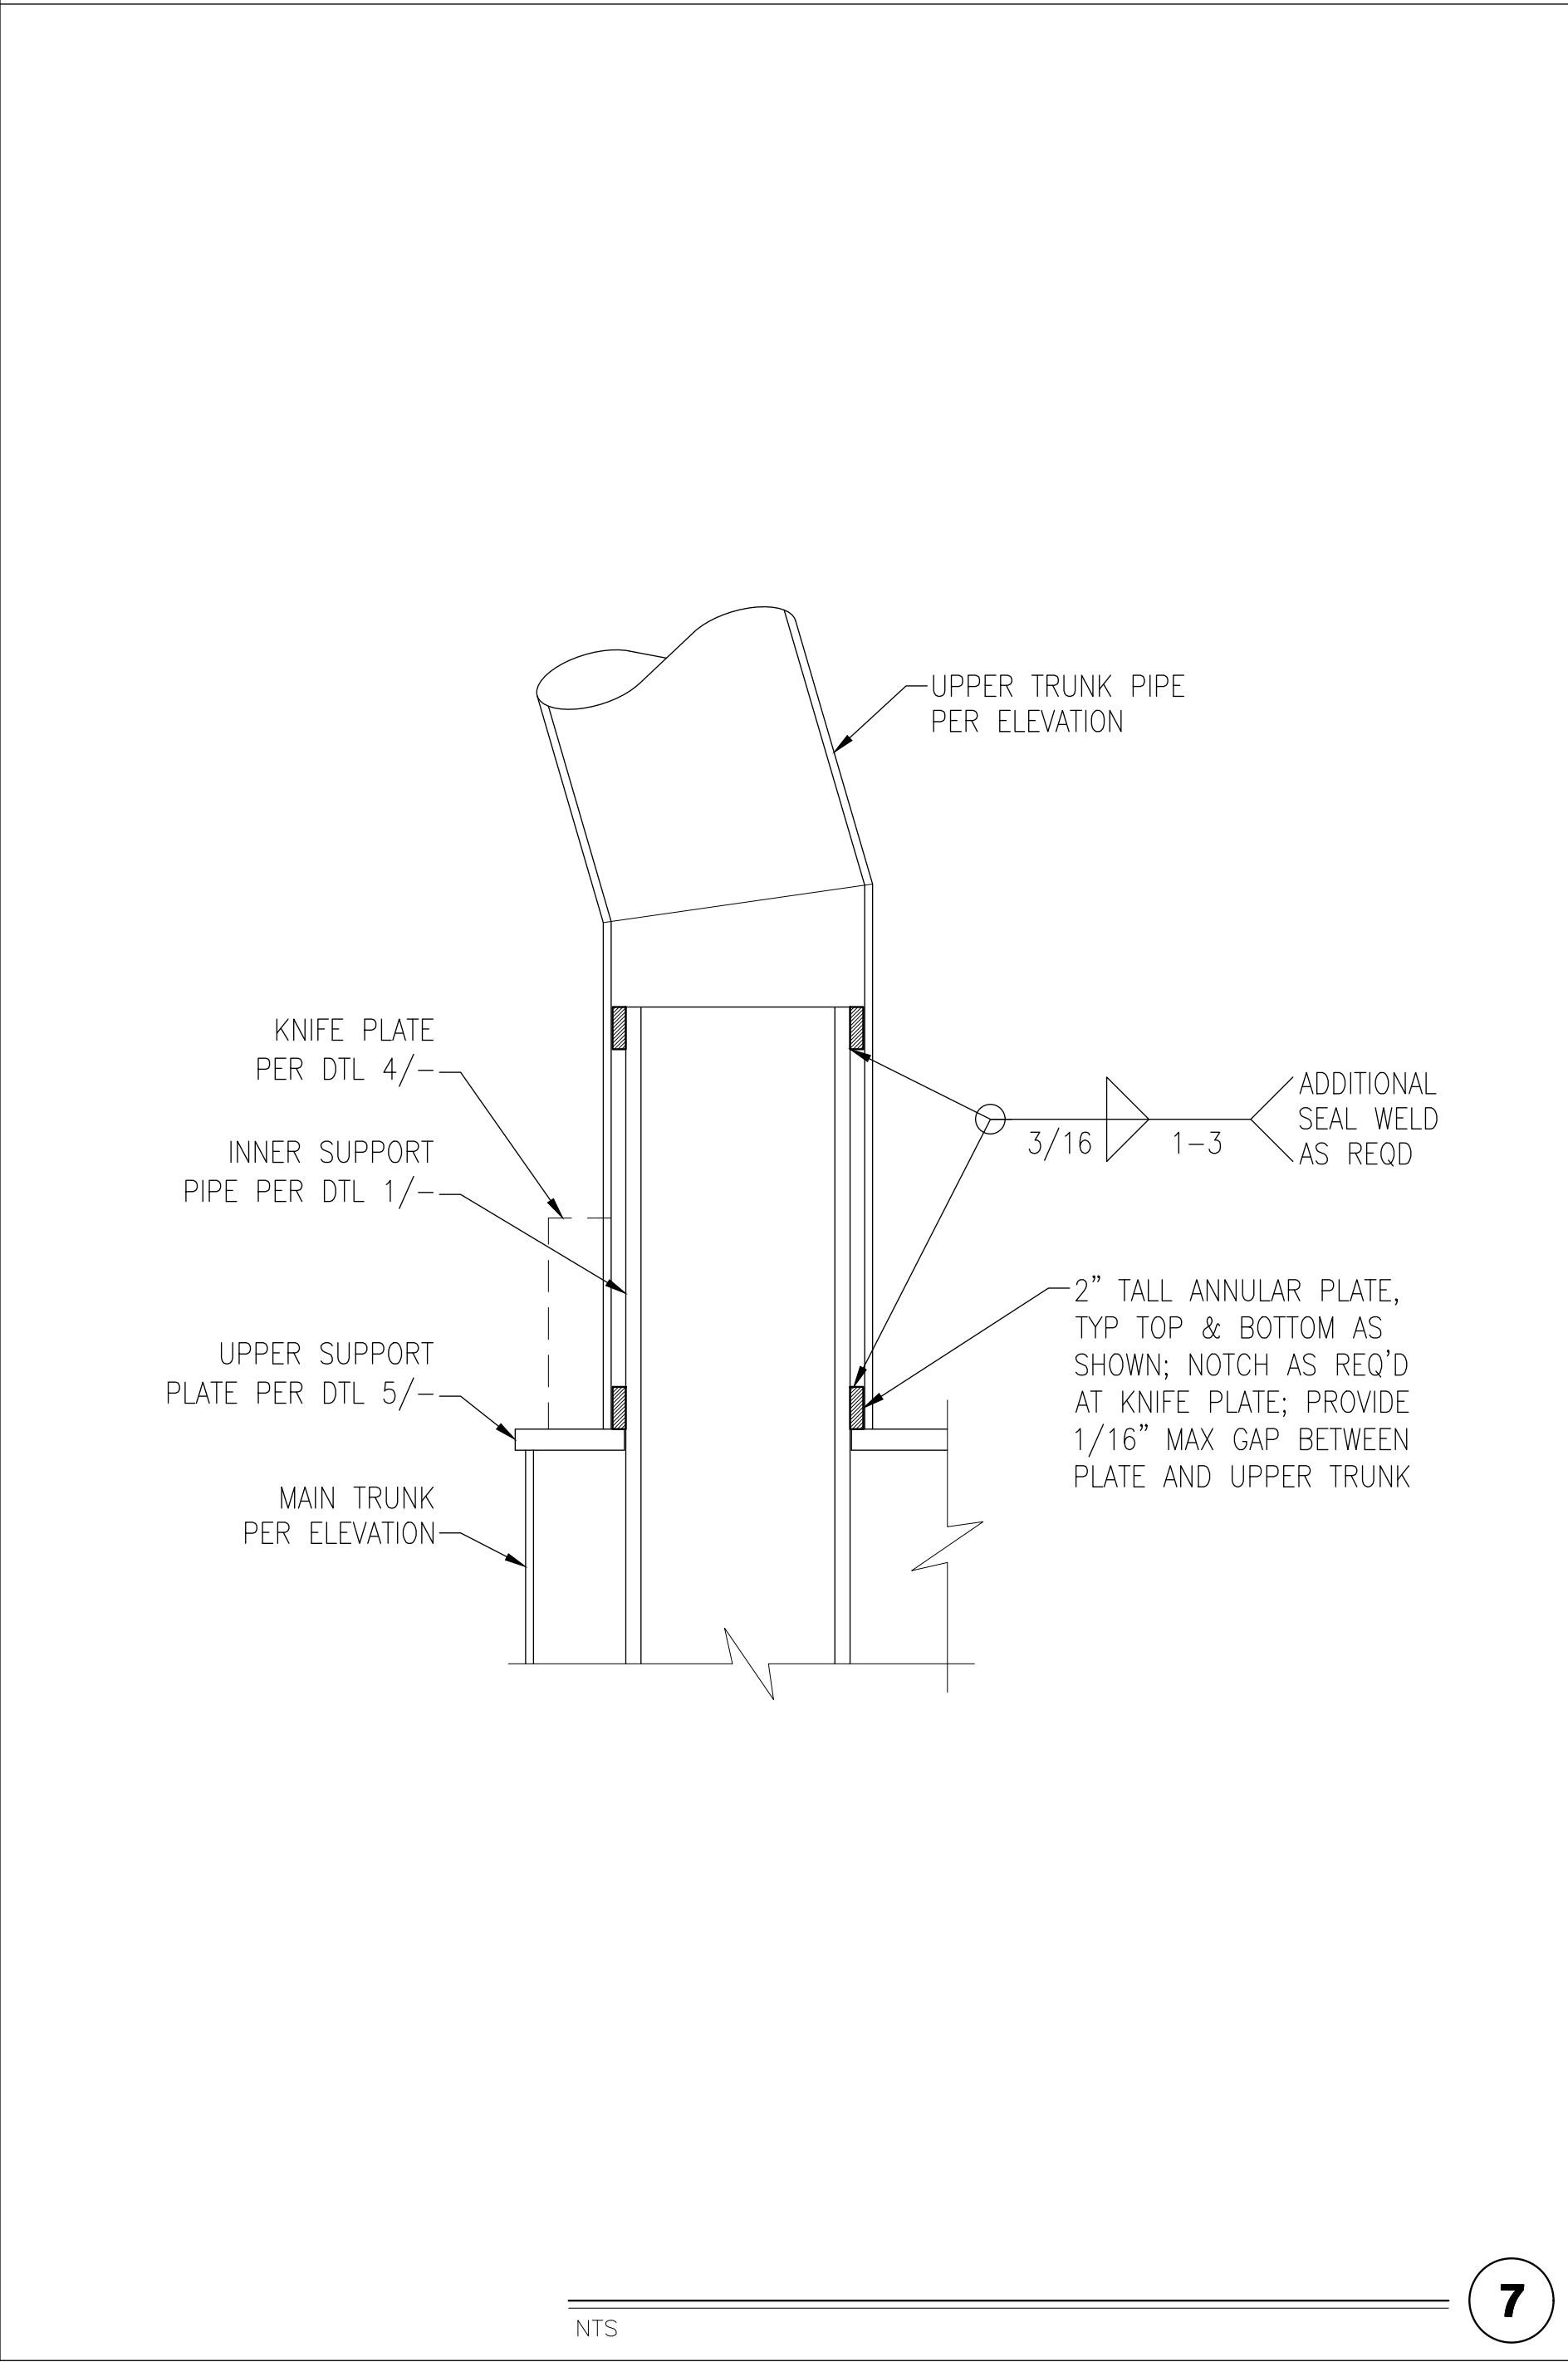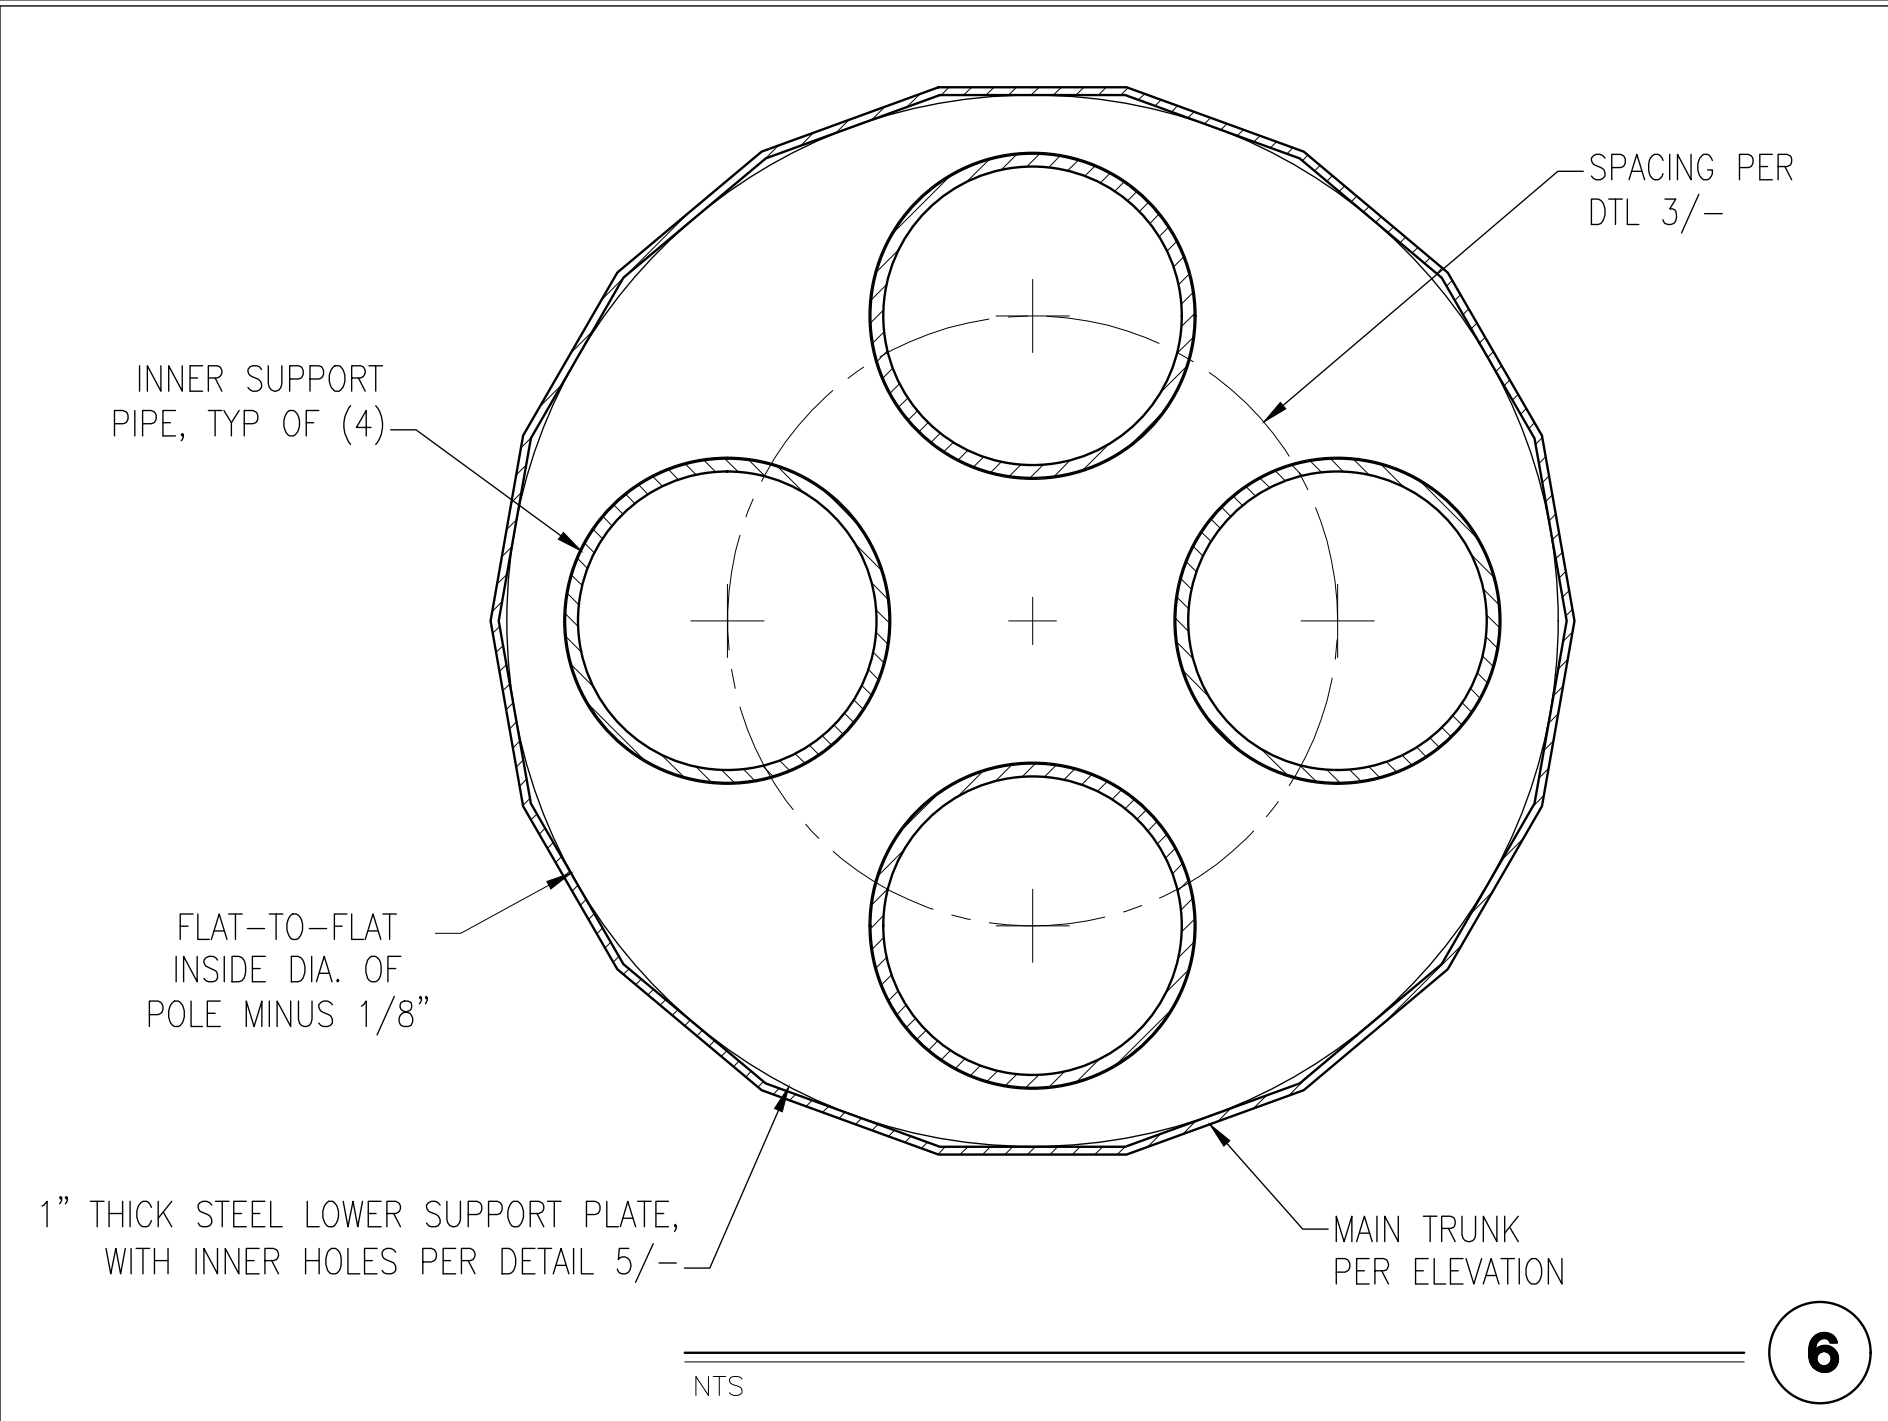PORT SCHEDULE					
CL ELEV.	PORT SIZE (B x H)	D	T	QTY	AZIMUTH(S)
53'-0"	6"x12"	3"	1/2"	1	T.B.D.
42'-0"	6"x12"	3"	1/2"	1	T.B.D.
15'-0"	12"x25"	3"	3/4"	2	180° SEPARATION
3'-0"	12"x25"	3"	3/4"	2	180° SEPARATION


NOTES:
1. SEE SCHEDULE FOR PORT QUANTITY & AZIMUTHS.
2. SEE SHEET S1 FOR POLE SHAFT THICKNESS, t.
3. SEE GENERAL NOTES FOR REINFORCED PORT MATERIAL GRADE.
4. H REPRESENTS THE PORT HEIGHT OUT-TO-OUT.

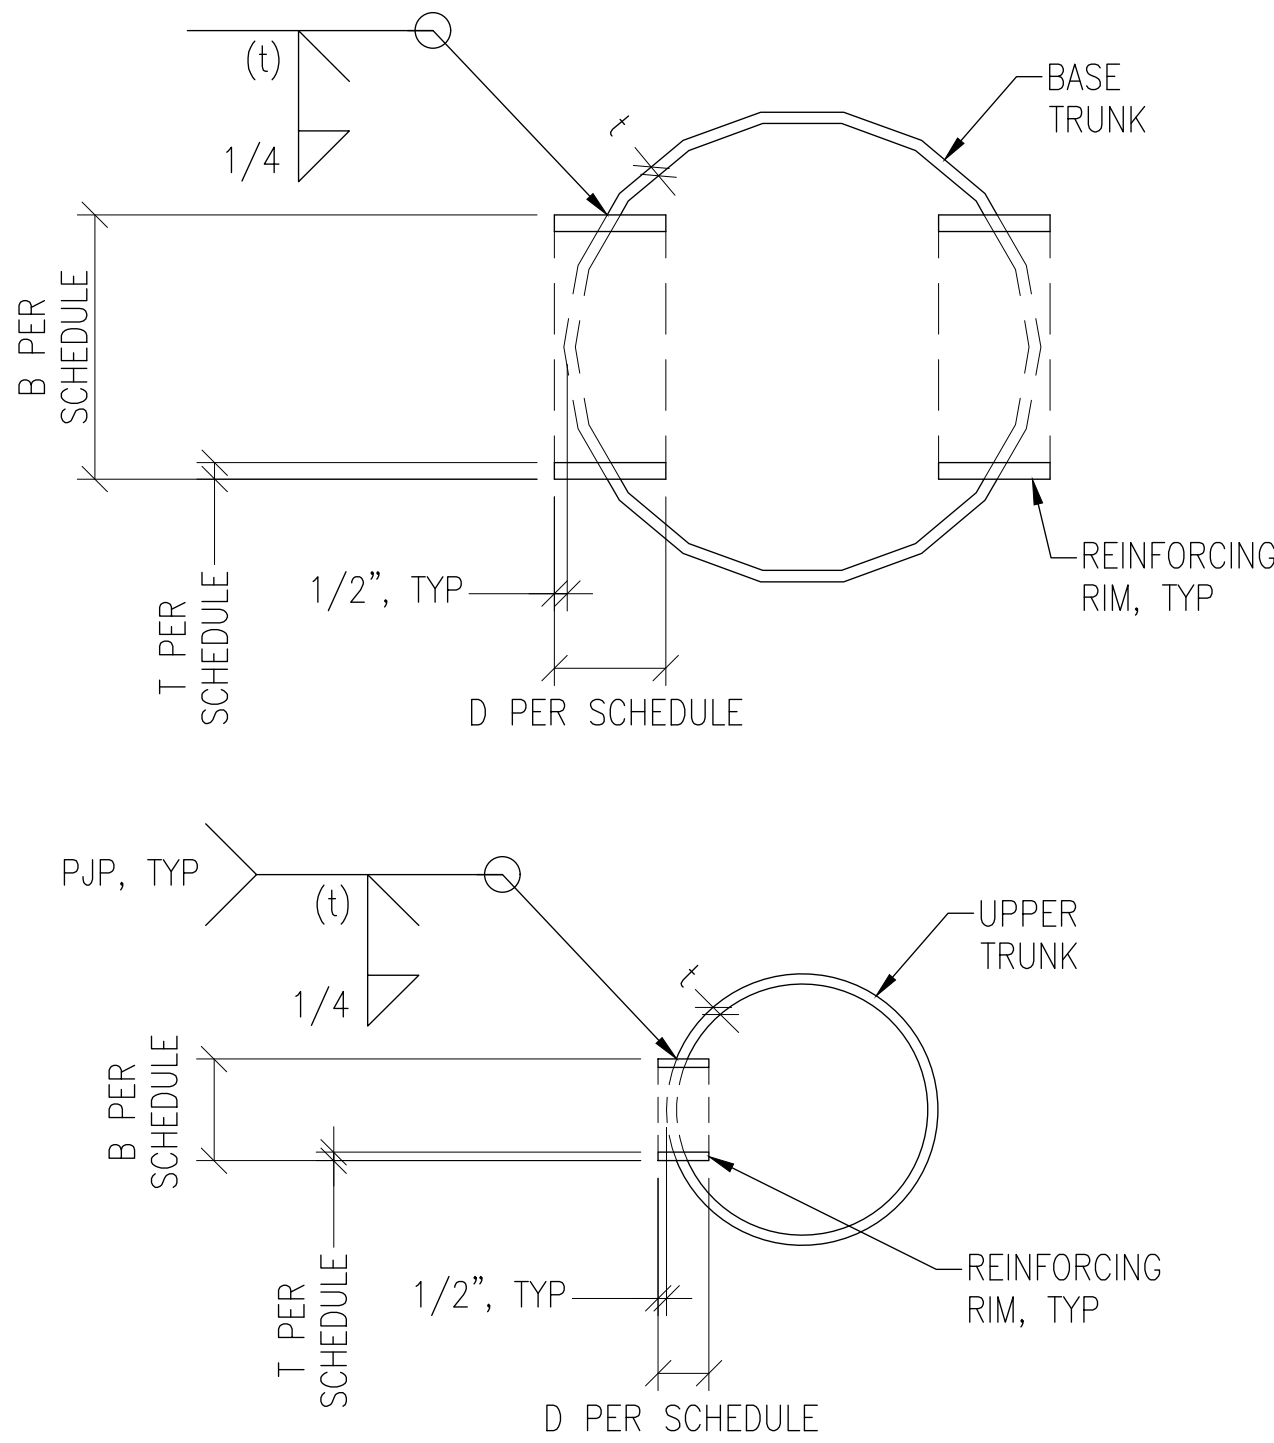

REINFORCED ACCESS PORTS

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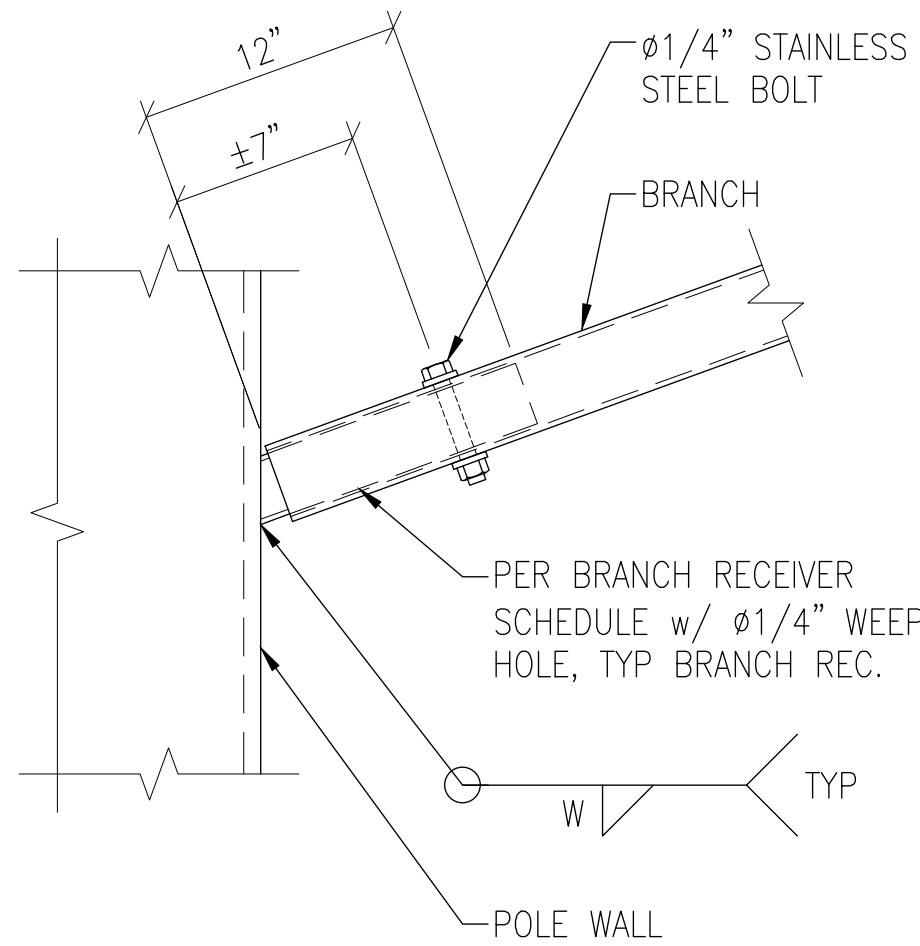
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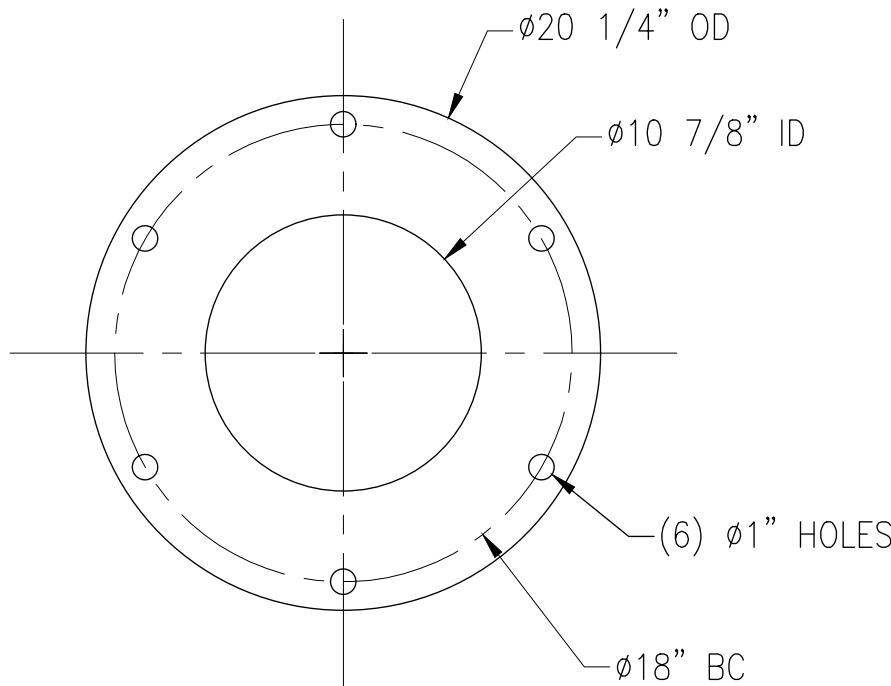
BRANCH RECEIVER SCHEDULE			
BRANCH LENGTH	YIELD STRENGTH (KSI)	SIZE	W
4'-0"	35	1 1/4" SCH 40	3/16
6'-0"	35	1 1/4" SCH 40	3/16
8'-0"	35	1 1/4" SCH 40	3/16
10'-0"	35	1 1/4" SCH 40	3/16

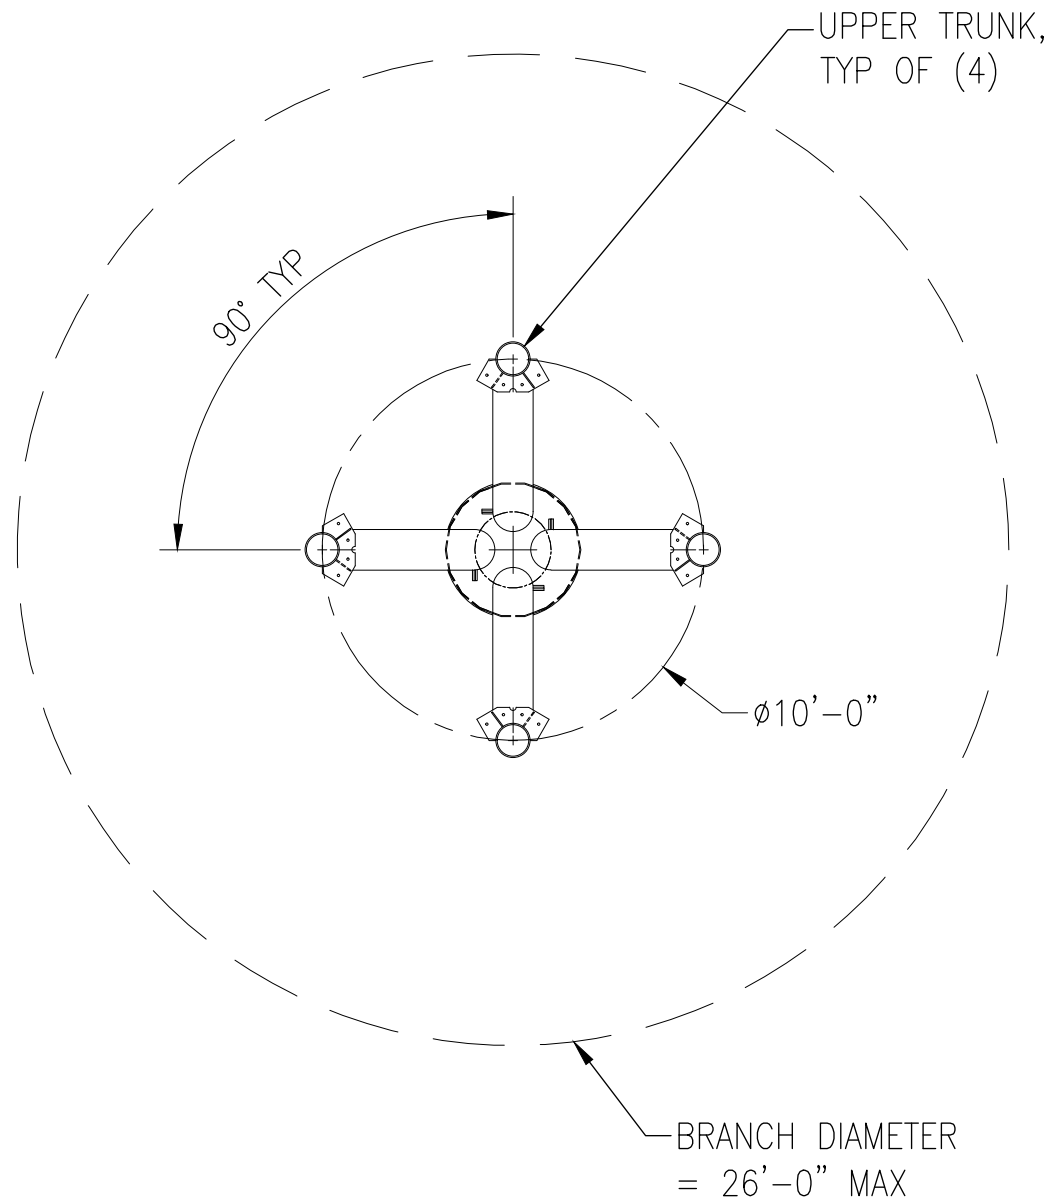


BRANCH RECEPTACLE, TYP

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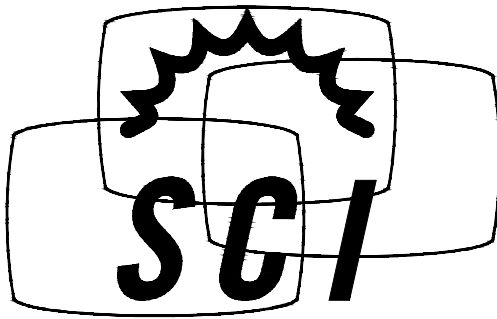
STEEL PLATE PLAN VIEW



ELEVATION VIEW

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3

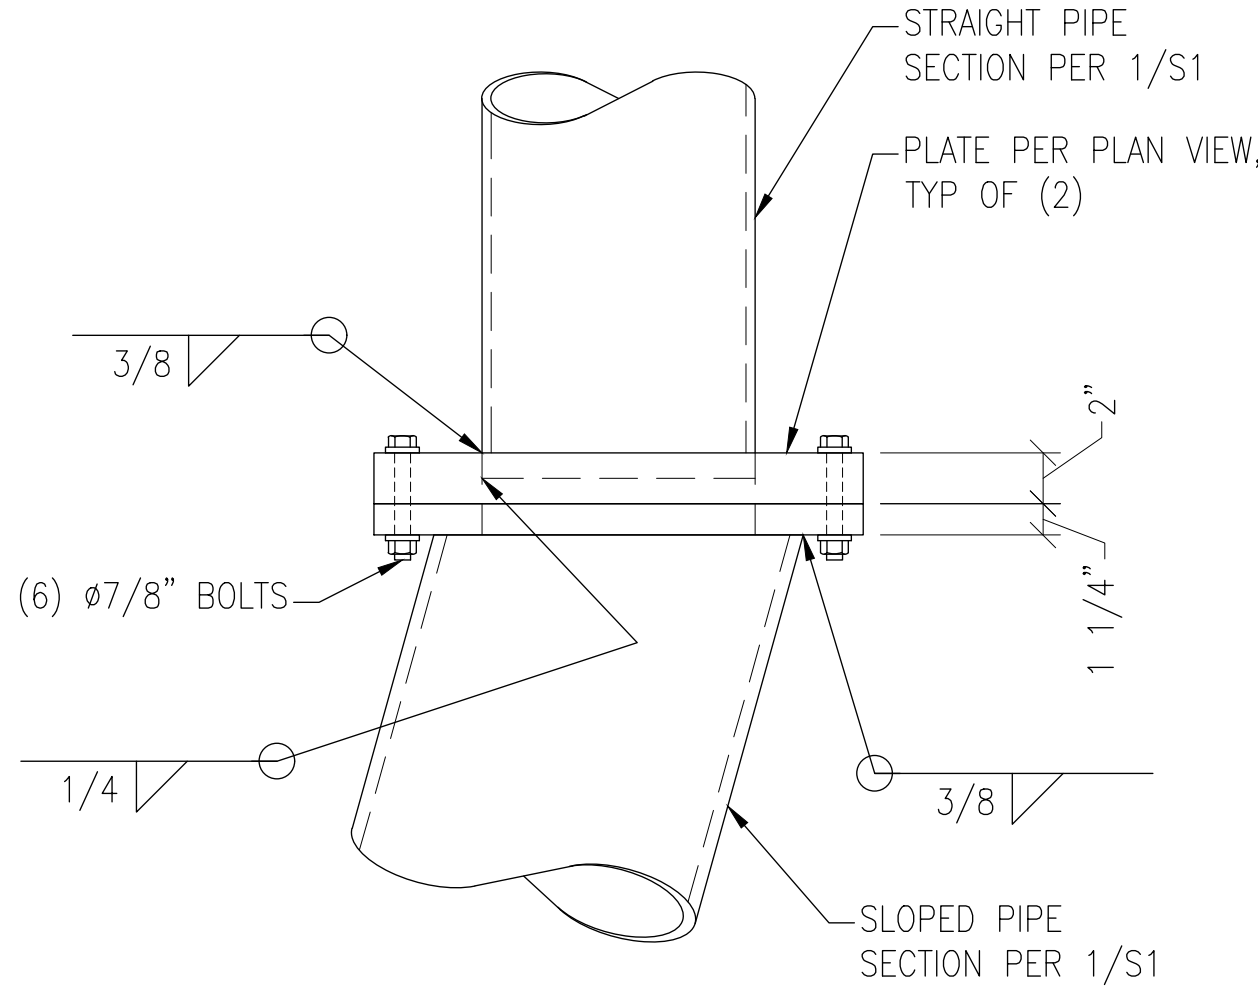

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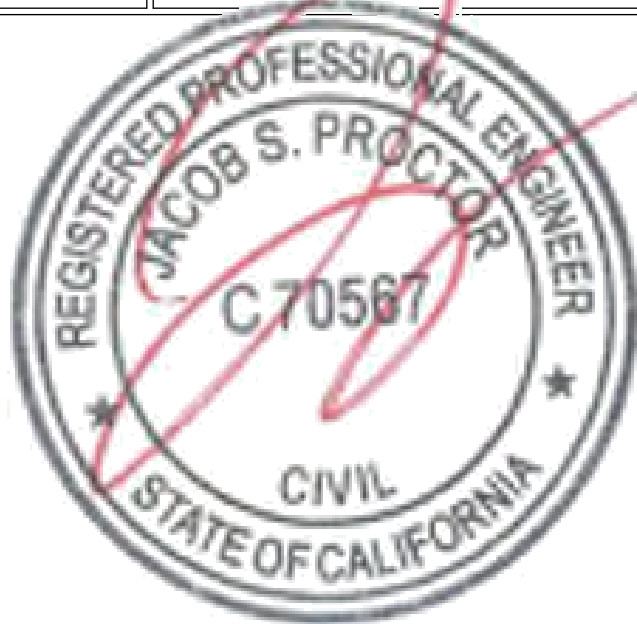
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DETAILS

CLL05463

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NOTE: REFER TO DTL 3/- FOR INFO NOT SHOWN.



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* NOTE: WHERE L EXCEEDS 12",
USE BRACE AT ONE LEVEL, TOP
OR BOTTOM PER DTL 4/-.
L NOT TO EXCEED 5'-0".



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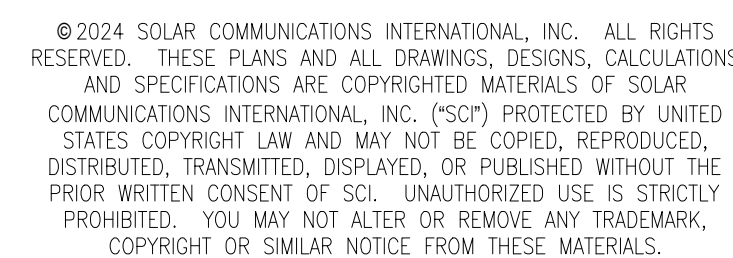
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NOTE: CONNECTION PLATE
& CROSS ARM NOT
SHOWN FOR CLARITY.

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(2



DETAILS

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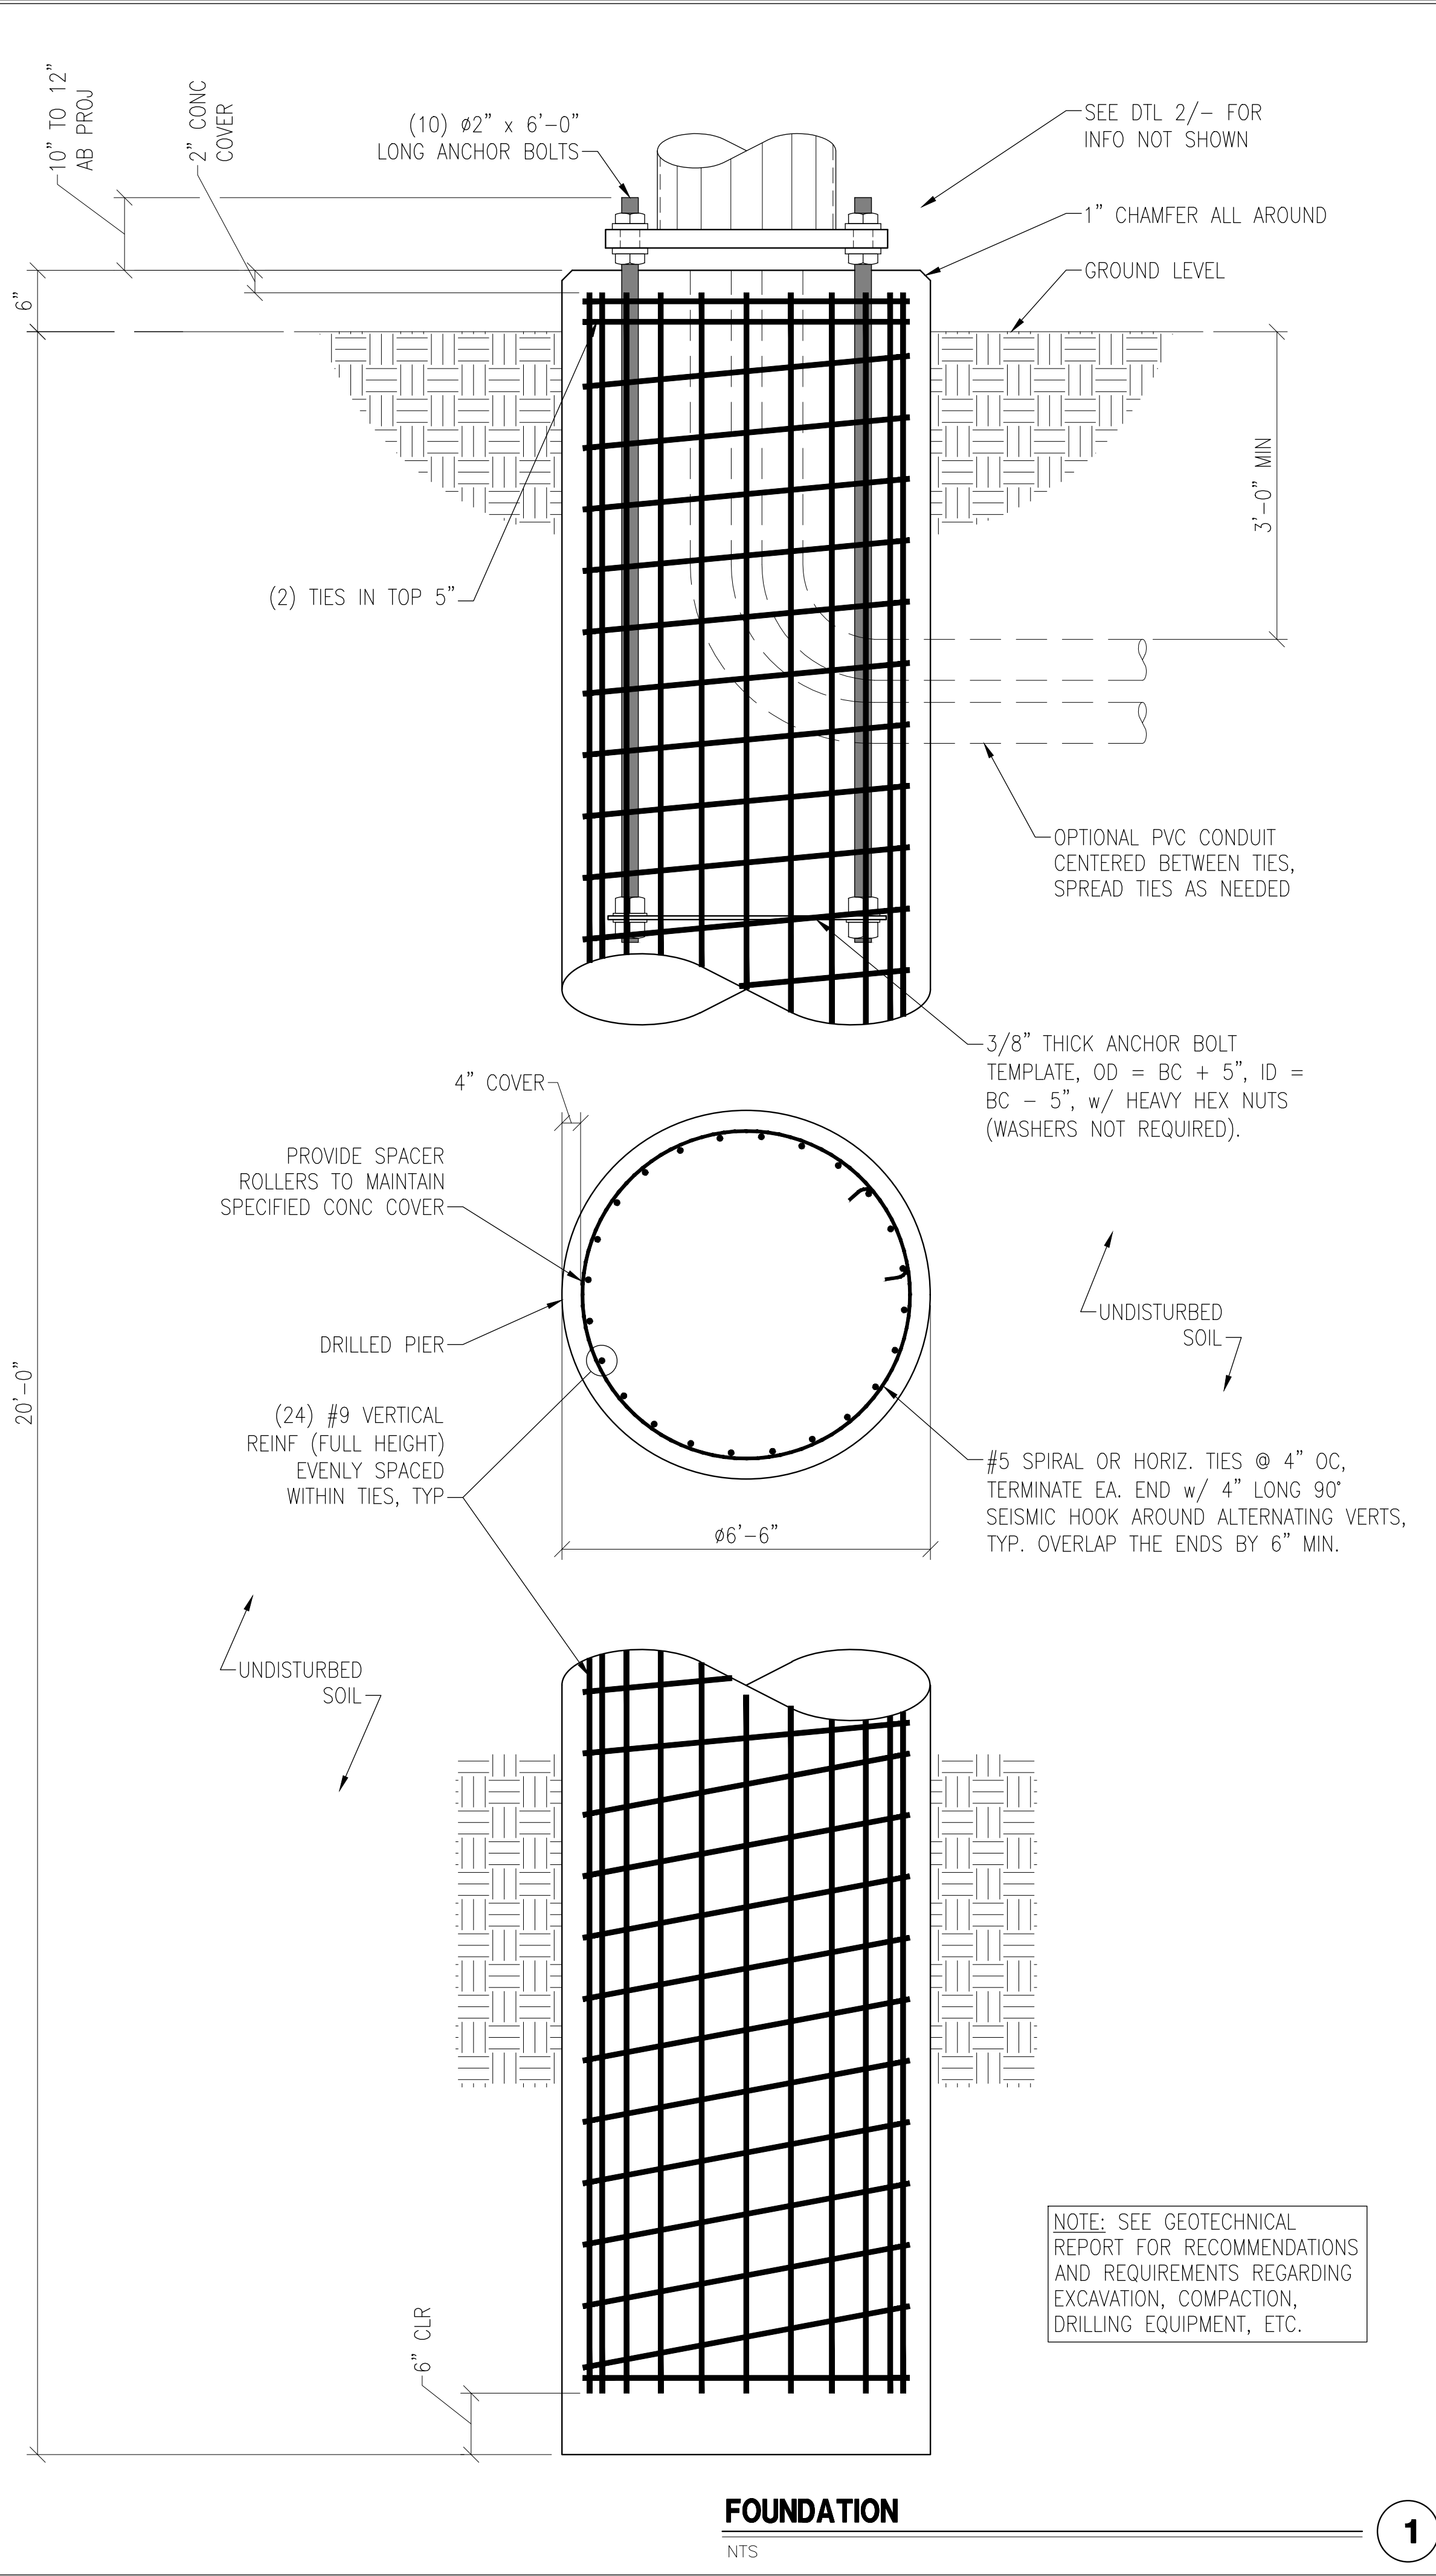
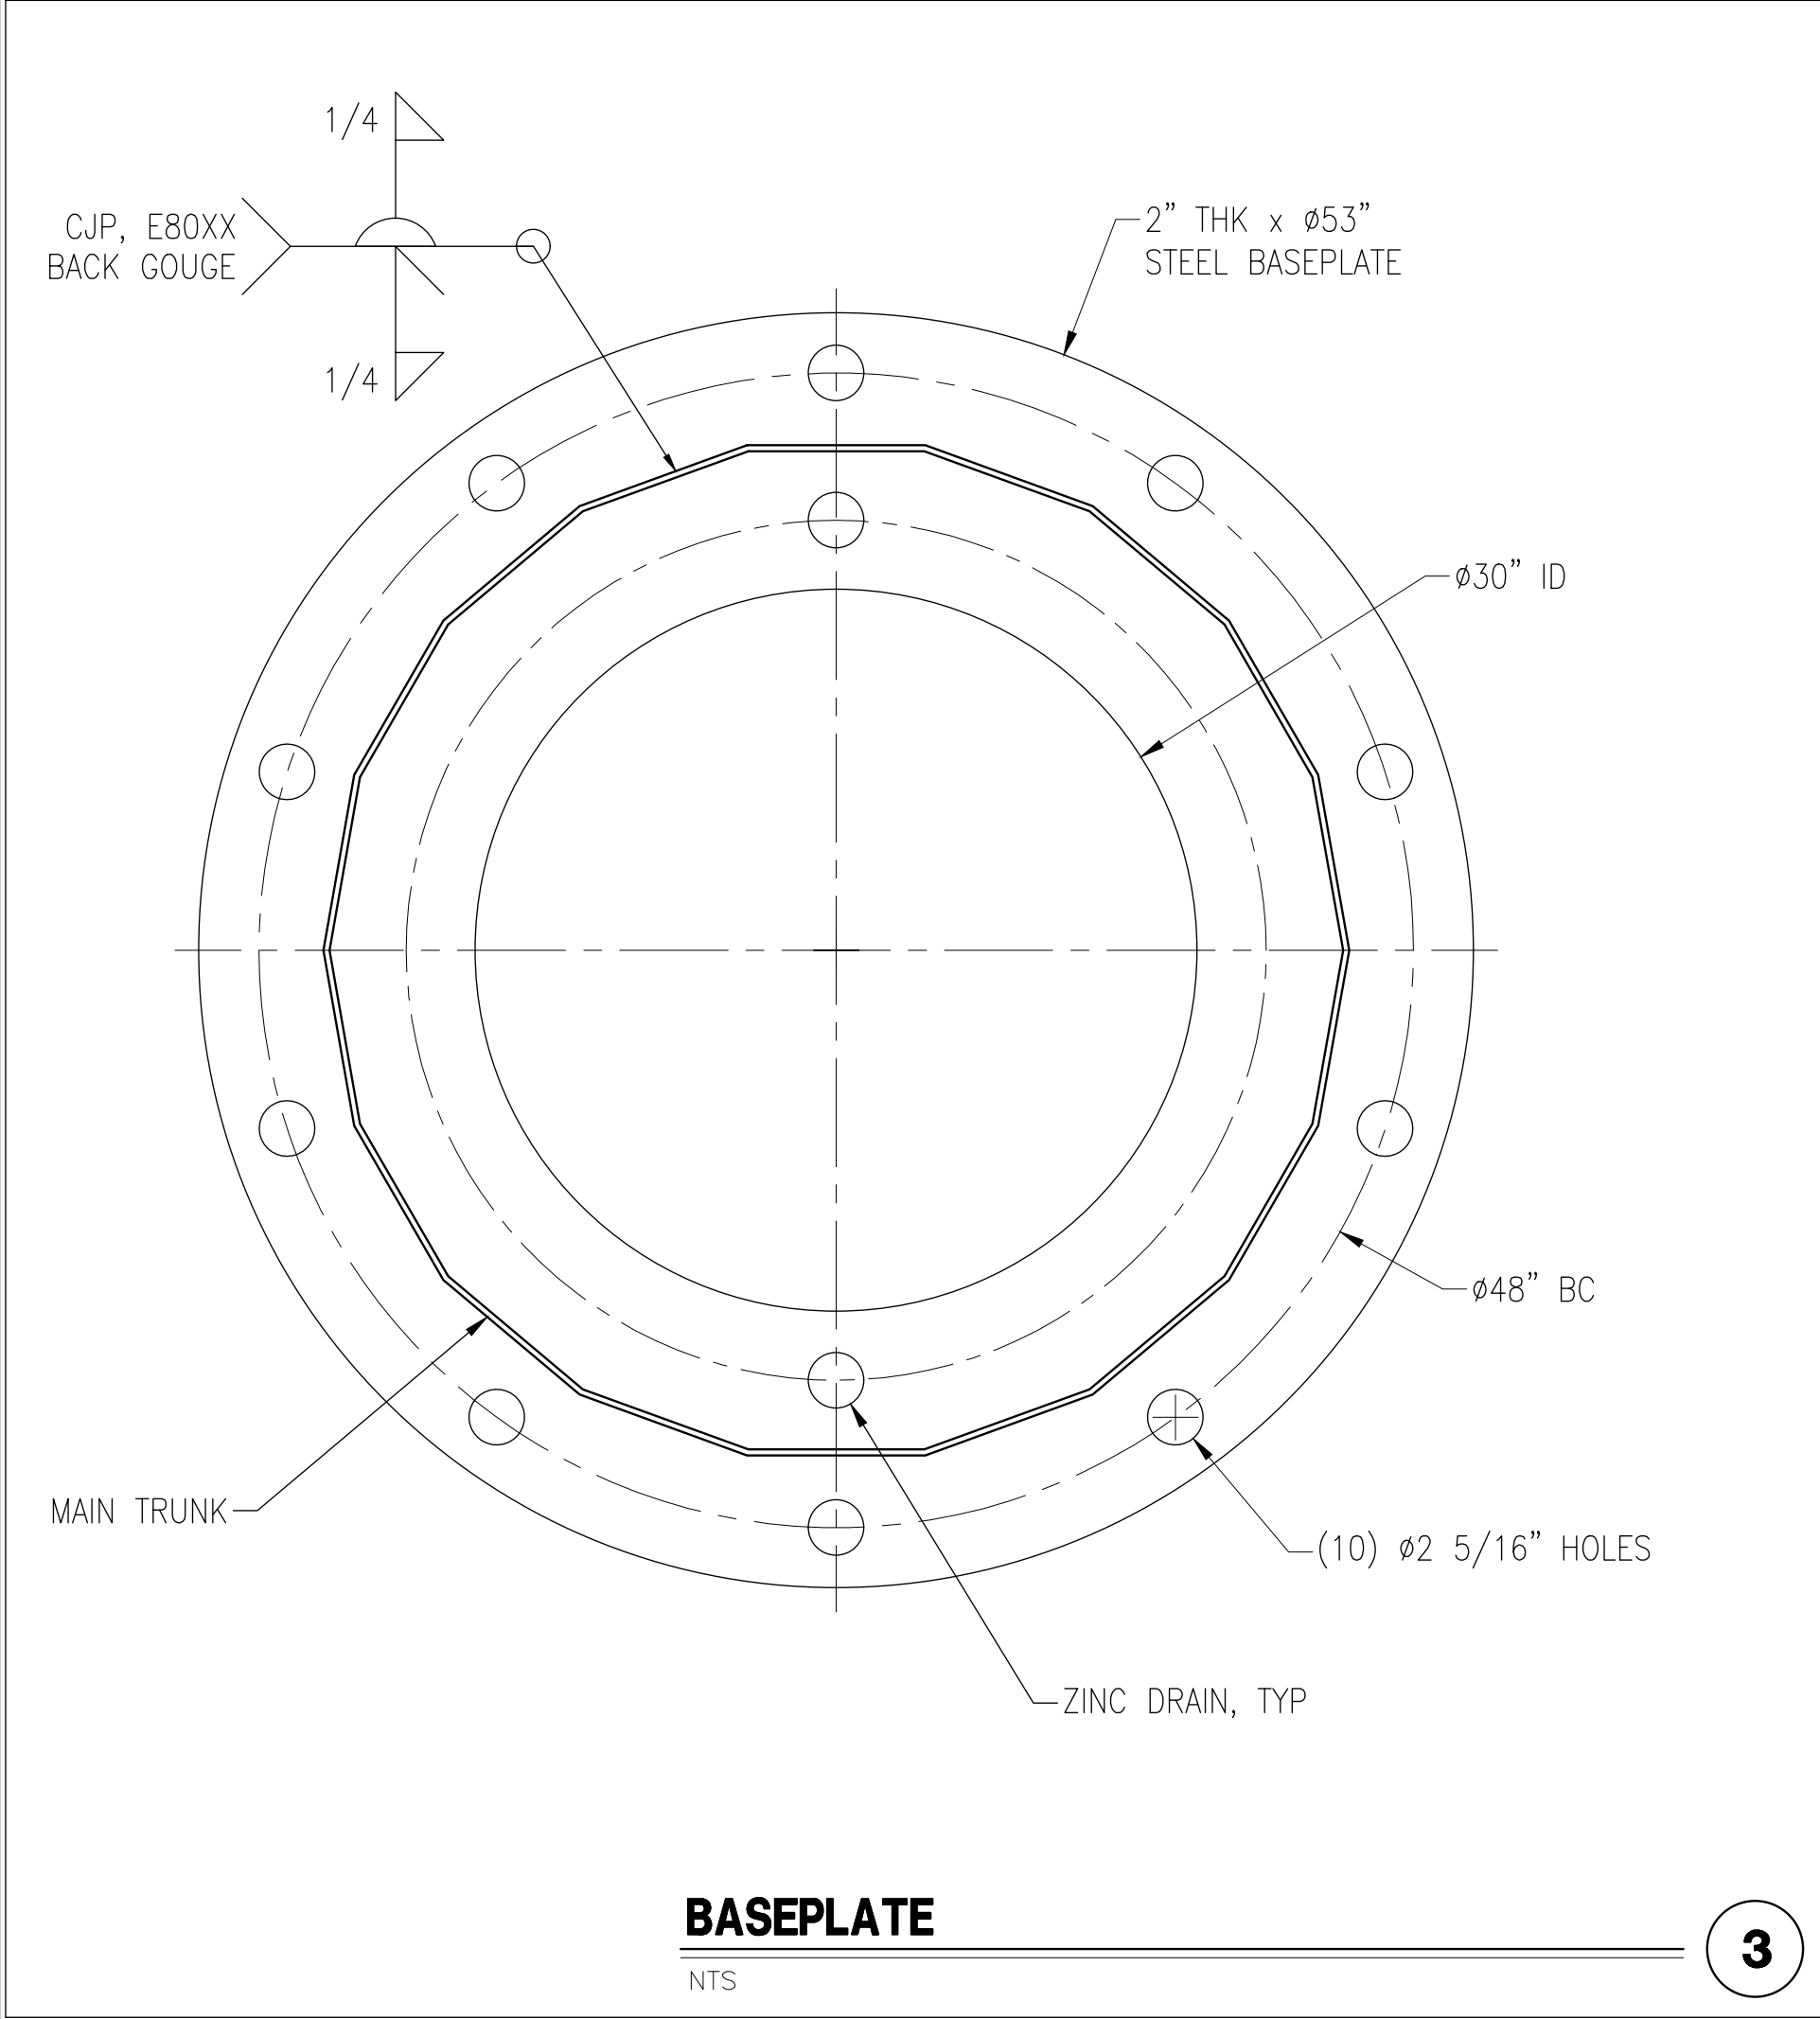
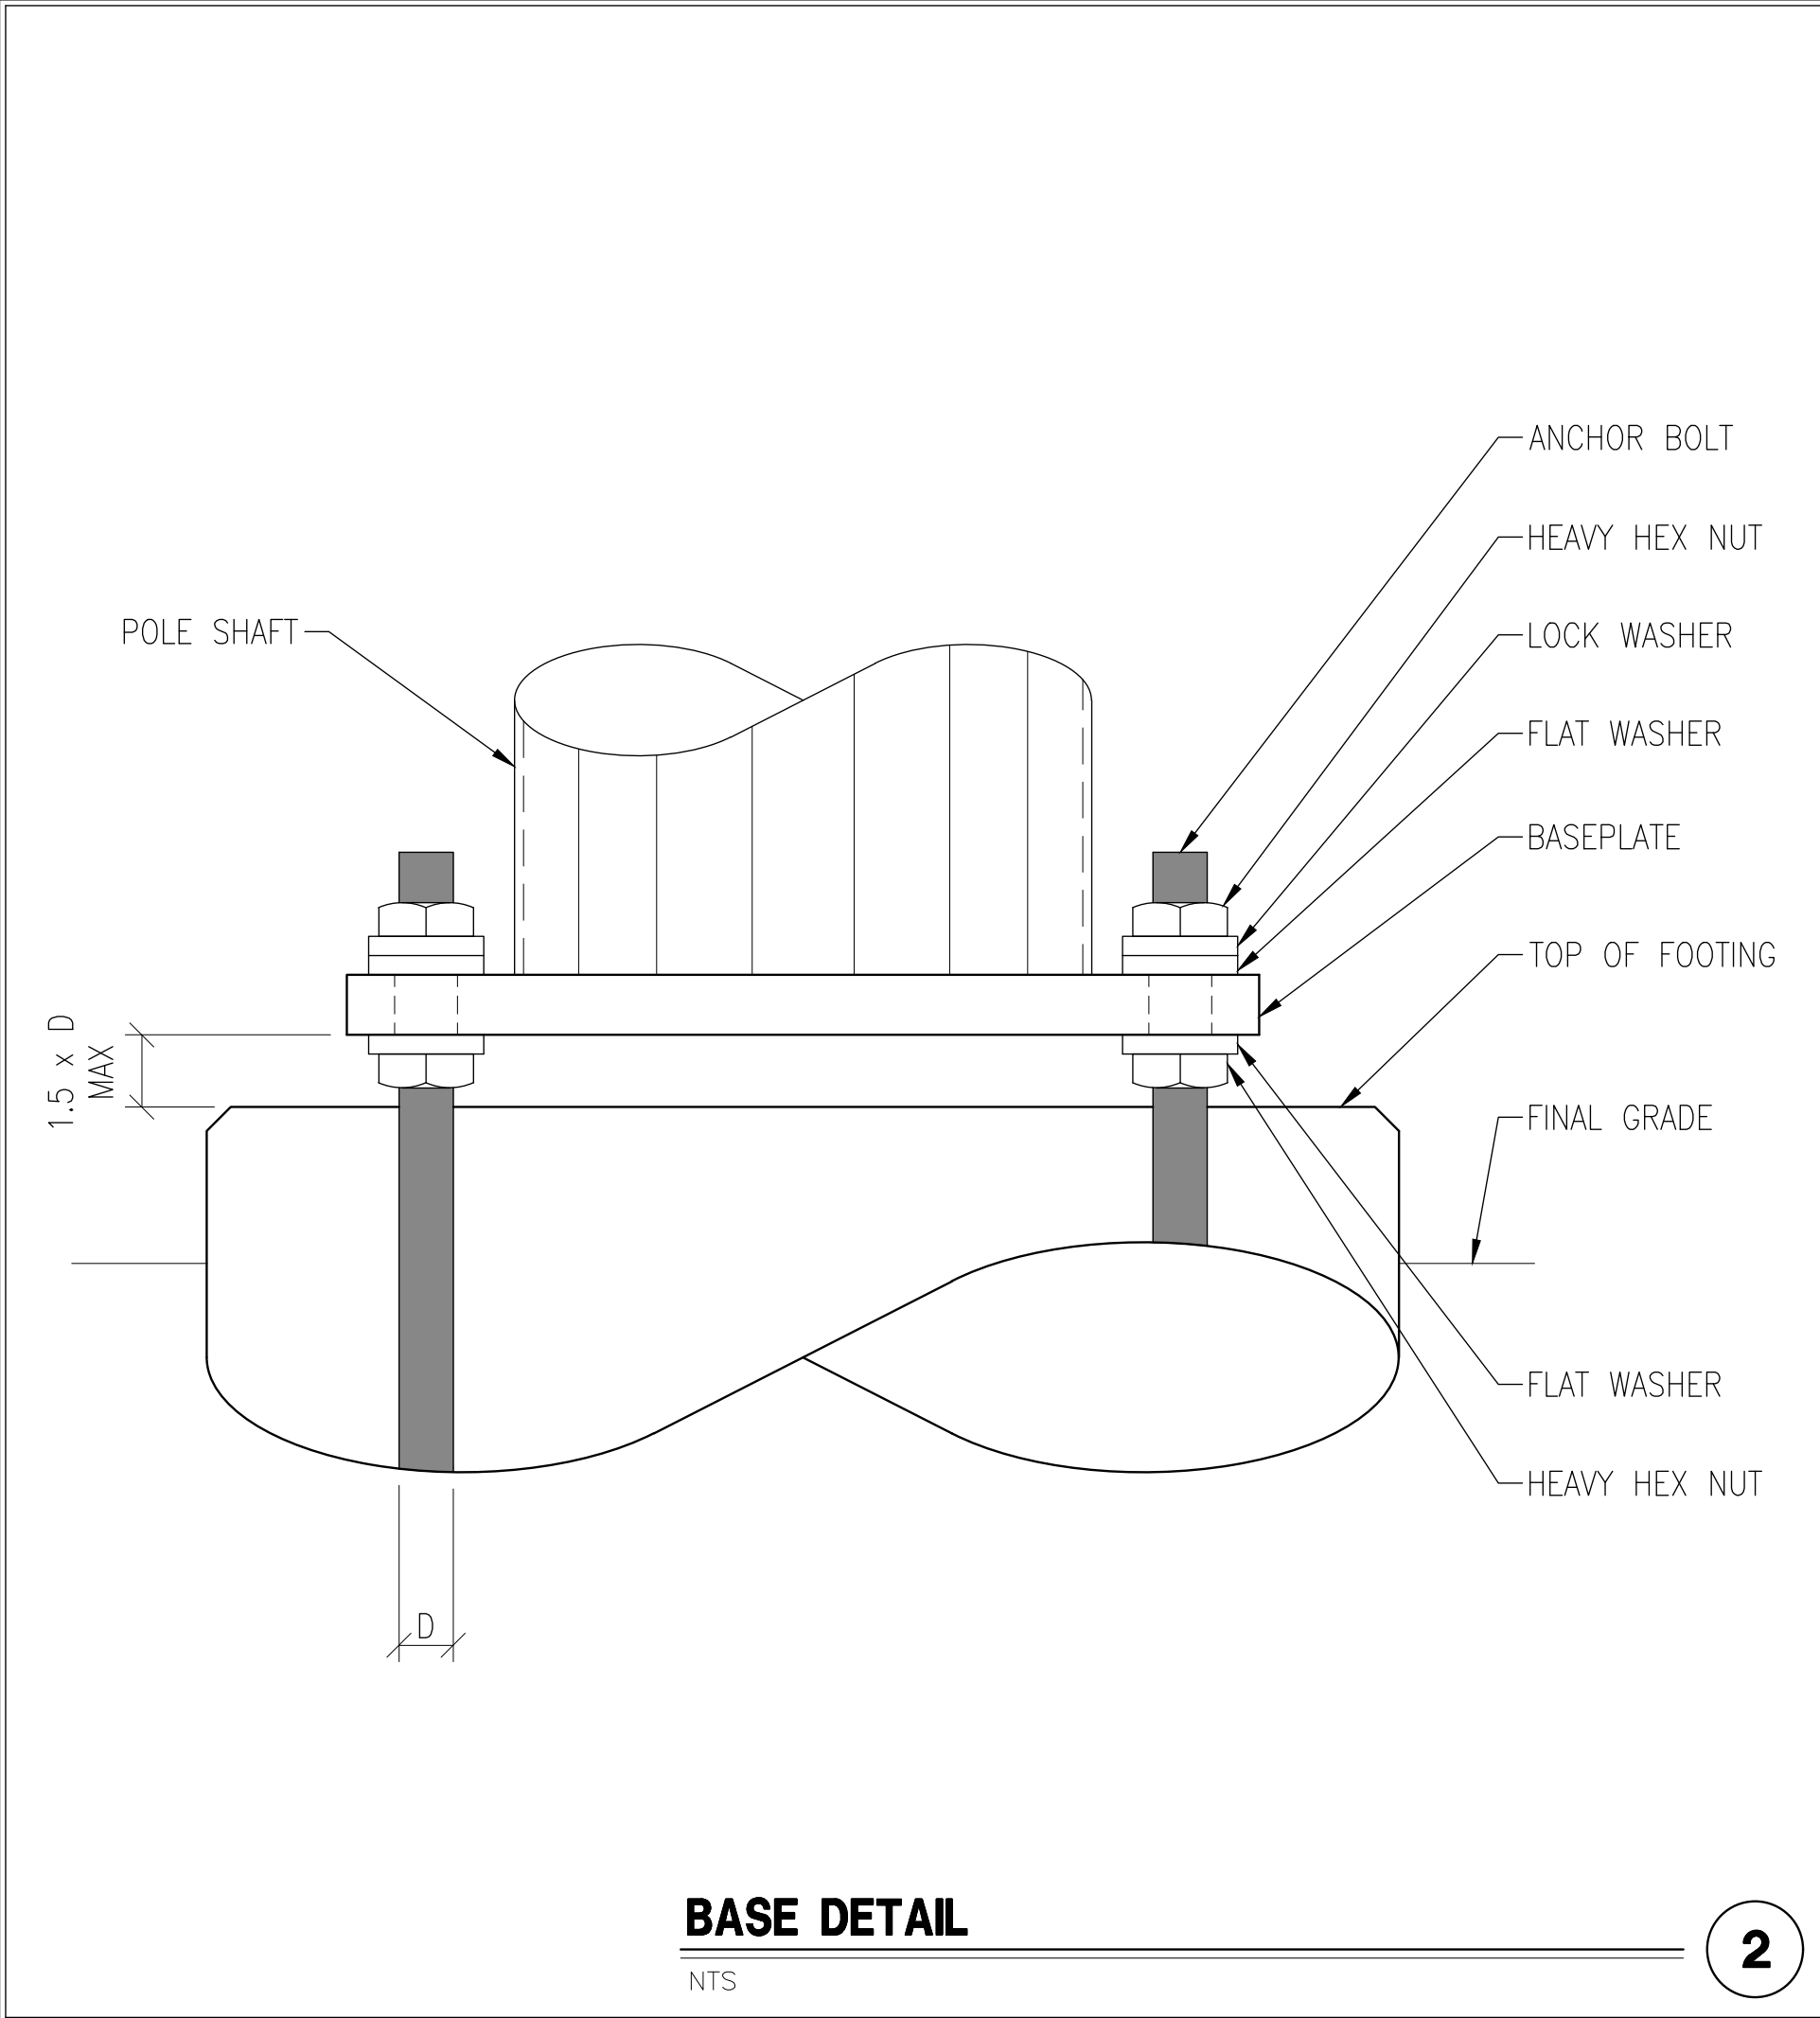
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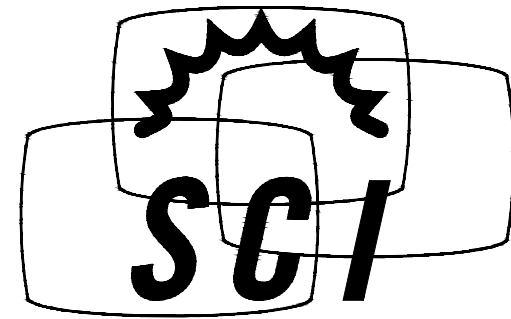
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GENERAL NOTES

1. CONTRACTOR IS RESPONSIBLE FOR CHECKING AREA FOR UNDERGROUND FACILITIES PRIOR TO EXCAVATING ANY MATERIALS.
2. CONTRACTOR SHALL REFER TO SOILS REPORT FOR SITE CONDITIONS AND FURTHER CONSTRUCTION INFORMATION.
3. CONTRACTOR SHALL INSPECT AND REMOVE ALL DEBRIS FROM BOTTOM OF EXCAVATION.
4. CONTRACTOR SHALL VERIFY ANCHOR BOLT LAYOUT PRIOR TO AND IMMEDIATELY AFTER PLACING CONCRETE. ANCHOR BOLT LAYOUT IS CRITICAL FOR MONOPOLE INSTALLATION.
5. CONTRACTOR SHALL USE AND PROVIDE DEFORMED REINFORCING BARS CONFORMING TO ASTM A615 GR 60 (60,000 PSI MIN YIELD). CONTRACTOR SHALL USE STEEL WIRE TO HOLD REINFORCING BARS TOGETHER. IF WELDING REBAR IS PREFERRED, SUBSTITUTE A706 GR 60 DEFORMED BARS.
6. ALL CONCRETE SHALL USE TYPE II PORTLAND CEMENT AND HAVE A MINIMUM COMPRESSIVE STRENGTH OF 4000 PSI AT 28 DAYS. CONCRETE SHALL HAVE A MINIMUM OF 6% ENTRAINED AIR (WHERE FROST DEPTH > 0'). CONCRETE SHALL HAVE A MAXIMUM WATER/CEMENT RATIO OF 0.50. CONCRETE SHALL HAVE A SLUMP OF 5" (±1") UNLESS OTHERWISE SPECIFIED IN THE GEOTECHNICAL REPORT. ALL CONCRETE WORK SHALL BE IN ACCORDANCE WITH "THE BUILDING CODE REQUIREMENTS FOR REINFORCED CONCRETE," ACI 318-19.
7. CONCRETE SHALL BE CONSOLIDATED USING VIBRATORY METHODS THROUGHOUT DEPTH OF FOUNDATION. VIBRATING LOWER DEPTHS MAY NOT BE ACCOMPLISHED BY TOUCHING REBAR CAGE WITH VIBRATOR.
8. CONTRACTOR SHOULD ANTICIPATE THE USE OF A FULL-LENGTH TEMPORARY CASING TO STABILIZE THE EXCAVATION. THE CASING SHALL BE WITHDRAWN DURING THE PLACEMENT OF CONCRETE IN THE EXCAVATED HOLE. CONCRETE SHALL NOT FREE FALL. CONCRETE MAY BE PLACED BELOW WATER USING TREMIE METHODS.
9. CONCRETE SHALL BE PLACED TO THE DEPTH INDICATED AND THE ABOVE GRADE PORTION SHALL BE FORMED. THE REBAR CAGE, ANCHOR BOLTS, AND CONCRETE SHALL BE PLACED WITHIN 24 HOURS OF COMPLETING THE EXCAVATION. COLD JOINTS ARE NOT ALLOWED, UNO
10. THE CONTRACTOR IS RESPONSIBLE FOR VERIFYING ADEQUATE CONCRETE COVERAGE OVER REINFORCING BARS. UNLESS OTHERWISE NOTED, CONTRACTOR SHALL USE 3" CONCRETE COVER OVER REBAR. TOP OF FOOTING SHALL BE TROWEL LEVEL AND SMOOTH.
11. DRILLED PIER FOUNDATION BASED ON THE SOILS REPORT PREPARED BY:

GEOBODEN INC.
PROJECT # : CLL05463-1-01
DATE: February 6, 2024



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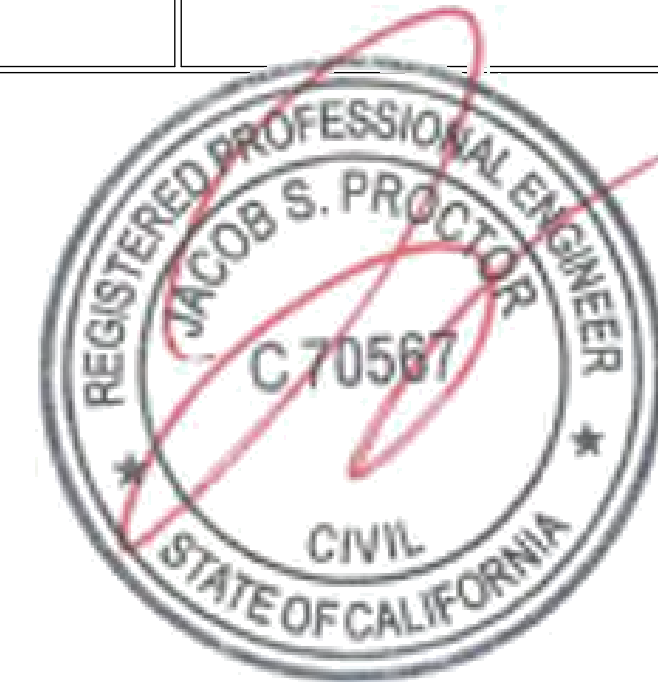
FOUNDATION

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