2022 CALIFORNIA BUILDING CODE

ANY LOCAL BUILDING CODE AMENDMENTS

CITY/COUNTY ORDINANCES 2022 CALIFORNIA ELECTRIC CODE ANSI / TIA-222 STRUCTURAL CODE 2022 CALIFORNIA MECHANICAL CODE NFPA 780 - LIGHTING PROTECTION CODE 2022 CALIFORNIA PLUMBING CODE

FACILITY IS UNMANNED AND NOT FOR HUMAN HABITATION, AND IS EXEMPTED FROM ACCESSIBILITY REQUIREMENTS IN ACCORDANCE WITH 2022 CALIFORNIA BUILDING CODE SECTION 11B-203.5.

DISTURBANCE OR EFFECT ON DRAINAGE. NO SANITARY SEWER SERVICE, POTABLE WATER, OR TRASH DISPOSAL IS REQUIRED AND NO COMMERCIAL SIGNAGE IS NEW

GENERAL NOTES

REQUIRED FOR ROUTINE MAINTENANCE. THE PROJECT WILL NOT RESULT IN IN ANY SIGNIFICANT DISTURBANCE OR EFFECT ON DRAINAGE. NO SANITARY SEWER SERVICE. POTABLE WATER. OR TRASH DISPOSAL IS REQUIRED AND NO COMMERCIAL SIGNAGE IS NEW.

OF JURISDICTIONAL PERMITTED PLANS IS DONE AT CONTRACTORS OWN RISK.

FOR "SPECIAL INSPECTIONS" SPECIFIC TO THIS PROJECT PURSUANT TO CBC SECTION 1704.3, SEE SHEET T-4, "STATEMENT OF SPECIAL INSPECTIONS"

SUBCONTRACTOR SHALL VERIFY ALL PLANS & EXISTING DIMENSIONS & CONDITIONS ON THE JOB SITE & SHALL IMMEDIATELY NOTIFY THE ENGINEER IN WRITING OF ANY DISCREPANCIES BEFORE PROCEEDING WITH THE WORK OR BE RESPONSIBLE FOR SAME.

FULL SIZE = 24"x36". ANY OTHER SIZE PRINT IS NOT ORIGINAL SCALE.

ALL INDICATED DIMENSIONS SHALL TAKE PRECEDENT OVER SCALED DIMENSIONS.



UNDERGROUND SERVICE ALERT UTILITY NOTIFICATION CENTER OF CALIFORNIA (800) 422-4133 WWW.CALIFORNIA811.ORG

CALL 2-14 WORKING DAYS UTILITY NOTIFICATION PRIOR TO CONSTRUCTION



N/A

117° 44' 08.43" W

-117.735675°

SITE INFORMATION

PROPERTY OWNER: GOOD SHEPERD EVANGELICAL LUTHERAN CHURCH OF CLAREMONT ADDRESS: ADDRESS: 1700 N. TOWNE AVENUE CLAREMONT, CA 91711

(909) 626-2714

TOWER CO SITE ID:

COUNTY: LOS ANGELES TOWER APP NUMBER:

ZONING JURISDICTION: CITY OF CLAREMONT LATITUDE (NAD 83): 34° 06' 52.80" N 34.114667° ZONING DISTRICT:

PARCEL NUMBER: 8303-010-043

OCCUPANCY GROUP:

CONSTRUCTION TYPE:

POWER COMPANY: SCE

TELEPHONE COMPANY:

LEASE AREA: 706 SQ. FT.

PROJECT TEAM

PROJECT MANAGER: 1452 EDINGER AVE, 3RD FLOOR **TUSTIN, CA 92780** CONTACT: TY LOGAN-BURKS PHONE: (925) 549-4671 EMAIL: tl784a@att.com

65 POST SUITE 1000 **IRVINE, CA 92618 CONTACT: JON SILVA** PHONE: (714) 393-7963

RF ENGINEER 1452 EDINGER AVE, 3RD FLOOR **TUSTIN, CA 92780** CONTACT: SANDEEP MANGAT PHONE: (530) 540-4201

EMAIL: sm2840@att.com

A&E CONTACT: SITE ACQUISITION: EUKON 65 POST SUITE 1000 **IRVINE, CA 92618** CONTACT: RICH BRUNET PHONE: (949) 553-8566

CONSTRUCTION: EUKON 1452 EDINGER AVE, 3RD FLOOR 65 POST SUITE 1000 **IRVINE, CA 92618 TUSTIN, CA 92780** CONTACT: DAVID TOVLIN CONTACT: SONAL THAKUR PHONE: (949) 565-6501 PHONE: (562) 243-5168 EMAIL: sonal.thakur@eukongroup.com EMAIL: dt2777@att.com

LONGITUDE (NAD 83):

SITE NUMBER: CLL05463

PACE#: MRLOS094296 FA#: 12844550 USID: 317138



PROJECT: NEW SITE BUILD (NSB) LTE-1C/2C/3C/4C/5C/6C/7C SITE TYPE: FAUX EUCALYPTUS SITE ADDRESS: 1700 N. TOWNE AVE. CLAREMONT, CA. 91711

VICINITY MAP AERIAL VIEW Sunrise of Claremont Newberry Ln Occidental Dr Fenn Ct Griffith Park Scripps Dr of Claremont Cascade PI age Electric Syracuse Dr

DRIVING DIRECTIONS

DIRECTIONS FROM AT&T OFFICE AT 1452 EDINGER AVE, TUSTIN, CA 92780

DEPART 1452 EDINGER AVE AND HEAD NORTH ON 8. SITE IS ON LEFT HAND SIDE

EDINGER AVE. TOWARDS I-5 SOUTH. TURN LEFT ONTO NEWPORT AVE.

TURN RIGHT AND MERGE ONTO CA-55 N TOWARD TAKE EXIT 107A FOR CA-57 N TOWARD POMONA

5. TAKE EXIT 25B FOR CA-210 E/FOOTHILL FWY TOWARD SAN BERNARDINO. TAKE EXIT 50 TOWARD TOWNE AVE.

7. USE RIGHT 2 LANES TO TURN RIGHT ONTO N TOWNE

PROJECT DESCRIPTION

AT&T WIRELESS PROPOSES TO INSTALL A WIRELESS COMMUNICATIONS FACILITY. THE SCOPE WILL CONSIST

• INSTALL 62'-0" TALL FAUX EUCALYPTUS

• INSTALL (20) PANEL ANTENNAS

• INSTALL (12) RRUS AT ANTENNAS • INSTALL (4) DC9 SURGE SUPPRESSORS

INSTALL (1) 4' WIDE STEEL ACCESS DOOR

• INSTALL (1) CAMLOCK

 INSTALL (1) POWER CABINET • INSTALL (2) STACKED PURCELL CABINETS

• INSTALL (1) DC50 SURGE SUPPRESSOR • INSTALL (1) TELCO BOX

INSTALL (1) CIENA

 INSTALL (1) JOINT TELCO / POWER UTILITY TRENCH • INSTALL (1) 200A METER PANEL

• INSTALL (1) 8'-0" HIGH CMU BLOCK WALL ENCLOSURE

 INSTALL (1) CONCRETE PAD • INSTALL (2) EUCALYPTUS TREES


• INSTALL (44) SHRUBS

DETAILS

FOUNDATION

SHEET INDEX

SHEETINDEA				
SHEET	DESCRIPTION	REV		
T-1	TITLE SHEET	В		
T-2	GENERAL NOTES, LEGEND, AND ABBREVIATIONS	В		
T-3	GENERAL SIGNAGE			
T-4	STATEMENT OF SPECIAL INSPECTIONS	В		
LS-1	TOPOGRAPHIC SURVEY	5		
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A-1	SITE PLAN	В		
A-1.1	ENLARGED SITE PLAN	В		
A-2	NEW COMPOUND / EQUIPMENT LAYOUT	В		
A-3	ANTENNA PLAN	В		
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A-4.1	4.1 NEW WEST AND SOUTH ELEVATIONS			
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A-6	EQUIPMENT DETAILS	В		
A-7	EQUIPMENT DETAILS	В		
A-8	CONSTRUCTION DETAILS	В		
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E-1	ELECTRICAL SITE PLAN	В		
E-2	SINGLE LINE DIAGRAM / PANEL SCHEDULE	В		
E-3	ELECTRICAL NOTES	В		
E-4	GROUNDING PLANS	В		
E-5	GROUNDING PLANS	В		
E-6	GROUNDING DETAILS	В		
FD-1	FIRE DEPT. NOTES AND BATTERY INFORMATION	В		
	LANDSCAPE			
L-1	LANDSCAPE PLAN	L-1		
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T1	TITLE SHEET	T1		
N1	NOTES AND SPECIFICATIONS	N1		
S1	ELEVATION VIEW	S1		
S2	DETAILS	S2		
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S4	DETAILS	S4		

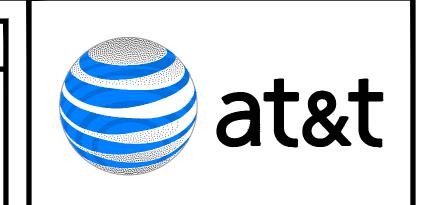

1452 EDINGER AVE. 3RD FLOOR **TUSTIN, CA 92780**



65 POST, SUITE 1000 **IRVINE**, CA 92618 TEL: (949) 553-8566

www.eukongroup.com



IT IS A VIOLATION OF LAW FOR ANY PERSON, UNLESS THEY ARE ACTING UNDER THE DIRECTION OF THE LICENSED PROFESSIONAL ENGINEER,

DRAWN BY:	UTILITIES CHECKED BY:	A&E CHECKED B
DW/AS	GD	RB

CONSTRUCTION **DRAWINGS**

SUBMITTALS				
REV	DATE	DESCRIPTION		
Α	04/26/24	90% CONSTRUCTION DRAWINGS		
В	08/29/24	JX COMMENTS		
0	03/12/24	100% CONSTRUCTION DRAWINGS		

PROJECT INFORMATION

CLL05463

1700 N. TOWNE AVE. CLAREMONT, CA 91711

SHEET TITLE

TITLE SHEET

SHEET NUMBER



SAFETY

SHEET

SCHEDULE

SITE ACQUISITION

SOFT DRAWN BARE COPPER SEC SECONDARY

SAQ

SCH.

SHT.

SDBC

STD.

STL.

STRUC.

SURF

SW

TEL.

THK.

TMA

T.N.

T.O.A.

T.O.C.

T.O.F.

T.O.P.

T.O.R.

T.O.S.

T.O.W.

TYP.

U.G.

U.L.

UMTS

U.N.O.

V.I.F.

WD

W/O

WD.

W.P.

WT.

XFER

XFMR

W/

TEMP.

STANDARD

STRUCTURAL

TELEPHONE

TEMPORARY

THICK(NESS)

TOP OF ANTENNA

TOP OF FOUNDATION

TOP OF PLATE OR PARAPET

UNDERWRITERS LABORATORY INC.

UNIVERSAL MOBIL TECH. SYS.

VOLT ALTERNATING CURRENT

UNLESS NOTED OTHERWISE

CROSS-LINK POLYETHYLENE

TOP OF CURB

TOP OF ROOF

TOP OF STEEL

TOP OF WALL

UNDER GROUND

VERIFY IN FIELD

WATT OR WIRE

WEATHERPROOF

WIDE(WIDTH)

TYPICAL

VOLT

WITH

WITHOUT

WOOD

WEIGHT

TRANSFER

TRANSFORMER

TOE NAIL

TOWER MOUNTED AMPLIFIER (DC SUPPLY VOLTAGE)

SURFACE

SWITCH

STEEL

A&E	ARCHITECTURE AND ENGINEERING	EA.	EACH	LPS	LOW PRESSURE SODIUM
A.B.	ANCHOR BOLT	EGR.	EMERGENCY GENERATOR RECEPTACLE	LTE	LONG TERM EVOLUTION
ABV.	ABOVE	EL.	ELEVATION	MAS.	MASONRY
AC	ALTERNATE CURRENT/AIR CONDITIONER	ELEC.	ELECTRICAL	MAX.	MAXIMUM
ACCA	ANTENNA CABLE COVER ASSEMBLY	ELEV.	ELEVATOR	M.B.	MACHINE BOLT
ADD'L	ADDITIONAL	EMT.	ELECTRICAL METALLIC TUBING	MECH.	MECHANICAL
A.F.F.	ABOVE FINISHED FLOOR	E.N.	EDGE NAIL	MFR.	MANUFACTURER
A.F.G.	ABOVE FINISHED GRADE	ENCL.	ENCLOSURE	MIN.	MINIMUM
AIC	AMPERE INTERRUPTING CAPACITY	ENG.	ENGINEER	MISC.	MISCELLANEOUS
ALUM.	ALUMINUM	EQ.	EQUAL	MLO	MAIN LUGS ONLY
ALT.	ALTERNATE	ESR	EVALUATION SERVICE REPORT	MTD.	MOUNTED
ANT.	ANTENNA	EXP.	EXPANSION	MTG.	MOUNTING
APPR0X.	APPROXIMATE(LY)	EXT.	EXTERIOR	MTL.	METAL
ARCH.	ARCHITECT(URAL)	FAB.	FABRICATION(OR)	MTS.	MANUAL TRANSFER SWITCH
AT.	AMPERE TRÌP	FAC.	FACTOR	N	NEUTRAL
AWG.	AMERICAN WIRE GAUGE	F/A	FIRE ALARM	(N)	NEW
BATT.	BATTERY	F.F.	FINISH FLOOR	ΝÉΜΑ	NATIONAL ELECTRICAL MANUFACTURERS ASSOC.
BD.	BOARD	F.G.	FINISH GRADE	NO.(#)	NUMBER
BLDG.	BUILDING	F.J.	FLOOR JOIST	N.T.S.	NOT TO SCALE
BLK.	BLOCK	FIN.	FINISH(ED)	OBIF	OPTICAL BASEBAND INTERFACE
BLKG.	BLOCKING	FLR.	FLOOR	OH	OVERHEAD
BM.	BEAM	FLUOR	FLUORESCENT	O.C.	ON CENTER
B.N.	BOUNDARY NAILING	FDN.	FOUNDATION	OPNG.	OPENING
BR.	BRANCH	F.O.C.	FACE OF CONCRETE	(P)	PROPOSED
BRKR.	BREAKER	F.O.M.	FACE OF MASONRY	(· / P	POLE
BTCW.	BARE TINNED COPPER WIRE	F.O.S.	FACE OF STUD	P/C	PRECAST CONCRETE
BTS.	BASE TRANSMISSION SYSTEM	F.O.W.	FACE OF WALL	PCS	PERSONAL COMMUNICATION SERVICES
B.O.F.	BOTTOM OF FOOTING	F.O.W. FRP	FIBER REINFORCE POLYMER	PH	PHASE
B/U	BACK-UP CABINET	F.S.	FINISH SURFACE	PLY.	PLYWOOD
C	CONDUIT			PNLBD	PANELBOARD
CAB.	CABINET	FT.(') FTG.	FOOT (FEET) FOOTING	PPC	POWER PROTECTION CABINET
CAB. CANT.	CANTILEVER(ED)			PRC	PRIMARY RADIO CABINET
	CIRCUIT BREAKER	FU	FUSE		
CB.		G	GROUND ORDINATU (OARINET)	L.	PROPERTY OR PROPERTY LINE
CDMA	CODE-DIVISION MULTIPLE ACCESS	GR	GROWTH (CABINET)	PRI	PRIMARY
CDUK	CONSOLIDATION DISTRIBUTION UNIT KIT	GA.	GAUGE	P.S.F.	POUNDS PER SQUARE FOOT
C.I.P.	CAST IN PLACE	GALV.	GALVANIZE(D)	P.S.I.	POUNDS PER SQUARE INCH
CKT.	CIRCUIT	GEN.	GENERATOR	P.T.	PRESSURE TREATED DOUGLAG FUR
Q OLO	CENTERLINE	G.F.C.I.	GROUND FAULT CIRCUIT INTERRUPTER	P.T.D.F.	PRESSURE TREATED DOUGLAS FUR
CLG.	CEILING	GLB.	(GLU-LAM) GLUE LAMINATED BEAM	PWR.	POWER
CLR.	CLEAR	GND	GROUND	QTY.	QUANTITY
CMU	CONCRETE MASONRY UNIT	GPS	GLOBAL POSITIONING SYSTEM	RAD.	RADIATION
COL.	COLUMN	GRND.	GROUND	R	RADIUS
CONC.	CONCRETE	GSM	GLOBAL SYSTEM MOBILE	RBS	RADIO BASE STATION
CONN.	CONNECTION(OR)	HDBC	HARD DRAWN COPPER WIRE	RCPT.	RECEPTACLE
CONST.	CONSTRUCTION	HDR.	HEADER	REF.	REFERENCE
CONT.	CONTINUOUS	HGR.	HANGER	REINF.	REINFORCEMENT(ING)
d	PENNY (NAILS)	HPS	HIGH PRESSURE SODIUM	REQ'D.	REQUIRED
DBL.	DOUBLE	HT.	HEIGHT	RF	RADIO FREQUENCY
DC	DIRECT CURRENT	ICC	INTERNATIONAL CODE COUNCIL	RGS.	RIGID GALVANIZED STEEL
DEM.	DEMAND	ICGB.	ISOLATED COPPER GROUND BUS	R.J.	ROOF JOIST
DEPT.	DEPARTMENT	ILC	INTEGRATED LEAD CENTER	R.R.	ROOF RAFTER
D.F.	DOUGLAS FIR	IN.(")	INCH(ES)	RRU	REMOTE RADIO UNIT (RADIO TRANSCEIVER)
DIA.	DIAMETER	INT.	INTERIOR	RX-AIT	RECEIVER AIR INTERFACE TRAY

LONG(ITUDINAL)

LINEAR FEET (FOOT)

POUND(S)

LAG BOLTS

LB.(#)

L.B.

LOS ANGELES RESEARCH REPORT

- - PLANS ARE NOT TO BE SCALED AND ARE INTENDED TO BE A DIAGRAMMATIC OUTLINE ONLY, UNLESS NOTED OTHERWISE. THE WORK SHALL INCLUDE FURNISHING MATERIALS, EQUIPMENT, APPURTENANCES AND LABOR NECESSARY TO COMPLETE ALL INSTALLATIONS AS INDICATED ON THE DRAWINGS.

THE FACILITY IS AN UNOCCUPIED DIGITAL TELECOMMUNICATION FACILITY.

- PRIOR TO THE SUBMISSION OF BIDS, THE CONTRACTORS SHALL VISIT THE JOB SITE AND BE RESPONSIBLE FOR ALL CONTRACT DOCUMENTS, FIELD CONDITIONS AND DIMENSIONS, AND CONFIRMING THAT THE WORK MAY BE ACCOMPLISHED AS SHOWN PRIOR TO PROCEEDING WITH CONSTRUCTION. ANY DISCREPANCIES ARE TO BE BROUGHT TO THE ATTENTION OF THE IMPLEMENTATION ENGINEER AND ENGINEER PRIOR TO PROCEEDING WITH THE WORK.
- 4. THE CONTRACTOR SHALL OBTAIN, IN WRITING, AUTHORIZATION TO PROCEED BEFORE STARTING WORK ON ANY ITEM NOT CLEARLY DEFINED OR IDENTIFIED BY THE CONTRACT DOCUMENTS.
- THE CONTRACTOR SHALL INSTALL ALL EQUIPMENT AND MATERIALS IN ACCORDANCE WITH MANUFACTURER'S RECOMMENDATIONS UNLESS SPECIFICALLY INDICATED OTHERWISE OR WHERE LOCAL CODES OR REGULATIONS TAKE PRECEDENCE.
- ALL WORK PERFORMED AND MATERIALS INSTALLED SHALL BE IN STRICT ACCORDANCE WITH ALL APPLICABLE CODES, REGULATIONS AND ORDINANCES. CONTRACTOR SHALL GIVE ALL NOTICES AND COMPLY WITH ALL LAWS, ORDINANCES, RULES, REGULATIONS AND LAWFUL ORDERS OF ANY PUBLIC AUTHORITY REGARDING THE PERFORMANCE OF THE WORK. MECHANICAL AND ELECTRICAL SYSTEMS SHALL BE INSTALLED IN ACCORDANCE WITH ALL APPLICABLE MUNICIPAL AND UTILITY COMPANY SPECIFICATIONS, AND LOCAL AND STATE JURISDICTIONAL CODES, ORDINANCES AND APPLICABLE REGULATIONS.
- THE GENERAL CONTRACTOR SHALL SUPERVISE AND DIRECT THE WORK, USING THE BEST SKILLS AND ATTENTION. THE CONTRACTOR SHALL BE SOLELY RESPONSIBLE FOR ALL CONSTRUCTION MEANS, METHODS, TECHNIQUES, SEQUENCES AND PROCEDURES AND FOR COORDINATING ALL PORTIONS OF THE WORK UNDER THE CONTRACT INCLUDING CONTACT AND COORDINATION WITH THE IMPLEMENTATION ENGINEER AND WITH THE LANDLORD'S AUTHORIZED REPRESENTATIVE.
- 8. SEAL PENETRATIONS THROUGH FIRE RATED AREAS WITH U.L. LISTED AND FIRE CODE APPROVED MATERIALS.
- PROVIDE A PORTABLE FIRE EXTINGUISHER WITH A RATING OF NOT LESS THAN 2-A OR 2-A10BC WITHIN 75 FEET TRAVEL DISTANCE TO ALL PORTIONS OF THE PROJECT AREA DURING CONSTRUCTION.
- 10. DETAILS ARE INTENDED TO SHOW END RESULT OF DESIGN. MINOR MODIFICATIONS MAY BE REQUIRED TO SUIT JOB DIMENSIONS OR CONDITIONS, AND SUCH MODIFICATIONS SHALL BE INCLUDED AS PART OF THE
- 11. REPRESENTATIONS OF TRUE NORTH, OTHER THAN THOSE FOUND ON THE PLOT OF SURVEY DRAWING (SHEET LS1 OR SHEET C-1), SHALL NOT BE USED TO IDENTIFY OR ESTABLISH THE BEARING OF TRUE NORTH AT THE SITE. THE CONTRACTOR SHALL RELY SOLELY ON THE PLOT OF SURVEY DRAWING AND ANY SURVEYOR'S MARKINGS AT THE SITE FOR THE ESTABLISHMENT OF TRUE NORTH, AND SHALL NOTIFY THE ENGINEER PRIOR TO PROCEEDING WITH THE WORK IF ANY DISCREPANCY IS FOUND BETWEEN THE VARIOUS ELEMENTS OF THE WORKING DRAWINGS AND THE TRUE NORTH ORIENTATION AS DEPICTED ON THE CIVIL SURVEY. THE CONTRACTOR SHALL ASSUME SOLE LIABILITY FOR ANY FAILURE TO NOTIFY THE ENGINEER.
- 12. THE CONTRACTOR SHALL MAKE NECESSARY PROVISIONS TO PROTECT EXISTING IMPROVEMENTS, PAVING, CURBS, VEGETATION, GALVANIZED SURFACES, ETC., AND UPON COMPLETION OF WORK REPAIR ANY DAMAGE THAT OCCURRED DURING CONSTRUCTION TO THE SATISFACTION OF AT&T.
- 13. KEEP GENERAL AREA CLEAN, HAZARD FREE, AND DISPOSE OF ALL DIRT, DEBRIS, RUBBISH AND REMOVE EQUIPMENT NOT SPECIFIED AS REMAINING ON THE PROPERTY. LEAVE PREMISES IN CLEAN CONDITION AND FREE FROM PAINT SPOTS, DUST OR SMUDGES OF ANY NATURE.
- 14. PENETRATIONS OF ROOF MEMBRANES SHALL BE PATCHED/FLASHED AND MADE WATERTIGHT USING LIKE MATERIALS IN ACCORDANCE WITH NRCA ROOFING STANDARDS AND DETAILS. CONTRACTOR SHALL OBTAIN DETAILING CLARIFICATION FOR SITE-SPECIFIC CONDITIONS FROM ENGINEER, IF NECESSARY, BEFORE PROCEEDING.
- 5. BEFORE ORDERING AND/OR BEFORE FABRICATING/CONSTRUCTING/INSTALLING ANY ITEMS. VERIFY THE TYPES AND QUANTITIES.
- 16. CONTRACTOR SHALL PROVIDE SITE FOREMAN WITH A CELLULAR PHONE AND PAGER, AND KEEP SAME ON SITE WHENEVER PERSONNEL ARE ON SITE.
- 17. THE CONTRACTOR SHALL VERIFY ALL DIMENSIONS AND CONDITIONS ON THE SITE AND NOTIFY THE PROJECT
- MANAGER OF ANY DISCREPANCIES BEFORE STARTING ANY WORK 18. CONTRACTOR TO PROVIDE COMPLETE SET OF AS BUILT DRAWINGS WITHIN 10 WORKING DAYS OF PROJECT
- 19. CONTRACTOR IS TO EXCAVATE 6" BELOW EXISTING GRADE AND SPRAY WITH WEED CONTROL. REPLACE WITH CLASS II AGGREGATE BASE AND CRUSHED WASHED ROCK. AS SPECIFIED ON SITE PLAN.
- 20. CONTRACTOR SHALL PROVIDE TOILET FACILITY DURING ALL PHASES OF CONSTRUCTION.
- 21. PRIOR TO THE COMMENCEMENT OF CONSTRUCTION OR THE FABRICATION OF MATERIALS TO BE INSTALLED AT THE SITE, THE CONTRACTOR SHALL FIELD VERIFY ALL DIMENSIONS INCLUDING AS-BUILT DIMENSIONS OF EXISTING STRUCTURES OR STRUCTURAL ELEMENTS HAVING A BEARING ON THE SCOPE OF THE WORK TO BE PERFORMED. IF ANY DISCREPANCY IS FOUND BETWEEN THE VARIOUS ELEMENTS OF THE WORKING DRAWINGS AND THE DIMENSIONS OR CONDITIONS FOUND TO BE EXISTING IN THE FIELD, THE CONTRACTOR SHALL NOTIFY THE ENGINEER AND OBTAIN DESIGN RESOLUTION PRIOR TO PROCEEDING WITH THE PORTION(S) OF THE WORK AFFECTED. THE CONTRACTOR SHALL ASSUME SOLE LIABILITY FOR ANY FAILURE TO SO NOTIFY THE ENGINEER AND OBTAIN RESOLUTION BEFORE PROCEEDING.

NOTES FOR EXISTING AT&T CELL SITES:

- PRIOR TO THE SUBMISSION OF BIDS, THE BIDDING SUBCONTRACTOR SHALL VISIT THE CELL SITE TO FAMILIARIZE WITH THE EXISTING CONDITIONS AND TO CONFIRM THAT THE WORK CAN BE ACCOMPLISHED AS SHOWN ON THE CONSTRUCTION DRAWINGS. ANY DISCREPANCY FOUND SHALL BE BROUGHT TO THE ATTENTION OF CONTRACTOR.
- SUBCONTRACTOR SHALL VERIFY ALL EXISTING DIMENSIONS AND CONDITIONS PRIOR TO COMMENCING ANY WORK. ALL DIMENSIONS OF EXISTING CONSTRUCTION SHOWN ON THE DRAWINGS MUST BE VERIFIED. SUBCONTRACTOR SHALL NOTIFY THE CONTRACTOR OF ANY DISCREPANCIES PRIOR TO ORDERING MATERIAL OR PROCEEDING WITH CONSTRUCTION.
- THE EXISTING CELL SITE IS IN FULL COMMERCIAL OPERATION. ANY CONSTRUCTION WORK BY SUBCONTRACTOR SHALL NOT DISRUPT THE EXISTING NORMAL OPERATION. ANY WORK ON EXISTING EQUIPMENT MUST BE COORDINATED WITH CONTRACTOR. ALSO, WORK SHOULD BE SCHEDULED FOR AN APPROPRIATE MAINTENANCE WINDOW USUALLY IN LOW TRAFFIC PERIODS AFTER MIDNIGHT.
- SINCE THE CELL SITE IS ACTIVE, ALL SAFETY PRECAUTIONS MUST BE TAKEN WHEN WORKING AROUND HIGH LEVELS OF ELECTROMAGNETIC RADIATION. EQUIPMENT SHOULD BE SHUTDOWN PRIOR TO PERFORMING ANY WORK THAT COULD EXPOSE THE WORKERS TO DANGER. PERSONAL RF EXPOSURE MONITORS ARE ADVISED TO BE WORN TO ALERT OF ANY DANGEROUS EXPOSURE LEVELS.
- SUBCONTRACTOR SHALL DETERMINE ACTUAL ROUTING OF CONDUIT, POWER AND T1 CABLES, GROUNDING CABLES AS SHOWN ON THE POWER, GROUNDING AND TELCO PLAN DRAWING. SUBCONTRACTOR SHALL UTILIZE EXISTING TRAYS AND/OR SHALL ADD NEW TRAYS AS NECESSARY. SUBCONTRACTOR SHALL CONFIRM THE ACTUAL ROUTING WITH THE CONTRACTOR.
- SUBCONTRACTOR SHALL LEGALLY AND PROPERLY DISPOSE OF ALL SCRAP MATERIALS SUCH AS COAXIAL CABLES AND OTHER ITEMS REMOVED FROM THE EXISTING FACILITY. ANTENNAS REMOVED SHALL BE RETURNED TO THE OWNER'S DESIGNATED LOCATION.




1452 EDINGER AVE. 3RD FLOOR **TUSTIN, CA 92780**



65 POST, SUITE 1000 IRVINE, CA 92618 TEL: (949) 553-8566

www.eukongroup.com

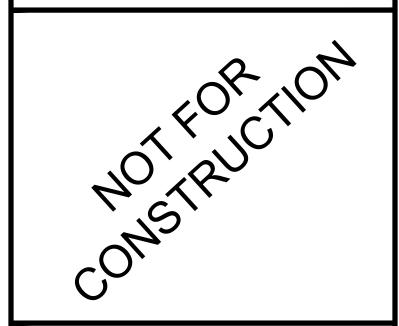

IT IS A VIOLATION OF LAW FOR ANY PERSON. UNLESS THEY ARE ACTING UNDER THE DIRECTION OF THE LICENSED PROFESSIONAL ENGINEER, TO ALTER THIS DOCUMENT.

DRAWN BY:	UTILITIES CHECKED BY:	A&E CHECKED BY:
DW/AS	GD	RB

CONSTRUCTION **DRAWINGS**

	SUBMITTALS				
REV	DATE	DESCRIPTION			
А	04/26/24	90% CONSTRUCTION DRAWINGS			
В	08/29/24	JX COMMENTS			
0	03/12/24	100% CONSTRUCTION DRAWINGS			

PROJECT INFORMATION

CLL05463

1700 N. TOWNE AVE. CLAREMONT, CA 91711

SHEET TITLE GENERAL NOTES, LEGEND, AND **ABBREVIATIONS**

SHEET NUMBER

DIM.

DO

DWG.

DWL.

DIAGONAL

DIMENSION

DRAWING(S)

DOWEL(S)

DITO (THE SAME)



Beyond This Point you are entering a controlled area where RF emissions may exceed the FCC General Population Exposure Limits.

Follow all posted signs and site guidelines for working in a RF environment.

Ref: 47CFR 1.1307(b)



Occupational Exposure Limits.

Obey all posted signs and site guidelines

Ref: 47CFR 1.1307(b)

for working in a RF enviroment.

BATTERY NO SCALE

S


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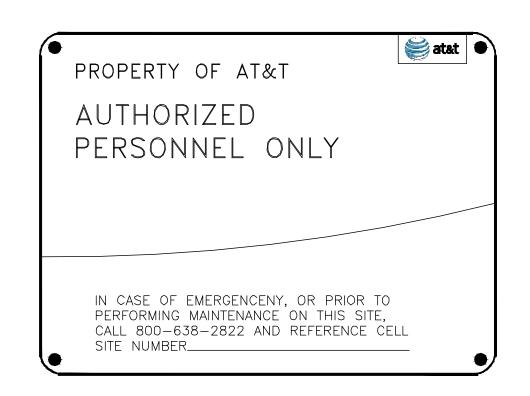
B

A

CAUTION SIGNS
NO SCALE

atet •



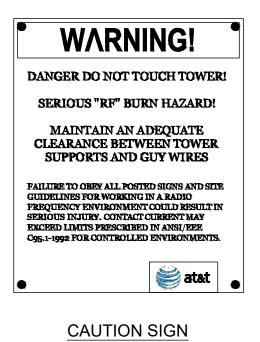

INFO SIGN #5



INFORMATION

AT&T operates telecommunications antennas at this location. Remain at least 3 feet away from any antenna and obey all posted signs.

Contact the owner(s) of the antenna(s) before working closer than 3 feet from the antenna.

maintenance or repairs near AT&T antennes. This is
Site#______

Contact the management office if this door/hatch/este is form


INFORMACION

at&t

INFO SIGN #1




INFO SIGN #3
NO SCALE

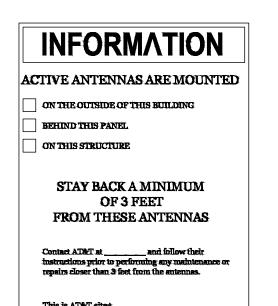

INFO SIGN #2

at&t

INFO SIGN #4

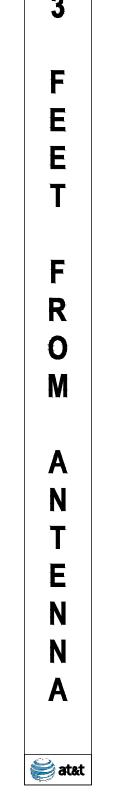

GENERAL SIGNAGE GUIDELINES								
STRUCTURE TYPE	INFO SIGN #1	INFO SIGN #2	INFO SIGN #3	INFO SIGN #4	INFO SIGN #5	STRIPING	NOTICE SIGN	CAUTION SIGN
TOWERS								
MONOPOLE / MONOPINE / MONOPALM / FAUX EUCALYPTUS / BROADLEAF	ENTRANCE GATES, SHELTER DOORS OR ON THE OUTDOOR CABINETS	ON THE POLE, NO LESS THAN 3FT BELOW THE ANTENNA AND NO	ON BACKSIDE OF ANTENNAS	ON THE SIDE OF ANTENNAS	ON THE SHELTER DOOR OR ON ONE OUTDOOR EQUIPMENT CABINET			AT THE HEIGHT OF THE FIRST CLIMBING STEP, MIN. 9FT ABOVE GROUND
SCE TOWERS / TOWERS WITH HIGH VOLTAGE	ENTRANCE GATES, SHELTER DOORS OR ON THE OUTDOOR CABINETS	ON THE POLE, NO LESS THAN 3FT BELOW THE ANTENNA AND NO	ON BACKSIDE OF ANTENNAS	ON THE SIDE OF ANTENNAS	ON THE SHELTER DOOR OR ON ONE OUTDOOR EQUIPMENT CABINET			AT THE HEIGHT OF THE FIRST CLIMBING STEP, MIN. 9FT ABOVE GROUND
LIGHT POLES / FLAG POLES	ENTRANCE GATES, SHELTER DOORS OR ON THE OUTDOOR CABINETS	ON THE POLE, NO LESS THAN 3FT BELOW THE ANTENNA AND NO	ON BACKSIDE OF ANTENNAS	ON THE SIDE OF ANTENNAS	ON THE SHELTER DOOR OR ON ONE OUTDOOR EQUIPMENT CABINET			
UTILITY WOOD POLES (JPA)	ENTRANCE GATES, SHELTER DOORS OR ON THE OUTDOOR CABINETS	ON THE POLE, NO LESS THAN 3FT BELOW THE ANTENNA AND NO	ON BACKSIDE OF ANTENNAS	ON THE SIDE OF ANTENNAS	ON THE SHELTER DOOR OR ON ONE OUTDOOR EQUIPMENT CABINET		ANTENNA LEVEL SIGN; OVER 99%: NO LESS THAT 3F1	CAUTION SIGN AT
MICROCELLS MOUNTED ON NON-JPA POLES	ENTRANCE GATES, SHELTER DOORS OR ON THE OUTDOOR CABINETS	ON THE POLE, NO LESS THAN 3FT BELOW THE ANTENNA AND NO	ON BACKSIDE OF ANTENNAS	ON THE SIDE OF ANTENNAS	ON THE SHELTER DOOR OR ON ONE OUTDOOR EQUIPMENT CABINET		THAN 9FT ABOVE THE EXPOSURE EX	N SIGN AT NO LESS GROUND: ONLY IF CEEDS 90% OF THE EXPOSURE AT 6FT GROUND
ROOFTOPS								
AT ALL ACCESS POINTS TO THE ROOF	X							
ON ANTENNAS	X		X	X				
CONCEALED ANTENNAS	X	X						
ANTENNAS MOUNTED FACING OUTSIDE THE BUILDING	Х	X						
ANTENNAS ON SUPPORT STRUCTURE	X	Χ						
ROOF VIEW GRAPH:								
RADIATION AREA IS WITHIN 3FT FROM ANTENNA	Х	ADJACENT TO EACH ANTENNA						
RADIATION AREA IS BEYOND 3FT FROM ANTENNA	Х	ADJACENT TO EACH ANTENNA				DIAGONAL, YELLOW STRIPING AS TO ROOF VIEW GRAPH	(BASED ON ROOF)	OR CAUTION SIGN /IEW RESULTS) AT S/BARRIER
CHURCH STEEPLES	ACCESS TO STEEPLE	ADJACENT TO ANTENNAS IF ANTENNAS ARE CONCEALED	ON BACKSIDE OF ANTENNAS	ON THE SIDE OF ANTENNAS	ON THE SHELTER DOOR OR ON ONE OUTDOOR EQUIPMENT CABINET		- -	Caution sign at the antennas
WATER TOWERS	ACCESS TO LADDER	ADJACENT TO ANTENNAS IF ANTENNAS ARE CONCEALED	ON BACKSIDE OF ANTENNAS	ON THE SIDE OF ANTENNAS	ON THE SHELTER DOOR OR ON ONE OUTDOOR EQUIPMENT CABINET			Caution sign beside info sign #1, min. 9ft above ground
		CONCEALED						above ground

NOTES FOR ROOFTOP SITES:

- 1. EITHER NOTICE OR CAUTION SIGNS NEED TO BE POSTED AT EACH SECTOR AS CLOSE AS POSSIBLE TO: THE OUTER EDGE OF THE STRIPED OFF AREA OF THE OUTER ANTENNAS OF THE SECTOR.

 2. IF ROOFVIEW SHOWS: ONLY BLUE = NOTICE SIGN, BLUE AND YELLOW = CAUTION SIGN, ONLY YELLOW = CAUTION SIGN TO BE INSTALLED.
- 3. SHOULD THE REQUIRED STRIPING AREA INTERFERE WITH ANY STRUCTURES OR EQUIPMENT (A/C, VENTS, ROOF HATCH, DOORS, OTHER ANTENNAS, DISHES, ETC.).
- PLEASE NOTIFY AT&T TO MODIFY THE STRIPING AREA, PRIOR TO STARTING THE WORK.

SIGNAGE GUIDELINES CHART



1452 EDINGER AVE. 3RD FLOOR TUSTIN, CA 92780



65 POST, SUITE 1000 IRVINE, CA 92618 TEL: (949) 553-8566

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WOLKS LOW

IT IS A VIOLATION OF LAW FOR ANY PERSON, UNLESS THEY ARE ACTING UNDER THE DIRECTION OF THE LICENSED PROFESSIONAL ENGINEER, TO ALTER THIS DOCUMENT.

DRAWN BY:	UTILITIES CHECKED BY:	A&E CHECKED BY
DW/AS	GD	RB

CONSTRUCTION DRAWINGS

	SUBMITTALS			
REV	DATE	DESCRIPTION		
Α	04/26/24	90% CONSTRUCTION DRAWINGS		
В	08/29/24	JX COMMENTS		
0	03/12/24	100% CONSTRUCTION DRAWINGS		

PROJECT INFORMATION

CLL05463

1700 N. TOWNE AVE. CLAREMONT, CA 91711

SHEET TITLE

GENERAL SIGNAGE

SHEET NUMBER

T-3

	STATEMENT OF SPECIAL INSPECTIONS		
NO.	DESCRIPTION OF TYPE OF INSPECTION REQUIRED, LOCATION, REMARKS.	DESIGN STRENGTH	FREQUENCY
1	ANCHORS:		
	ADHESIVE AND EXPANSION ANCHORS IN CONCRETE OR MASONRY, HILTI KWIK BOLT TZ2 EXPANSION ANCHOR, PER ICC REPORT ESR-4266.		PERIODIC
	ADHESIVE AND EXPANSION ANCHORS IN CONCRETE OR MASONRY. INSPECTOR SHALL VERIFY ANCHOR TYPE, ANCHOR DIMENSIONS,		
	CONCRETE TYPE, THICKNESS AND COMPRESSIVE STRENGTH, HOLED DIMENSTIONS, HOLE CLEANING PROCEDURES, ANCHOR SPACING,		
	EDGE DISTANCES, ANCHOR EMBEDMENT, AND TIGHTENING TORQUE.		
2	CONCRETE:		
Α	CONTINUOUS INSPECTION AND TEST CYLINDERS FOR STRUCTURAL CONCRETE EXCEPT FOUNDATION CONCRETE OF 2500 PSI OR LESS		CONTINUOUS
	AND SPECIFIED EXCEPTIONS PER SECTION 1705.3 (TABLE 1705.3).		
В	CONTINUOUS SPECIAL INSPECTION OF DRILLING OPERATION FOR PIER FOUNDATIONS.		
С	CONTINUOUS SPECIAL INSPECTION TO VERIFY LOCATION, PLUMBNESS, DIAMETER, AND LENGTH OF PIER FOUNDATIONS.		
D	CONTINUOUS SPECIAL INSPECTION OF ANCHOR BOLTS PRIOR TO AND DURING CONCRETE PLACEMENT.		
Е	CONTINUOUS SPECIAL INSPECTION OF CONCRETE PLACEMENT.		
F	CONTINUOUS SPECIAL INSPECTION OF DRILLING OPERATION FOR PIER FOUNDATIONS.		
3	REINFORCING STEEL:		
Α	PLACING OF REINFORCING PER SECTION 1705.3 (TABLE 1705.3).		
В	PERIODIC SPECIAL INSPECTION OF PLACEMENT OF REINFORCEMENT STEEL		PERIODIC
4	HIGH STRENGTH BOLTING:		
Α	PERIODIC SPECIAL INSPECTION OF HIGH-STRENGTH BOLTING		PERIODIC
5	MASONRY:		
Α	LEVEL 1 SPECIAL INSPECTION IS REQUIRED FOR MASONRY IN ACCORDANCE WITH CODE SECTION 1705.4.		PERIODIC
6	WELDING:		
	NO FIELD WELDING SHALL BE PERMITTED. STEEL FABRICATION SHALL BE DONE ON THE PREMISES OF A FABRICATOR REGISTERED		N/A
	AND APPROVED TO PERFORM SUCH WORK WITHOUT SPECIAL INSPECTION.		

SPECIAL INSPECTION NOTES:

- THE SPECIAL INSPECTIONS IDENTIFIED ON PLANS ARE, IN ADDITION TO, AND NOT A SUBSTITUTE FOR, THOSE INSPECTIONS REQUIRED TO BE PERFORMED BY A CITY'S BUILDING INSPECTOR.
- 2. CONTINUOUS INSPECTION IS ALWAYS REQUIRED DURING THE PERFORMANCE OF THE WORK UNLESS OTHERWISE SPECIFIED. WHEN WORK IN MORE THAN ONE CATEGORY OF WORK REQUIRING SPECIAL INSPECTION IS TO BE PERFORMED SIMULTANEOUSLY, OR THE GEOGRAPHIC LOCATION OF THE WORK IS SUCH THAT IT CANNOT BE CONTINUOUSLY OBSERVED IN ACCORDANCE WITH THE PROVISIONS OF CBC SECTION 1704, IT IS THE AGENT'S RESPONSIBILITY TO EMPLOY A SUFFICIENT NUMBER OF INSPECTORS TO ASSURE THAT ALL THE WORK IS INSPECTED IN ACCORDANCE WITH THOSE PROVISIONS.
- 3. THE SPECIAL INSPECTORS MUST BE CERTIFIED BY THE AUTHORITY HAVING JURISDICTION, IN THE CATEGORY OF WORK REQUIRED TO HAVE SPECIAL INSPECTION.
- 4. IT IS THE RESPONSIBILITY OF THE CONTRACTOR TO NOTIFY THE SPECIAL INSPECTOR OR INSPECTION AGENCY AT LEAST ONE WORKING DAY PRIOR TO PERFORMING ANY WORK THAT REQUIRES SPECIAL INSPECTION.
- 5. NOTICE TO THE CONTRACTOR: BY USING THIS PERMITTED CONSTRUCTION DRAWINGS FOR CONSTRUCTION/INSTALLATION OF THE WORK SPECIFIED HEREIN, YOU AGREE TO COMPLY WITH THE REQUIREMENTS OF THE AUTHORITY HAVING JURISDICTION FOR SPECIAL INSPECTIONS, STRUCTURAL OBSERVATIONS, CONSTRUCTION MATERIAL TESTING AND OFF-SITE FABRICATION OF BUILDING COMPONENTS, CONTAINED IN THE STATEMENT OF SPECIAL INSPECTIONS AND, AS REQUIRED BY THE CALIFORNIA CONSTRUCTION CODES.
- 6. NOTICE TO THE CONTRACTOR/BUILDER/INSTALLER/SUB-CONTRACTOR/ OWNER-BUILDER: BY USING THIS PERMITTED CONSTRUCTION DRAWINGS FOR CONSTRUCTION/INSTALLATION OF THE WORK SPECIFIED HEREIN, YOU ACKNOWLEDGE AND ARE AWARE OF, THE REQUIREMENTS CONTAINED IN THE STATEMENT OF SPECIAL INSPECTIONS. YOU AGREE TO COMPLY WITH THE REQUIREMENTS OF THE AUTHORITY HAVING JURISDICTION FOR SPECIAL INSPECTIONS, STRUCTURAL OBSERVATIONS, CONSTRUCTION MATERIAL TESTING AND OFF-SITE FABRICATION OF BUILDING COMPONENTS, CONTAINED IN THE STATEMENT OF SPECIAL INSPECTIONS AND, AS REQUIRED BY THE CALIFORNIA CONSTRUCTION CODES.
- 7. THE CONSTRUCTION MATERIALS TESTING LABORATORY MUST BE APPROVED BY THE AUTHORITY HAVING JURISDICTION, FOR TESTING OF MATERIALS, SYSTEMS, COMPONENTS AND, EQUIPMENTS.
- 8. WORK REQUIRING SPECIAL INSPECTION THAT IS INSTALLED OR COVERED WITHOUT THE APPROVAL OF THE CITY INPSECTOR IS SUBJECT TO REMOVAL OR EXPOSURE AT NO COST TO THE GOVERNING JURISDICTION.



1452 EDINGER AVE. 3RD FLOOR TUSTIN, CA 92780



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NOT RUCTION CONSTRUCTION

IT IS A VIOLATION OF LAW FOR ANY PERSON, UNLESS THEY ARE ACTING UNDER THE DIRECTION OF THE LICENSED PROFESSIONAL ENGINEER, TO ALTER THIS DOCUMENT.

DRAWN BY:	UTILITIES CHECKED BY:	A&E CHECKED BY:	
DW/AS	GD	RB	

CONSTRUCTION DRAWINGS

	SUBMITTALS				
REV	DATE	DESCRIPTION			
Α	04/26/24	90% CONSTRUCTION DRAWINGS			
В	08/29/24	JX COMMENTS			
0	03/12/24	100% CONSTRUCTION DRAWINGS			

PROJECT INFORMATION


CLL05463

1700 N. TOWNE AVE. CLAREMONT, CA 91711

SHEET TITLE
STATEMENT OF
SPECIAL
INSPECTIONS

SHEET NUMBER

T-4

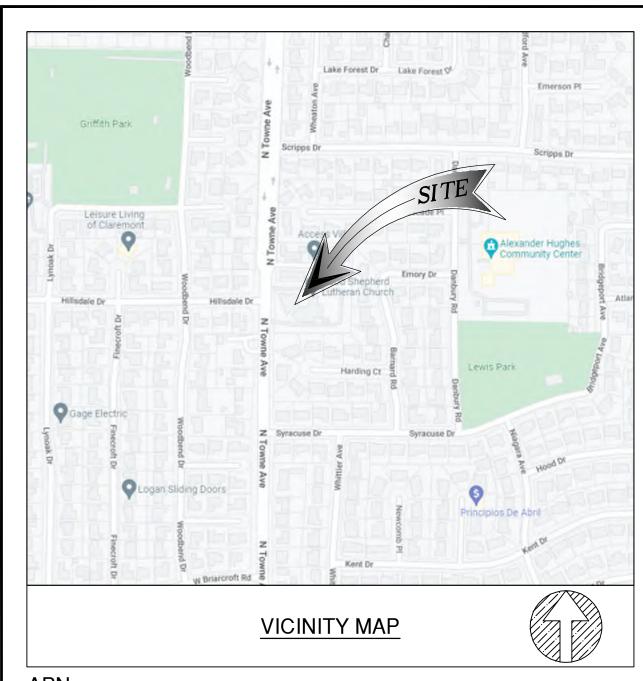

<u>APN</u> 8303-010-043

SITE ADDRESS 1700 N. TOWNE AVE., CLAREMONT, CA 91711

TITLE REPORT

TITLE REPORT WAS PREPARED BY COMMONWEALTH LAND TITLE INSURANCE COMPANY WITH ORDER NUMBER 92017324-920-CMM-CM8 AND GUARANTEE NUMBER CA-SFXFC-IMP-81G28-1-22-92017324 DATED FEBRUARY 23, 2022.

BASIS OF BEARING

BEARINGS SHOWN HEREON ARE BASED UPON U.S. STATE PLANE NAD83 COORDINATE SYSTEM CALIFORNIA STATE PLANE COORDINATE ZONE FIVE DETERMINED BY GPS OBSERVATIONS.

BENCHMARK

ELEVATIONS ARE BASED ON CRTN (CSRC) NETWORK BROADCAST COORDINATES.

FLOODZONE

SITE IS LOCATED IN FLOOD ZONE "X" AS PER F.I.R.M. MAP NO. 06037C1750F EFFECTIVE DATE 09/26/2008.

NOTES:

- THIS IS NOT A BOUNDARY SURVEY. THIS IS A SPECIALIZED TOPOGRAPHIC MAP. THE PROPERTY LINES AND EASEMENTS SHOWN HEREON ARE FROM RECORD INFORMATION AS NOTED HEREON. CELLSITE CONCEPTS TRANSLATED THE TOPOGRAPHIC SURVEY TO RECORD INFORMATION USING FOUND MONUMENTS SHOWN HEREON. THE LOCATION OF PROPERTY LINES SHOWN HEREON ARE APPROXIMATE AND FOR INFORMATIONAL PURPOSES ONLY. THEY ARE NOT TO BE RELIED UPON AS THE ACTUAL BOUNDARY LINES.
- 2. ANY CHANGES MADE TO THE INFORMATION ON THIS PLAN, WITHOUT THE WRITTEN CONSENT OF CELLSITE CONCEPTS, RELIEVES CELLSITE CONCEPTS OF ANY AND ALL LIABILITY.
- 3. THE HEIGHTS AND ELEVATIONS FOR THE TREES, BUSHES AND OTHER LIVING PLANTS SHOWN HEREON, SHOULD BE CONSIDERED APPROXIMATE (+/-) AND ONLY FOR THE DATE OF THIS SURVEY. THEY ARE PROVIDED AS A GENERAL REFERENCE AND SHOULD NOT BE USED FOR DESIGN PURPOSES.
- 4. WRITTEN DIMENSIONS SHALL TAKE PREFERENCE OVER SCALED & SHALL BE VERIFIED ON THE JOB SITE. ANY DISCREPANCY SHALL BE BROUGHT TO THE NOTICE OF THE SURVEYOR PRIOR TO COMMENCEMENT OF ANY WORK.
- 5. FIELD SURVEY COMPLETED ON FEBRUARY 23, 2022.

LEGAL DESCRIPTION

ALL THAT CERTAIN REAL PROPERTY SITUATED IN THE CITY OF CLAREMONT, COUNTY OF LOS ANGELES, STATE OF CALIFORNIA, DESCRIBED AS FOLLOWS:

PARCEL 2 OF PARCEL MAP NO. 14693, IN THE CITY OF CLAREMONT, COUNTY OF LOS ANGELES, STATE OF CALIFORNIA, AS PER PLAT RECORDED IN BOOK 151, PAGES 19 AND 20 OF PARCEL MAPS, IN THE OFFICE OF THE COUNTY RECORDER OF SAID

APN: 8303-010-043

SCHEDULE B (EXCEPTIONS)

ITEMS A & B ARE TAX RELATED ITEMS C & D ARE LIENS RELATED ITEM 1 & 7 ARE RIGHTS RELATED ITEM 5 IS DEEDS RELATED ITEM 6 IS ADVISORY RELATED

EASEMENTS:


ITEM 2, & 3 ARE NOT PLOTTED. THE EXACT LOCATION AND EXTENT OF SAID EASEMENT ARE NOT DISCLOSED OF RECORD.

EASEMENT(S) FOR THE PURPOSE(S) SHOWN BELOW AND RIGHTS INCIDENTAL THERETO AS SET FORTH IN A DOCUMENT: PURPOSE: PUBLIC UTILITIES RECORDING DATE: MAY 20, 1966 RECORDING NO: 4247 OF OFFICIAL RECORDS

PROPERTY LINES DERIVED FROM

AFFECTS: A PORTION OF SAID LAND

PARCEL MAP NO. 14693 BK. 151 PG. 19-20 DATED APRIL 09, 1982 DATED DECEMBER 07, 1960 TRACT NO. 26169 BK. 664 PG. 43-44 TRACT NO. 22450 BK. 720 PG. 97-99 DATED APRIL 28, 1964

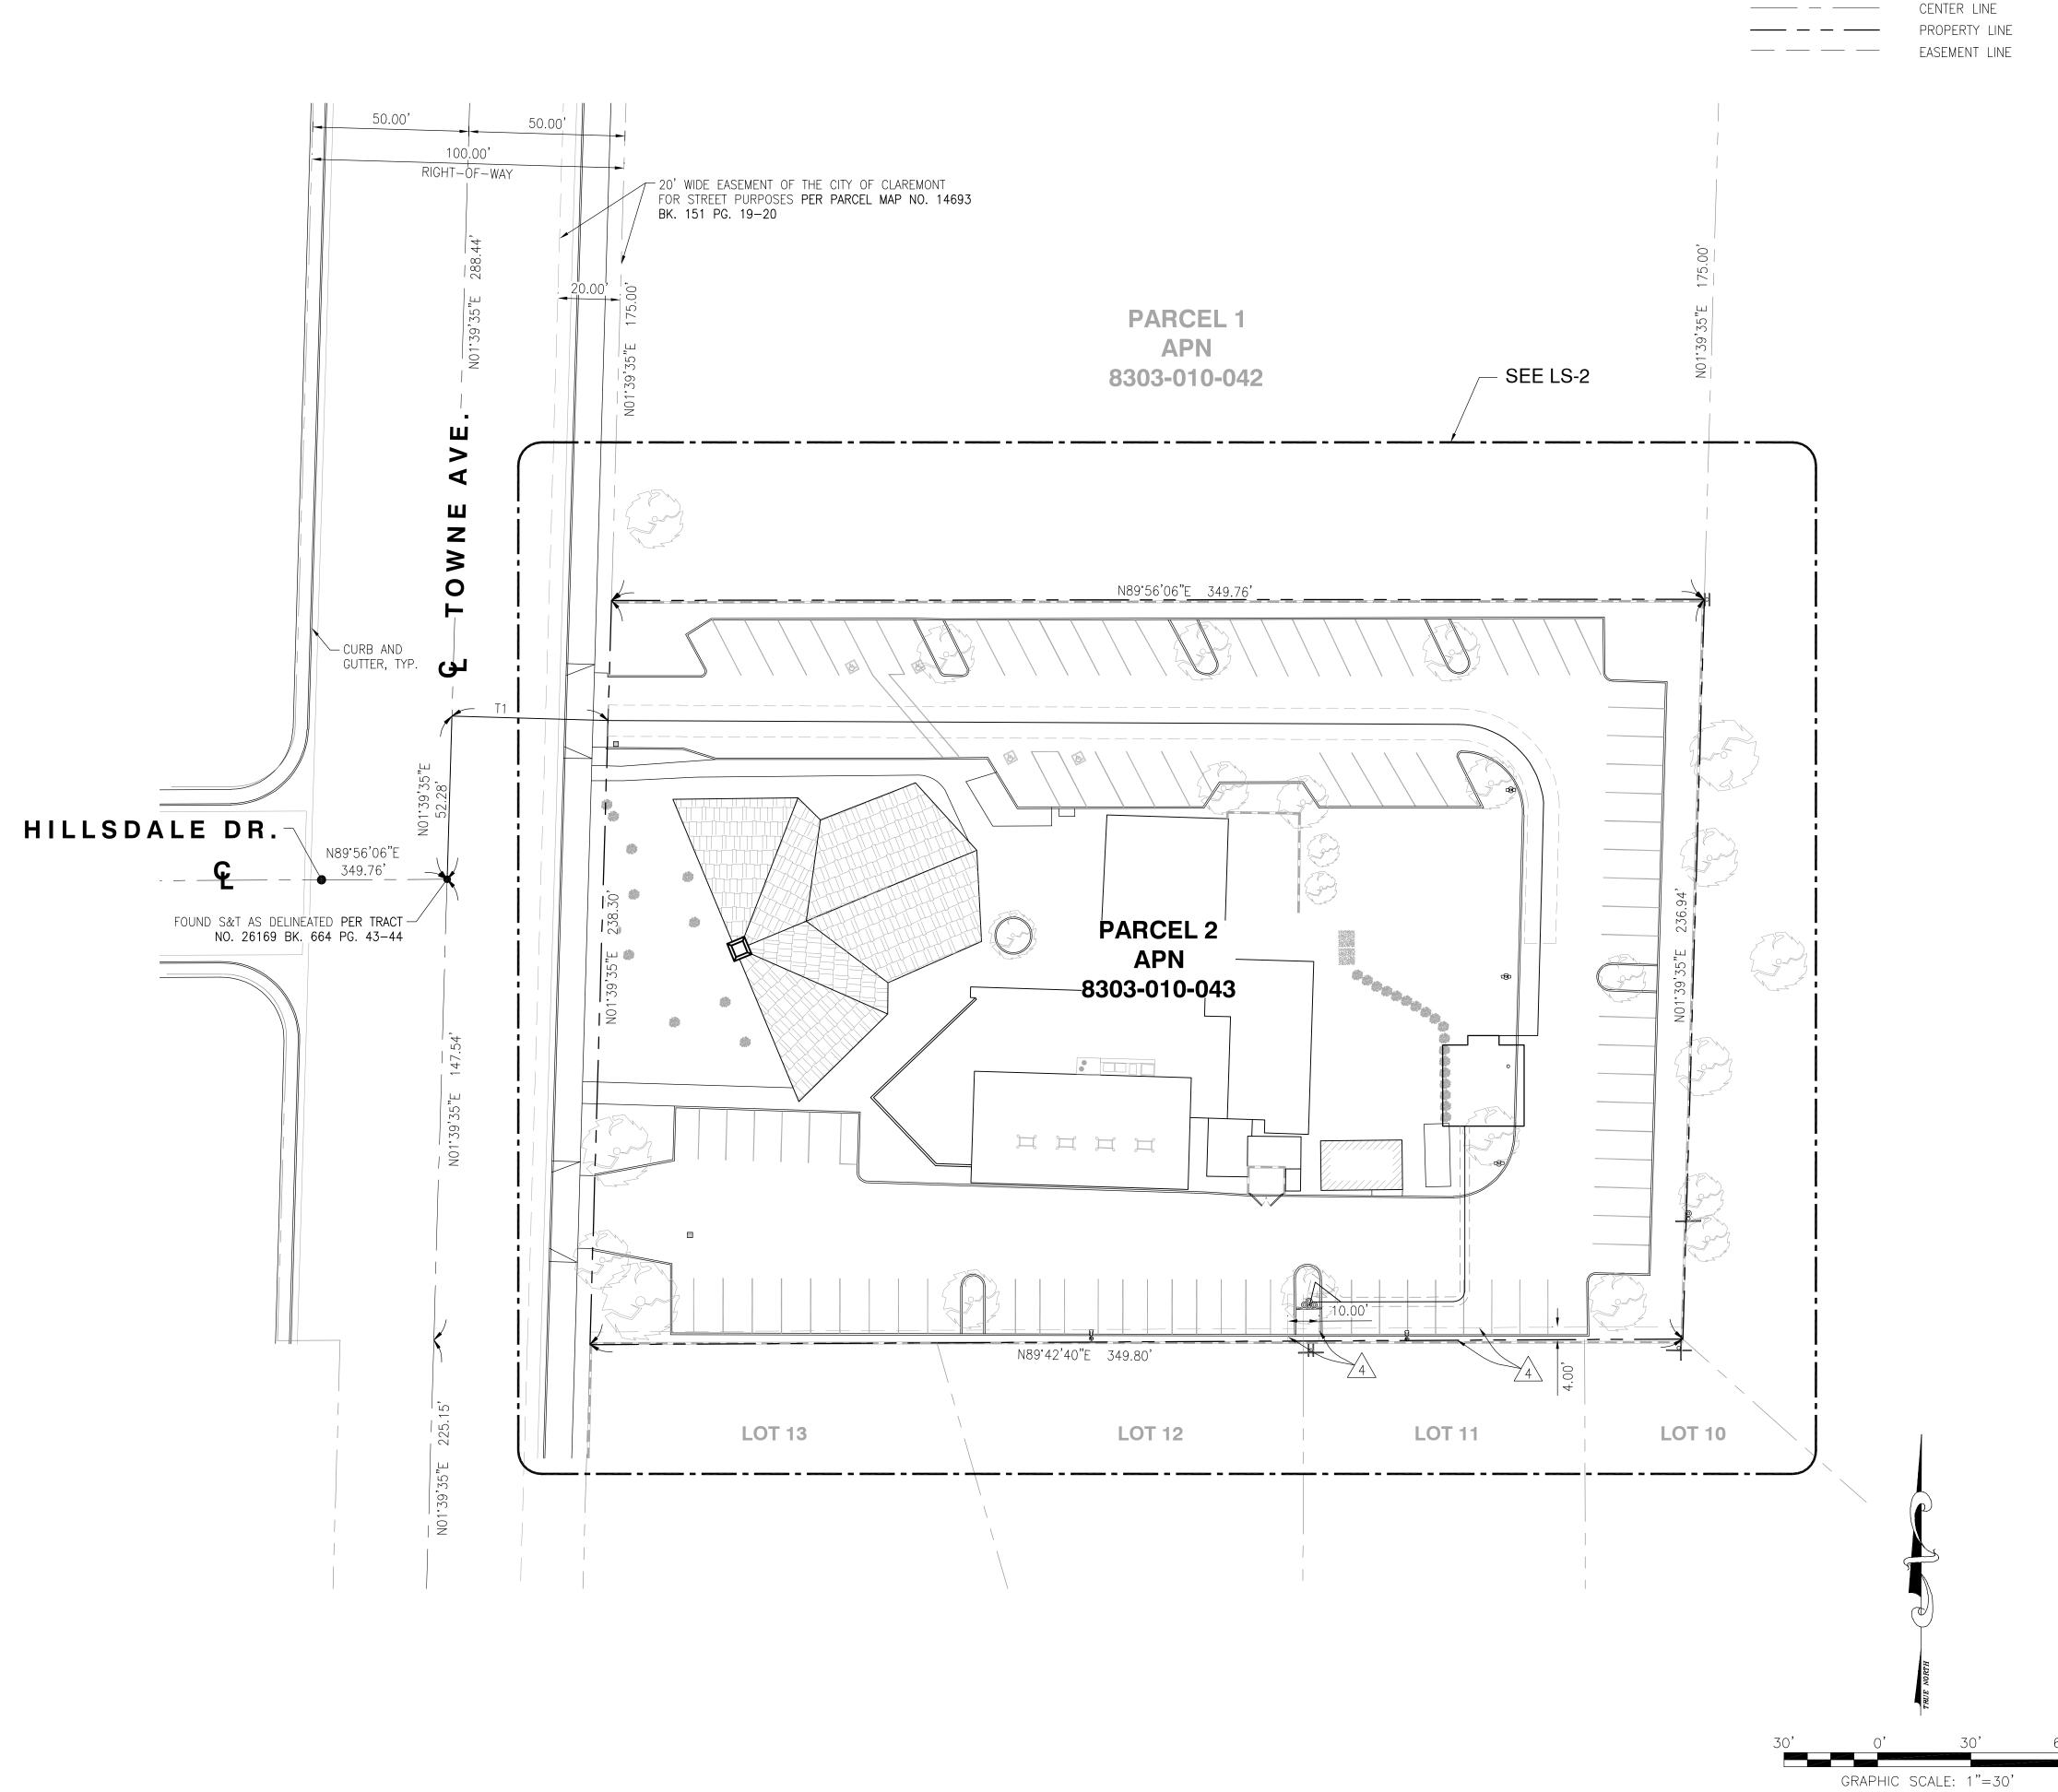



LINE TABLE

BEARING

S88'20'25"E

LENGTH

50.00'

NO.

LEGENDS



IRVINE, CA 92618 TEL: (949) 553-8566



SAN DIEGO, CA 92127

tel: (858) 432-4112 / (858) 432-4257

	6	04/07/2025	REVISED LEGAL DESCRIPTION
Ì	5	04/24/2023	REVISED LEASE AREA LOCATION
	4	02/10/2023	LEGAL DESCRIPTION UPDATE
	3	12/19/2022	ADDITIONAL SURVEY POINTS
	2	04/11/2022	FINAL SURVEY
	1	03/02/2022	PRELIMINARY SURVEY
	REV	DATE	DESCRIPTION

ISSUED DATE: -

APRIL 07, 2025

ISSUED FOR:

FINAL SURVEY

LICENSURE: -



PROJECT-INFORMATION: -

CLL05463

1700 N. TOWNE AVE., CLAREMONT, CA 91711


DRAWN BY: CHECKED BY:

SHEET-TITLE: -

TOPOGRAPHIC SURVEY

SHEET-NUMBER: -

LS-1

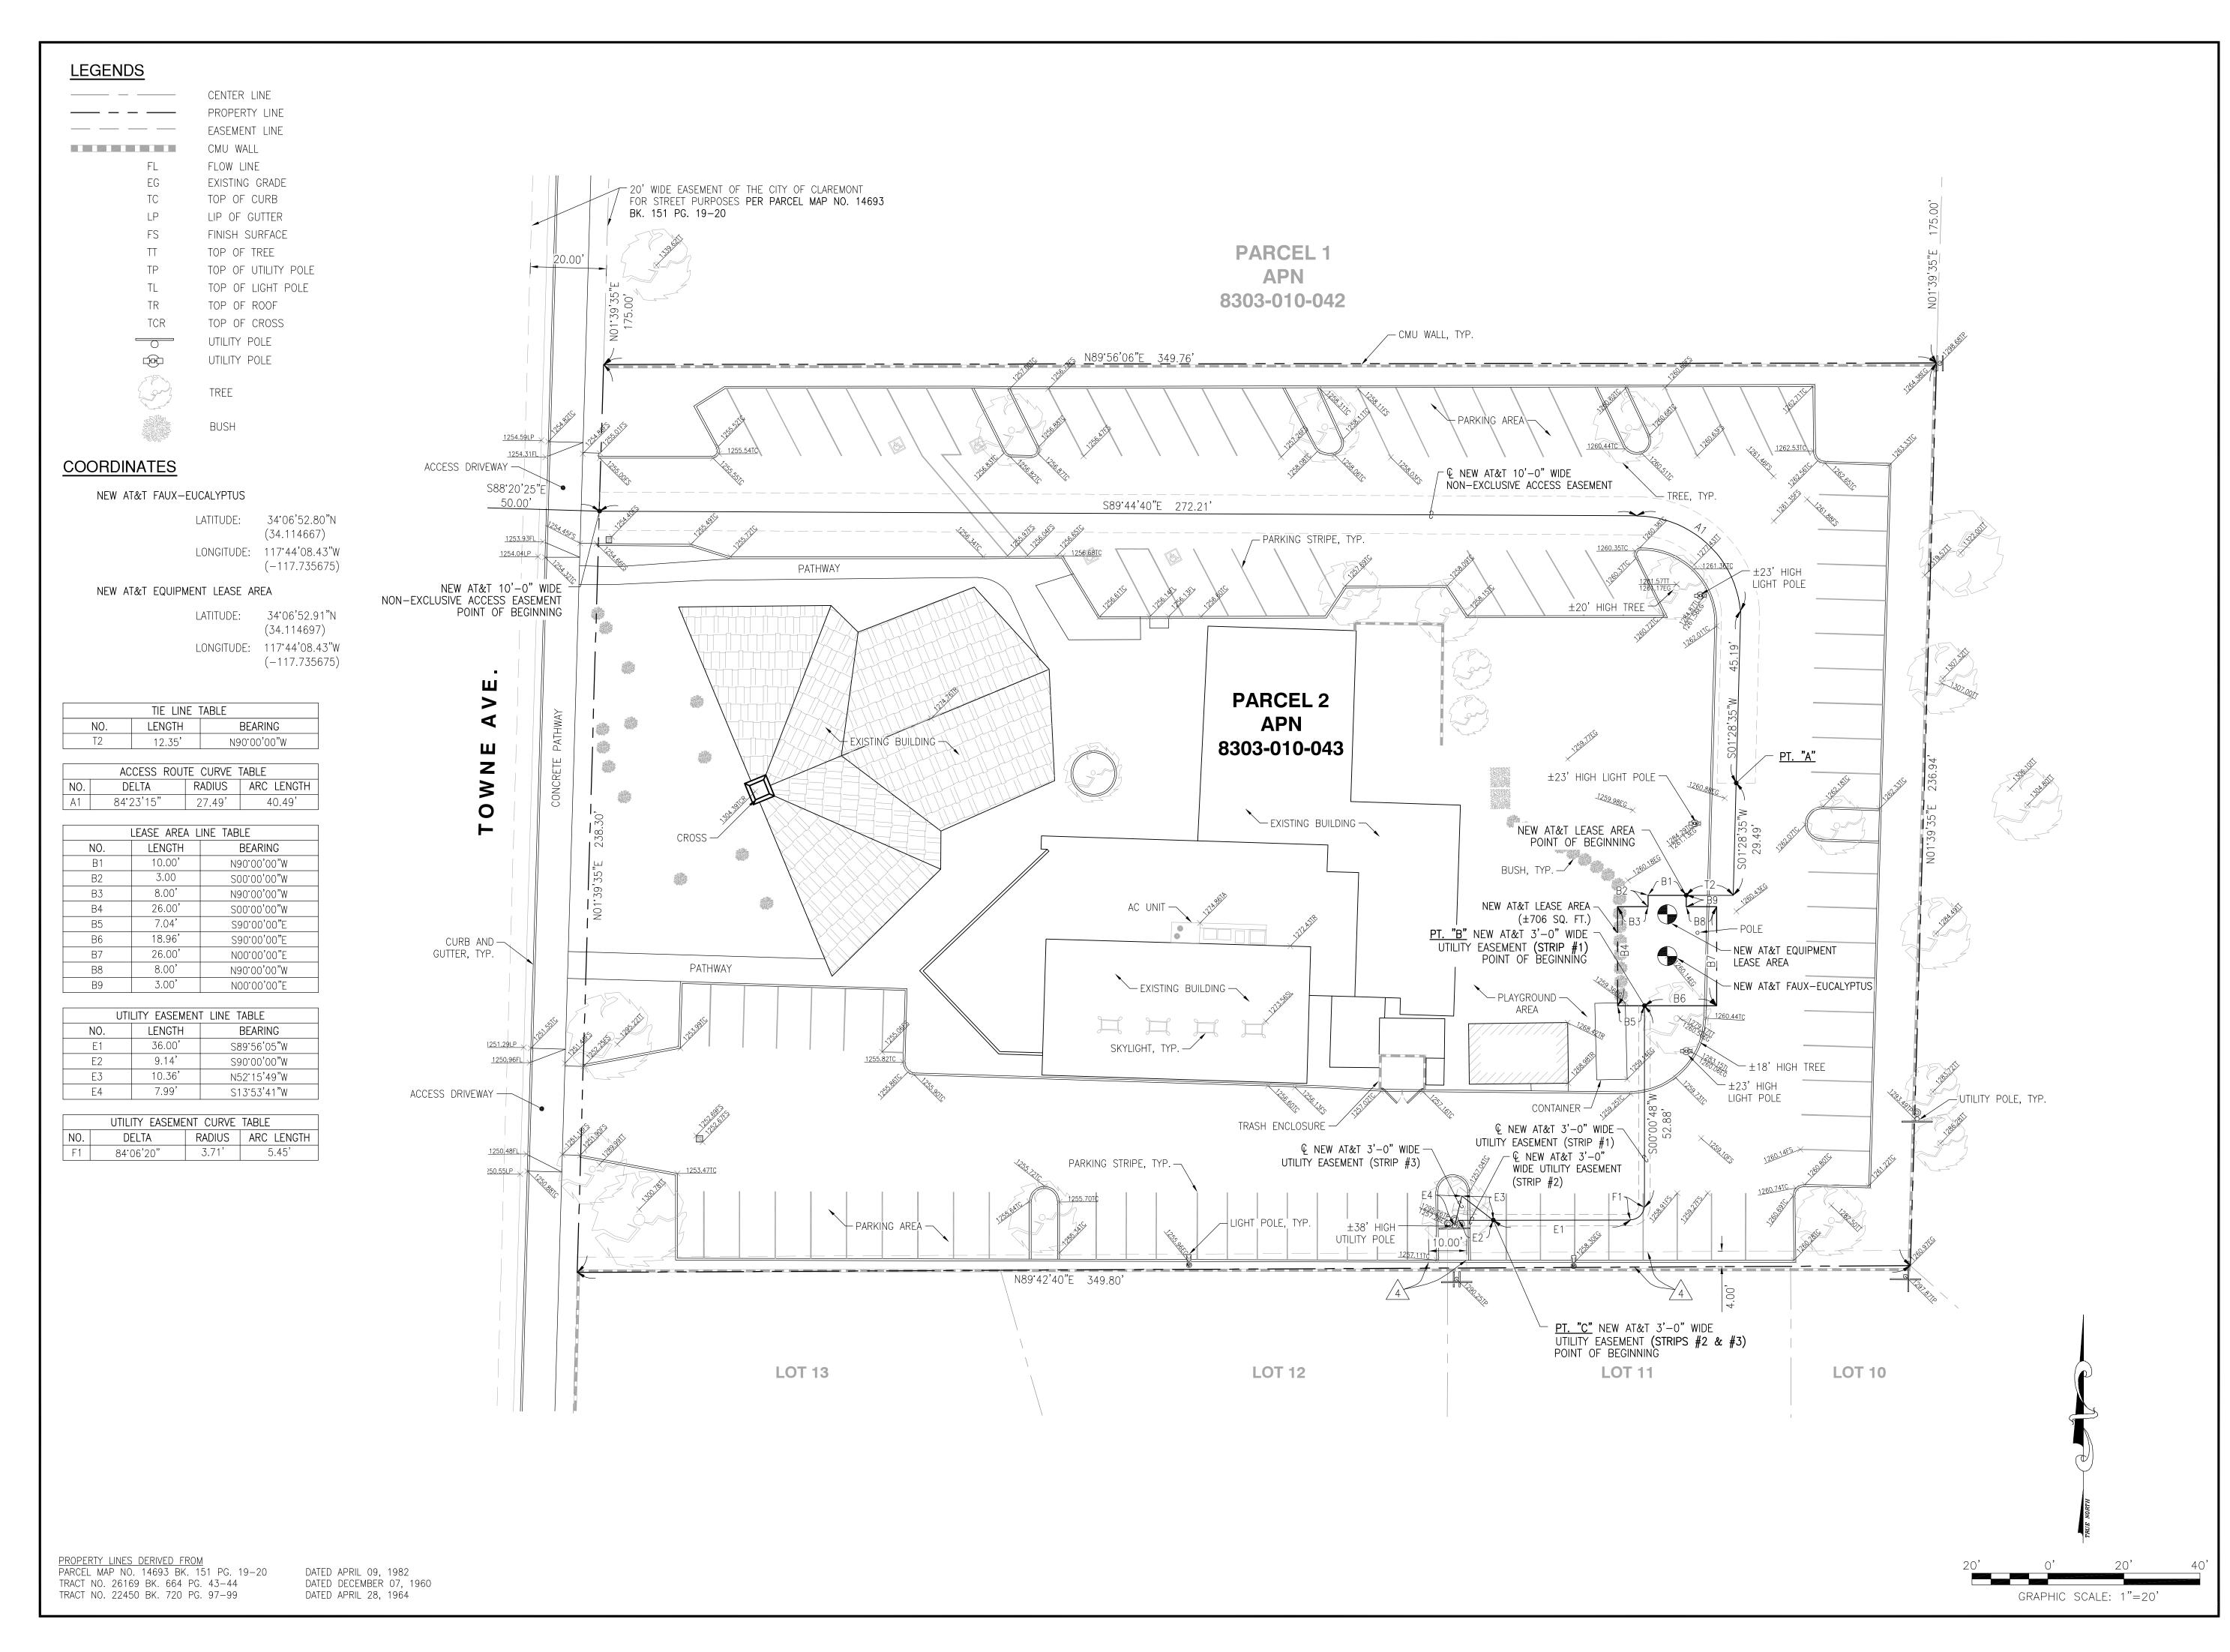







SAN DIEGO, CA 92127

tel: (858) 432-4112 / (858) 432-4257

	6	04/07/2025	REVISED LEGAL DESCRIPTION
I	5	04/24/2023	REVISED LEASE AREA LOCATION
ı	4	02/10/2023	LEGAL DESCRIPTION UPDATE
	3	12/19/2022	ADDITIONAL SURVEY POINTS

ISSUED DATE: -

REV DATE

2 | 04/11/2022 | FINAL SURVEY

1 | 03/02/2022 | PRELIMINARY SURVEY

APRIL 07, 2025

DESCRIPTION

ISSUED FOR:

FINAL SURVEY

LICENSURE: -



PROJECT-INFORMATION: -

CLL05463

1700 N. TOWNE AVE., CLAREMONT, CA 91711

DRAWN BY: KF

CHECKED BY: RH

SHEET-TITLE:

TOPOGRAPHIC SURVEY

SHEET-NUMBER:

LS-2

10 FEET WIDE NON-EXCLUSIVE ACCESS EASEMENT CENTERLINE DESCRIPTION:

ALL THAT CERTAIN REAL PROPERTY SITUATED IN THE CITY OF CLAREMONT, COUNTY OF LOS ANGELES, STATE OF CALIFORNIA, DESCRIBED AS FOLLOWS:

PARCEL 2, IN THE CITY OF CLAREMONT, COUNTY OF LOS ANGELES, STATE OF CALIFORNIA, AS SHOWN ON PLAT RECORD OF IN BOOK 151, PAGE 19 AND 20 OF PARCEL MAPS, IN THE OFFICE OF THE COUNTY RECORDER OF SAID COUNTY.

A STRIP OF LAND FOR NON-EXCLUSIVE ACCESS EASEMENT PURPOSES FOR THE LAND REFERRED TO HEREIN SITUATED IN THE CITY OF CLAREMONT, COUNTY OF LOS ANGELES, STATE OF CALIFORNIA, AND IS DESCRIBED AS FOLLOWS:

AN EASEMENT TEN (10.00) FEET IN WIDTH LYING FIVE (5.00) FEET ON EACH SIDE OF THE FOLLOWING DESCRIBED CENTERLINE TO WIT:

COMMENCING AT THE CENTERLINE INTERSECTION OF TOWNE AVENUE AND HILLSDALE DRIVE, AS SHOWN ON THAT TRACT NO. 26169 AS PER MAP FILED IN BOOK 664 PAGES 43 THROUGH 44 OF MAPS IN THE OFFICE OF THE COUNTY RECORDER OF LOS ANGELES COUNTY; THENCE NORTHERLY ALONG THE SAID CENTERLINE OF TOWNE AVENUE, NORTH 01°39'35" EAST A DISTANCE OF 52.28 FEET; THENCE EASTERLY LEAVING SAID CENTERLINE OF TOWNE AVENUE, SOUTH 88°20'25" EAST A DISTANCE OF 50.00 FEET TO THE WESTERLY LINE OF SAID PARCEL 2, ALSO BEING THE POINT OF BEGINNING OF THIS CENTERLINE DESCRIPTION;

THENCE LEAVING SAID WESTERLY LINE OF SAID PARCEL 2, SOUTH 89'44'40" EAST A DISTANCE OF 272.21 FEET TO THE BEGINNING OF A TANGENT CURVE CONCAVE TO THE SOUTHWEST HAVING A RADIUS OF 27.49 FEET; THENCE SOUTHEASTERLY, 40.49 FEET ALONG SAID CURVE THROUGH A CENTRAL ANGLE OF 84'23'15"; THENCE SOUTH 01'28'35" WEST A DISTANCE OF 45.19 FEET TO A POINT REFERRED TO HEREINAFTER AS <u>POINT</u> "A" ALSO BEING THE TERMINUS POINT OF THIS CENTERLINE DESCRIPTION.

THE SIDE LINES OF SAID TEN (10.00) FEET WIDE ACCESS EASEMENT IS TO BE EXTENDED AND/OR SHORTENED TO TERMINATE IN THE LANDS OF THE GRANTOR AND SHALL BE JOINED AT ALL ANGLE POINTS.

SUBJECT TO ALL EASEMENTS AND/OR RIGHT-OF-WAY RECORDS.

SEE NON-EXCLUSIVE ACCESS EASEMENT ON SHEET LS-2.

NEW AT&T LEASE AREA DESCRIPTION

ALL THAT CERTAIN REAL PROPERTY SITUATED IN THE CITY OF CLAREMONT, COUNTY OF LOS ANGELES, STATE OF CALIFORNIA, DESCRIBED AS FOLLOWS:

PARCEL 2, IN THE CITY OF CLAREMONT, COUNTY OF LOS ANGELES, STATE OF CALIFORNIA, AS SHOWN ON PLAT RECORD OF IN BOOK 151, PAGE 19 AND 20 OF PARCEL MAPS, IN THE OFFICE OF THE COUNTY RECORDER OF SAID COUNTY.

A STRIP OF LAND FOR AT&T LEASE AREA PURPOSES FOR THE LAND REFERRED TO HEREIN SITUATED IN THE CITY OF CLAREMONT, COUNTY OF LOS ANGELES, STATE OF CALIFORNIA, AND IS DESCRIBED AS FOLLOWS TO WIT:

BEGINNING AT SAID **POINT "A"**;

THENCE SOUTH 01'28'35" WEST, A DISTANCE OF 29.49 FEET;

THENCE NORTH 90°00'00" WEST, A DISTANCE OF 12.35 FEET TO THE **POINT OF BEGINNING** OF THIS **NEW AT&T LEASE AREA** DESCRIPTION;

- THENCE NORTH 90'00'00" WEST, A DISTANCE OF 10.00 FEET;
- THENCE SOUTH 00'00'00" WEST, A DISTANCE OF 3.00 FEET;
- THENCE NORTH 90'00'00" WEST, A DISTANCE OF 8.00 FEET;
- THENCE SOUTH 00'00'00" WEST, A DISTANCE OF 26.00 FEET;
- THENCE SOUTH 90'00'00" EAST, A DISTANCE OF 7.04 FEET TO A POINT REFERRED TO HEREINAFTER AS POINT "B";
- THENCE SOUTH 90'00'00" EAST, A DISTANCE OF 18.96 FEET;
- THENCE NORTH 00°00'00" EAST, A DISTANCE OF 26.00 FEET; THENCE NORTH 90°00'00" WEST, A DISTANCE OF 8.00 FEET;
- THENCE NORTH 00°00'00" EAST, A DISTANCE OF 3.00 FEET TO THE POINT OF BEGINNING OF THIS NEW AT&T LEASE AREA DESCRIPTION.

CONTAINING 706 SQUARE FEET MORE OR LESS.

SUBJECT TO ALL EASEMENTS AND/OR RIGHT-OF-WAY RECORDS.

SEE NEW AT&T LEASE AREA ON SHEET LS-2.

3 FEET WIDE UTILITY EASEMENT CENTERLINE DESCRIPTION (STRIP #1):

ALL THAT CERTAIN REAL PROPERTY SITUATED IN THE CITY OF CLAREMONT, COUNTY OF LOS ANGELES, STATE OF CALIFORNIA, DESCRIBED AS FOLLOWS:

PARCEL 2, IN THE CITY OF CLAREMONT, COUNTY OF LOS ANGELES, STATE OF CALIFORNIA, AS SHOWN ON PLAT RECORD OF IN BOOK 151, PAGE 19 AND 20 OF PARCEL MAPS, IN THE OFFICE OF THE COUNTY RECORDER OF SAID COUNTY.

A STRIP OF LAND FOR UTILITY EASEMENT PURPOSES FOR THE LAND REFERRED TO HEREIN SITUATED IN THE CITY OF CLAREMONT, COUNTY OF LOS ANGELES, STATE OF CALIFORNIA AND IS DESCRIBED AS FOLLOWS:

AN EASEMENT FOR FIBER AND POWER UTILITIES THREE (3.00) FEET IN WIDTH LYING ONE AND A HALF (1.50) FEET ON EACH SIDE OF THE FOLLOWING DESCRIBED CENTERLINE TO WIT:

BEGINNING AT SAID POINT "B";

THENCE SOUTH 00'00'48" WEST, A DISTANCE OF 52.88 FEET TO THE BEGINNING OF A NON-TANGENT CURVE CONCAVE TO THE NORTHWEST HAVING A RADIUS OF 3.71 FEET AND TO WHICH SAID BEGINNING A RADIAL LINE BEARS SOUTH 84'21'27" EAST; THENCE SOUTHWESTERLY, 5.45 FEET ALONG SAID CURVE THROUGH A CENTRAL ANGLE OF 84'06'20"; THENCE SOUTH 89'56'05" WEST, A DISTANCE OF 36.00 FEET TO A POINT REFERRED TO HEREINAFTER AS <u>POINT</u> "C", ALSO BEING THE TERMINUS POINT OF THIS CENTERLINE DESCRIPTION.

THE SIDE LINES OF SAID THREE (3.00) FEET WIDE UTILITY EASEMENT IS TO BE EXTENDED AND/OR SHORTENED TO TERMINATE IN THE LANDS OF THE GRANTOR AND SHALL BE JOINED AT ALL ANGLE POINTS.

SUBJECT TO ALL EASEMENTS AND/OR RIGHT-OF-WAY RECORDS.

SEE UTILITY EASEMENT (STRIP #1) ON SHEET LS-2.

3 FEET WIDE UTILITY EASEMENT CENTERLINE DESCRIPTION (STRIP #2):

ALL THAT CERTAIN REAL PROPERTY SITUATED IN THE CITY OF CLAREMONT, COUNTY OF LOS ANGELES, STATE OF CALIFORNIA, DESCRIBED AS FOLLOWS:

PARCEL 2, IN THE CITY OF CLAREMONT, COUNTY OF LOS ANGELES, STATE OF CALIFORNIA, AS SHOWN ON PLAT RECORD OF IN BOOK 151, PAGE 19 AND 20 OF PARCEL MAPS, IN THE OFFICE OF THE COUNTY RECORDER OF SAID COUNTY.

A STRIP OF LAND FOR UTILITY EASEMENT PURPOSES FOR THE LAND REFERRED TO HEREIN SITUATED IN THE CITY OF CLAREMONT, COUNTY OF LOS ANGELES, STATE OF CALIFORNIA AND IS DESCRIBED AS FOLLOWS:

AN EASEMENT FOR POWER UTILITIES THREE (3.00) FEET IN WIDTH LYING ONE AND A HALF (1.50) FEET ON EACH SIDE OF THE FOLLOWING DESCRIBED CENTERLINE TO WIT:

BEGINNING AT SAID <u>Point "C";</u> Thence south 90°00'00" West, a distance of 9.14 feet to the **terminus point** of this centerline

THE SIDE LINES OF SAID THREE (3.00) FEET WIDE UTILITY EASEMENT IS TO BE EXTENDED AND/OR SHORTENED TO TERMINATE IN THE LANDS OF THE GRANTOR AND SHALL BE JOINED AT ALL ANGLE POINTS.

SUBJECT TO ALL EASEMENTS AND/OR RIGHT-OF-WAY RECORDS.

SEE UTILITY EASEMENT (STRIP #2) ON SHEET LS-2.

DESCRIPTION.

3 FEET WIDE UTILITY EASEMENT CENTERLINE DESCRIPTION (STRIP #3):

ALL THAT CERTAIN REAL PROPERTY SITUATED IN THE CITY OF CLAREMONT, COUNTY OF LOS ANGELES, STATE OF CALIFORNIA. DESCRIBED AS FOLLOWS:

PARCEL 2, IN THE CITY OF CLAREMONT, COUNTY OF LOS ANGELES, STATE OF CALIFORNIA, AS SHOWN ON PLAT RECORD OF IN BOOK 151, PAGE 19 AND 20 OF PARCEL MAPS, IN THE OFFICE OF THE COUNTY RECORDER OF SAID COUNTY.

A STRIP OF LAND FOR UTILITY EASEMENT PURPOSES FOR THE LAND REFERRED TO HEREIN SITUATED IN THE CITY OF CLAREMONT, COUNTY OF LOS ANGELES, STATE OF CALIFORNIA AND IS DESCRIBED AS FOLLOWS:

AN EASEMENT FOR FIBER UTILITIES THREE (3.00) FEET IN WIDTH LYING ONE AND A HALF (1.50) FEET ON EACH SIDE OF THE FOLLOWING DESCRIBED CENTERLINE TO WIT:

BEGINNING AT SAID <u>Point "C"</u>;

THENCE NORTH 52°15'49" WEST, A DISTANCE OF 10.36 FEET;

THENCE SOUTH 13.53.41" WEST, A DISTANCE OF 7.99 FEET TO THE TERMINUS POINT OF THIS CENTERLINE DESCRIPTION.

THE SIDE LINES OF SAID THREE (3.00) FEET WIDE UTILITY EASEMENT IS TO BE EXTENDED AND/OR SHORTENED TO TERMINATE IN THE LANDS OF THE GRANTOR AND SHALL BE JOINED AT ALL ANGLE POINTS.

SUBJECT TO ALL EASEMENTS AND/OR RIGHT-OF-WAY RECORDS.

SEE UTILITY EASEMENT (STRIP #3) ON SHEET LS-2.







16885 VIA DEL CAMPO CT., SUITE 318 SAN DIEGO, CA 92127 tel: (858) 432-4112 / (858) 432-4257

	6	04/07/2025	REVISED LEGAL DESCRIPTION
	5	04/24/2023	REVISED LEASE AREA LOCATION
	4	02/10/2023	LEGAL DESCRIPTION UPDATE
	3	12/19/2022	ADDITIONAL SURVEY POINTS
	2	04/11/2022	FINAL SURVEY
	1	03/02/2022	PRELIMINARY SURVEY
	REV	DATE	DESCRIPTION

ISSUED DATE: -

APRIL 07, 2025

ISSUED FOR:

FINAL SURVEY

LICENSURE: -



PROJECT-INFORMATION: -

CLL05463

1700 N. TOWNE AVE., CLAREMONT, CA 91711


DRAWN BY: KF
CHECKED BY: RH


SHEET-TITLE: -

TOPOGRAPHIC SURVEY

SHEET-NUMBER:

LS-3

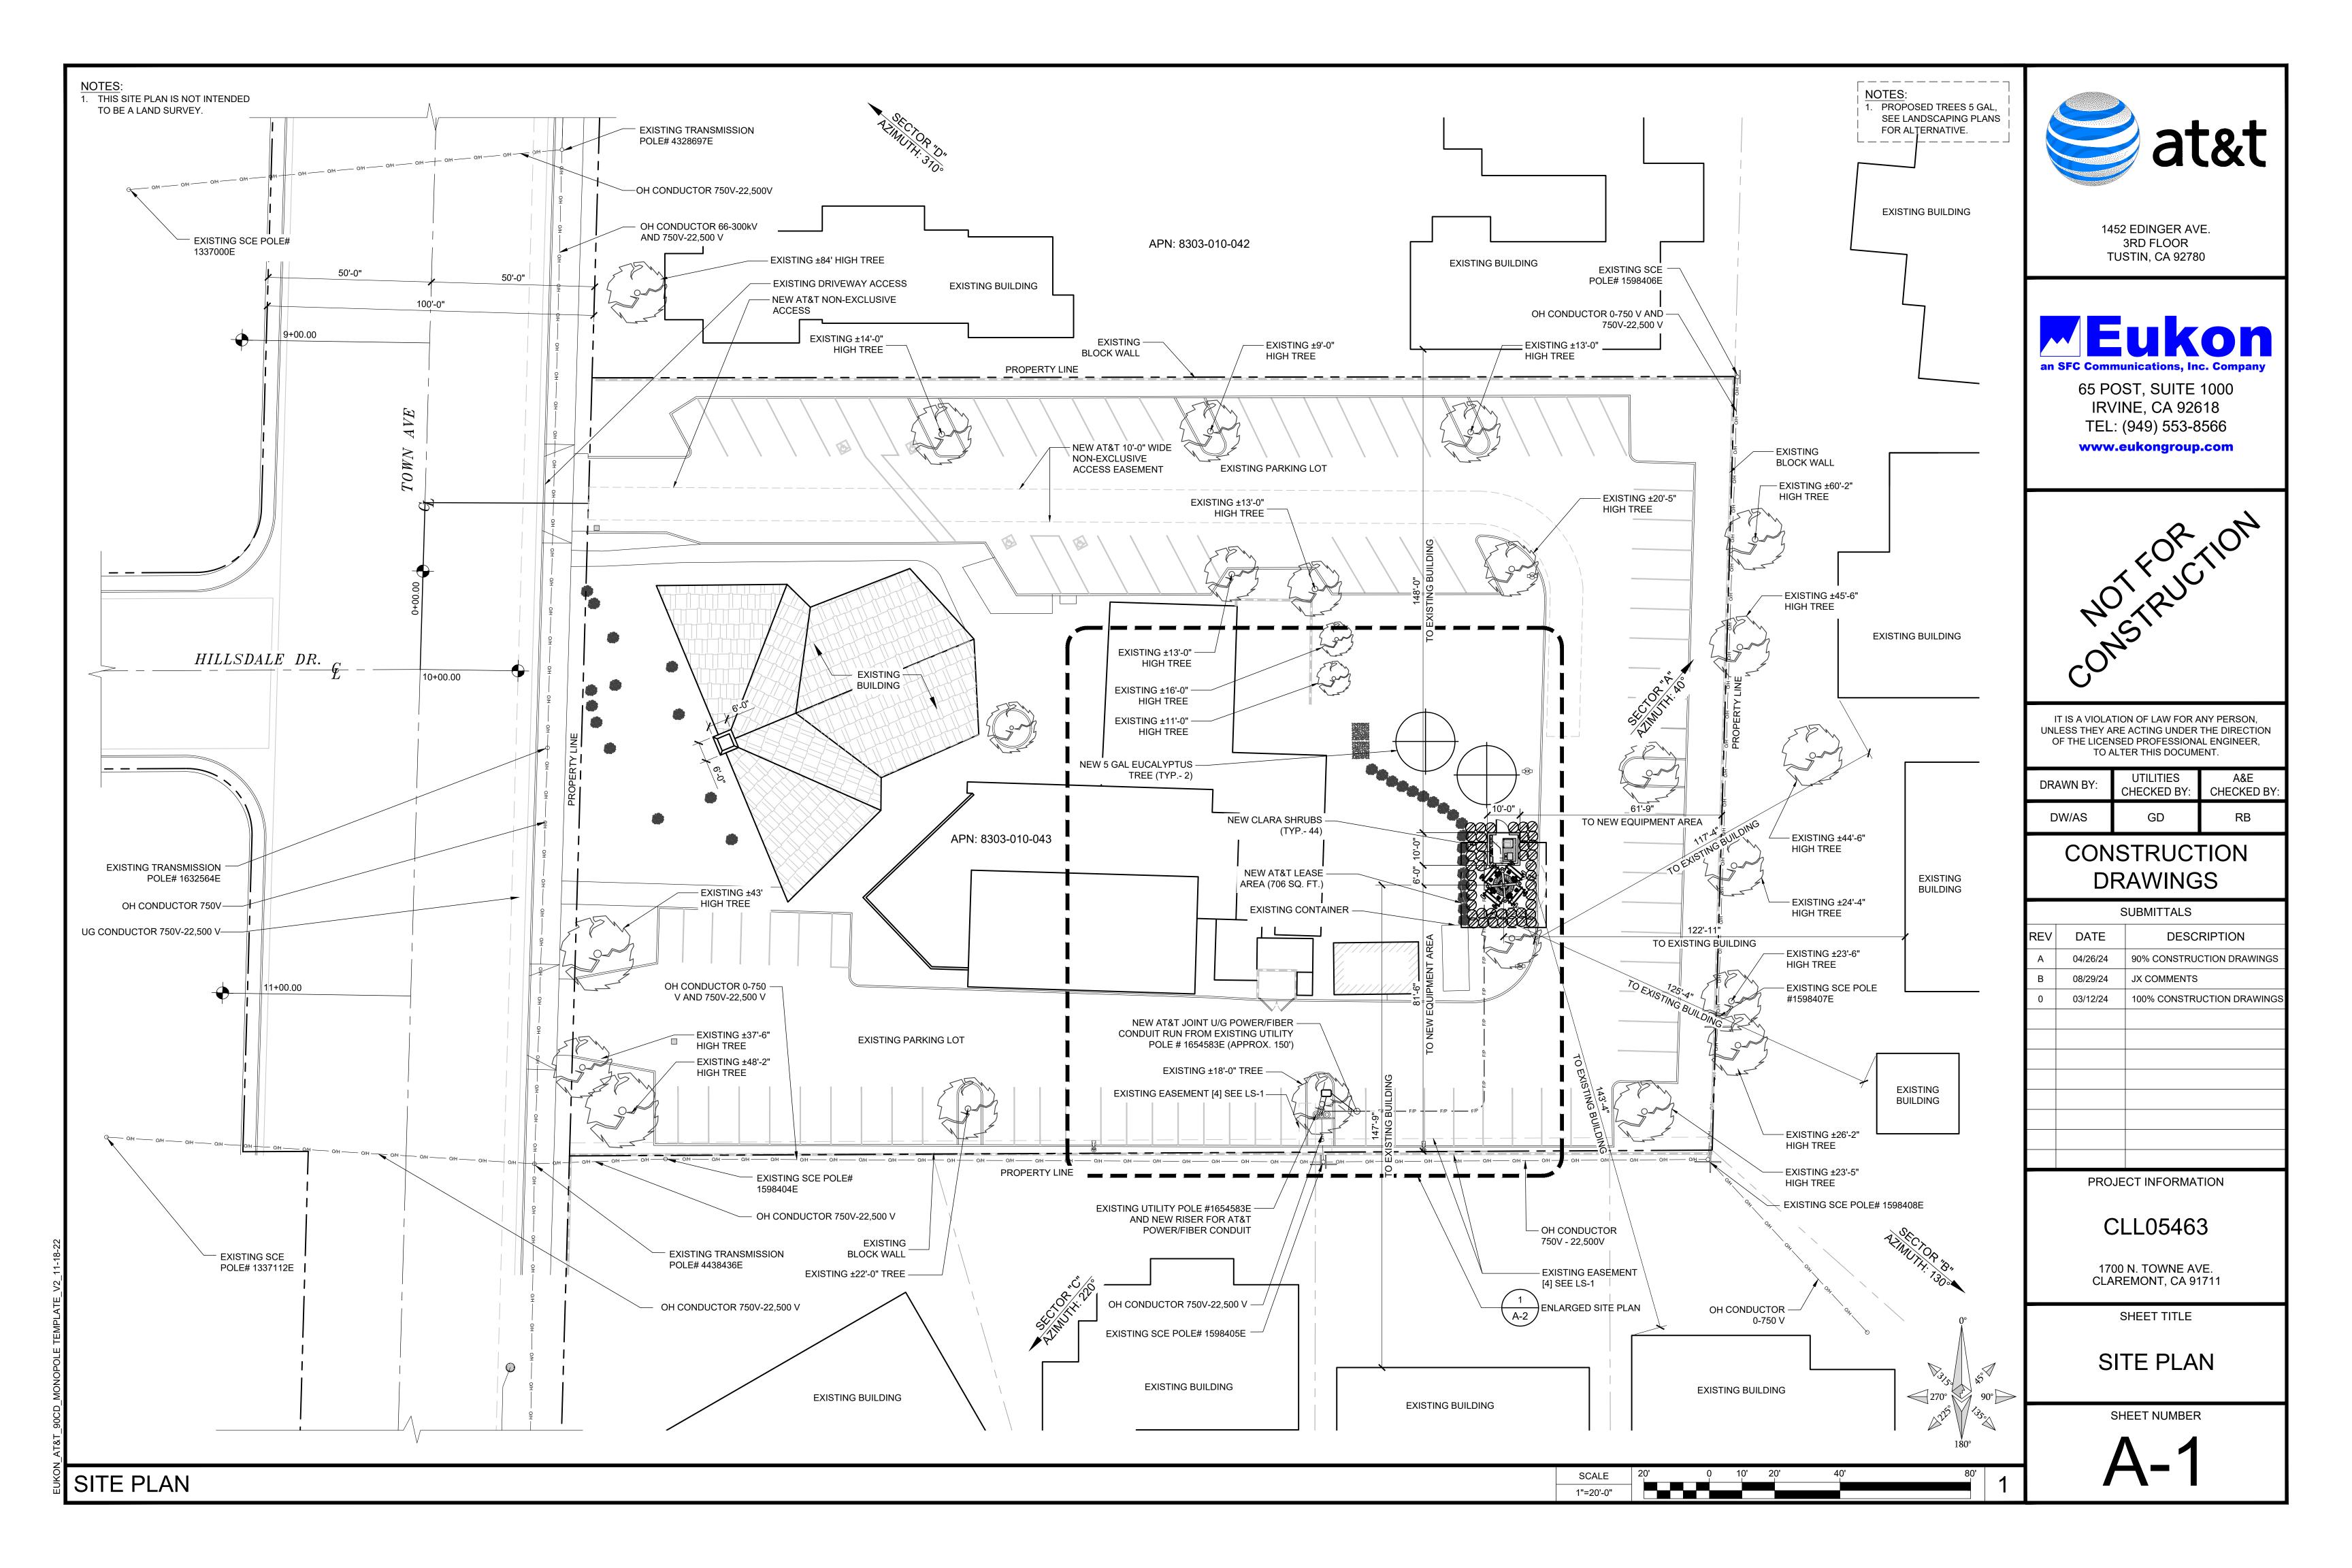

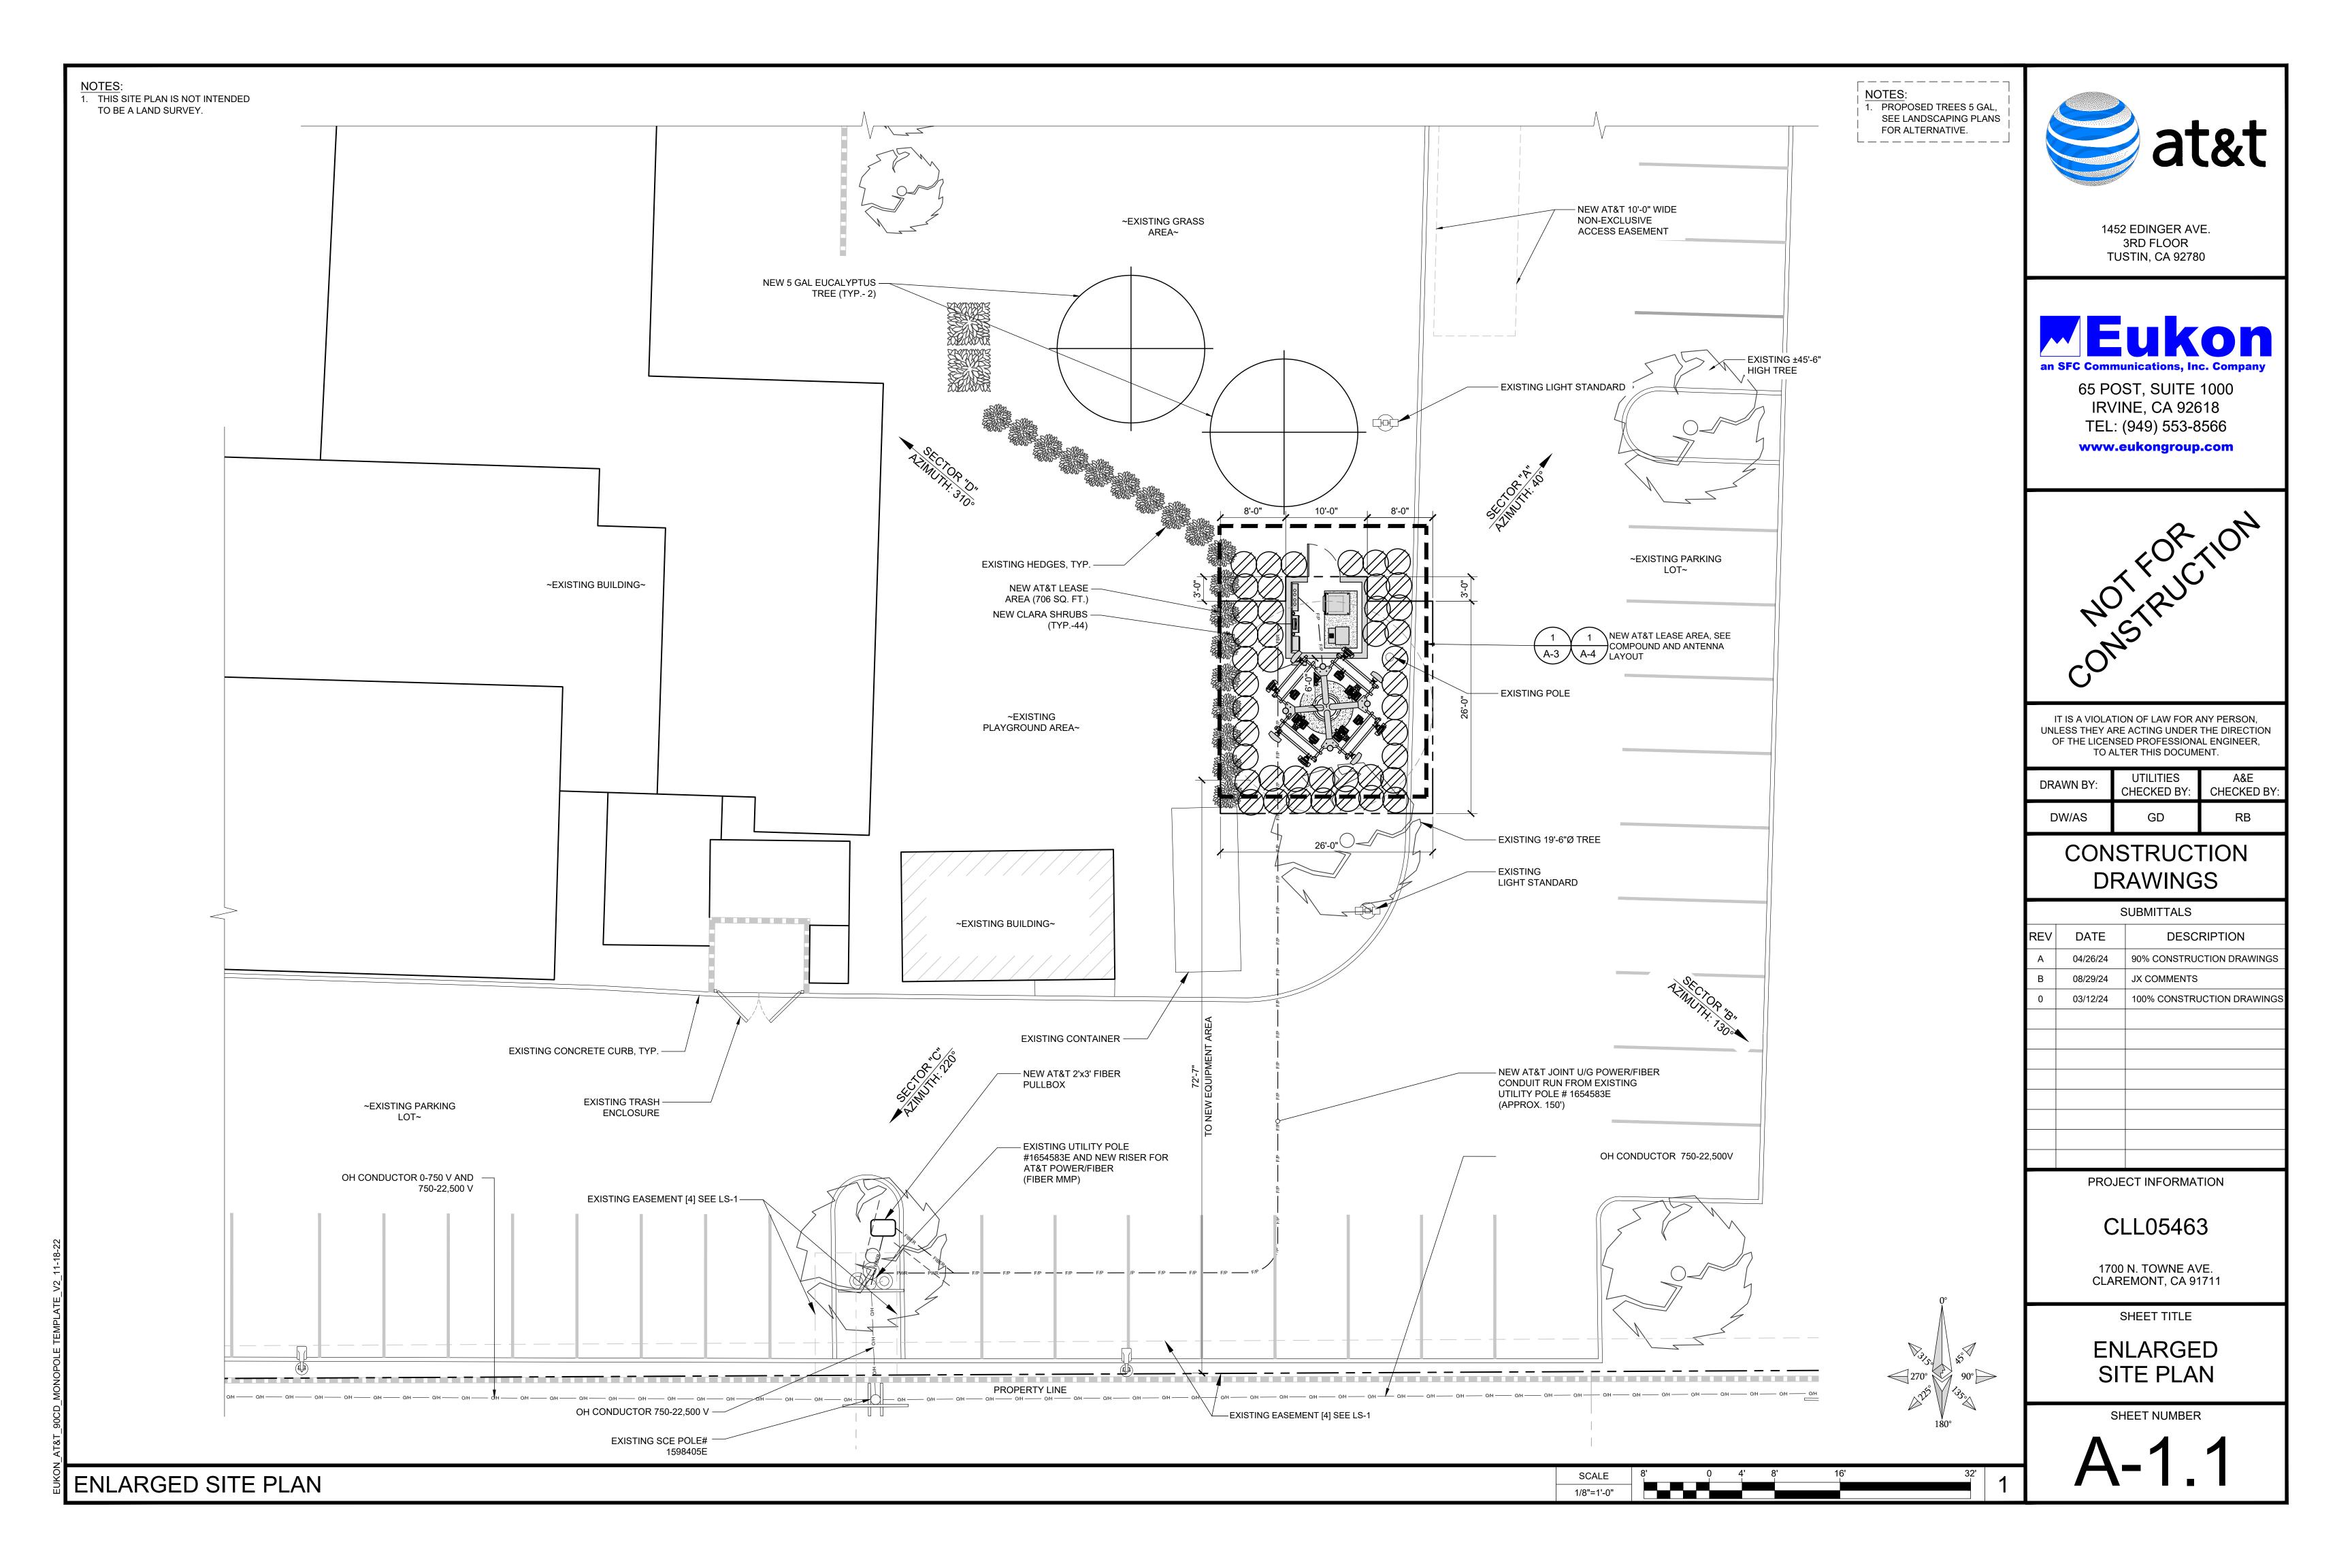

NOTES:

1. PROPOSED TREES 5 GAL,
SEE LANDSCAPING PLANS
FOR ALTERNATIVE.



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DW/AS	GD	RB	

CONSTRUCTION DRAWINGS

	SUBMITTALS			
R	EV	DATE	DESCRIPTION	
	Α	04/26/24	90% CONSTRUCTION DRAWINGS	
	В	08/29/24	JX COMMENTS	
	0	03/12/24	100% CONSTRUCTION DRAWINGS	

PROJECT INFORMATION

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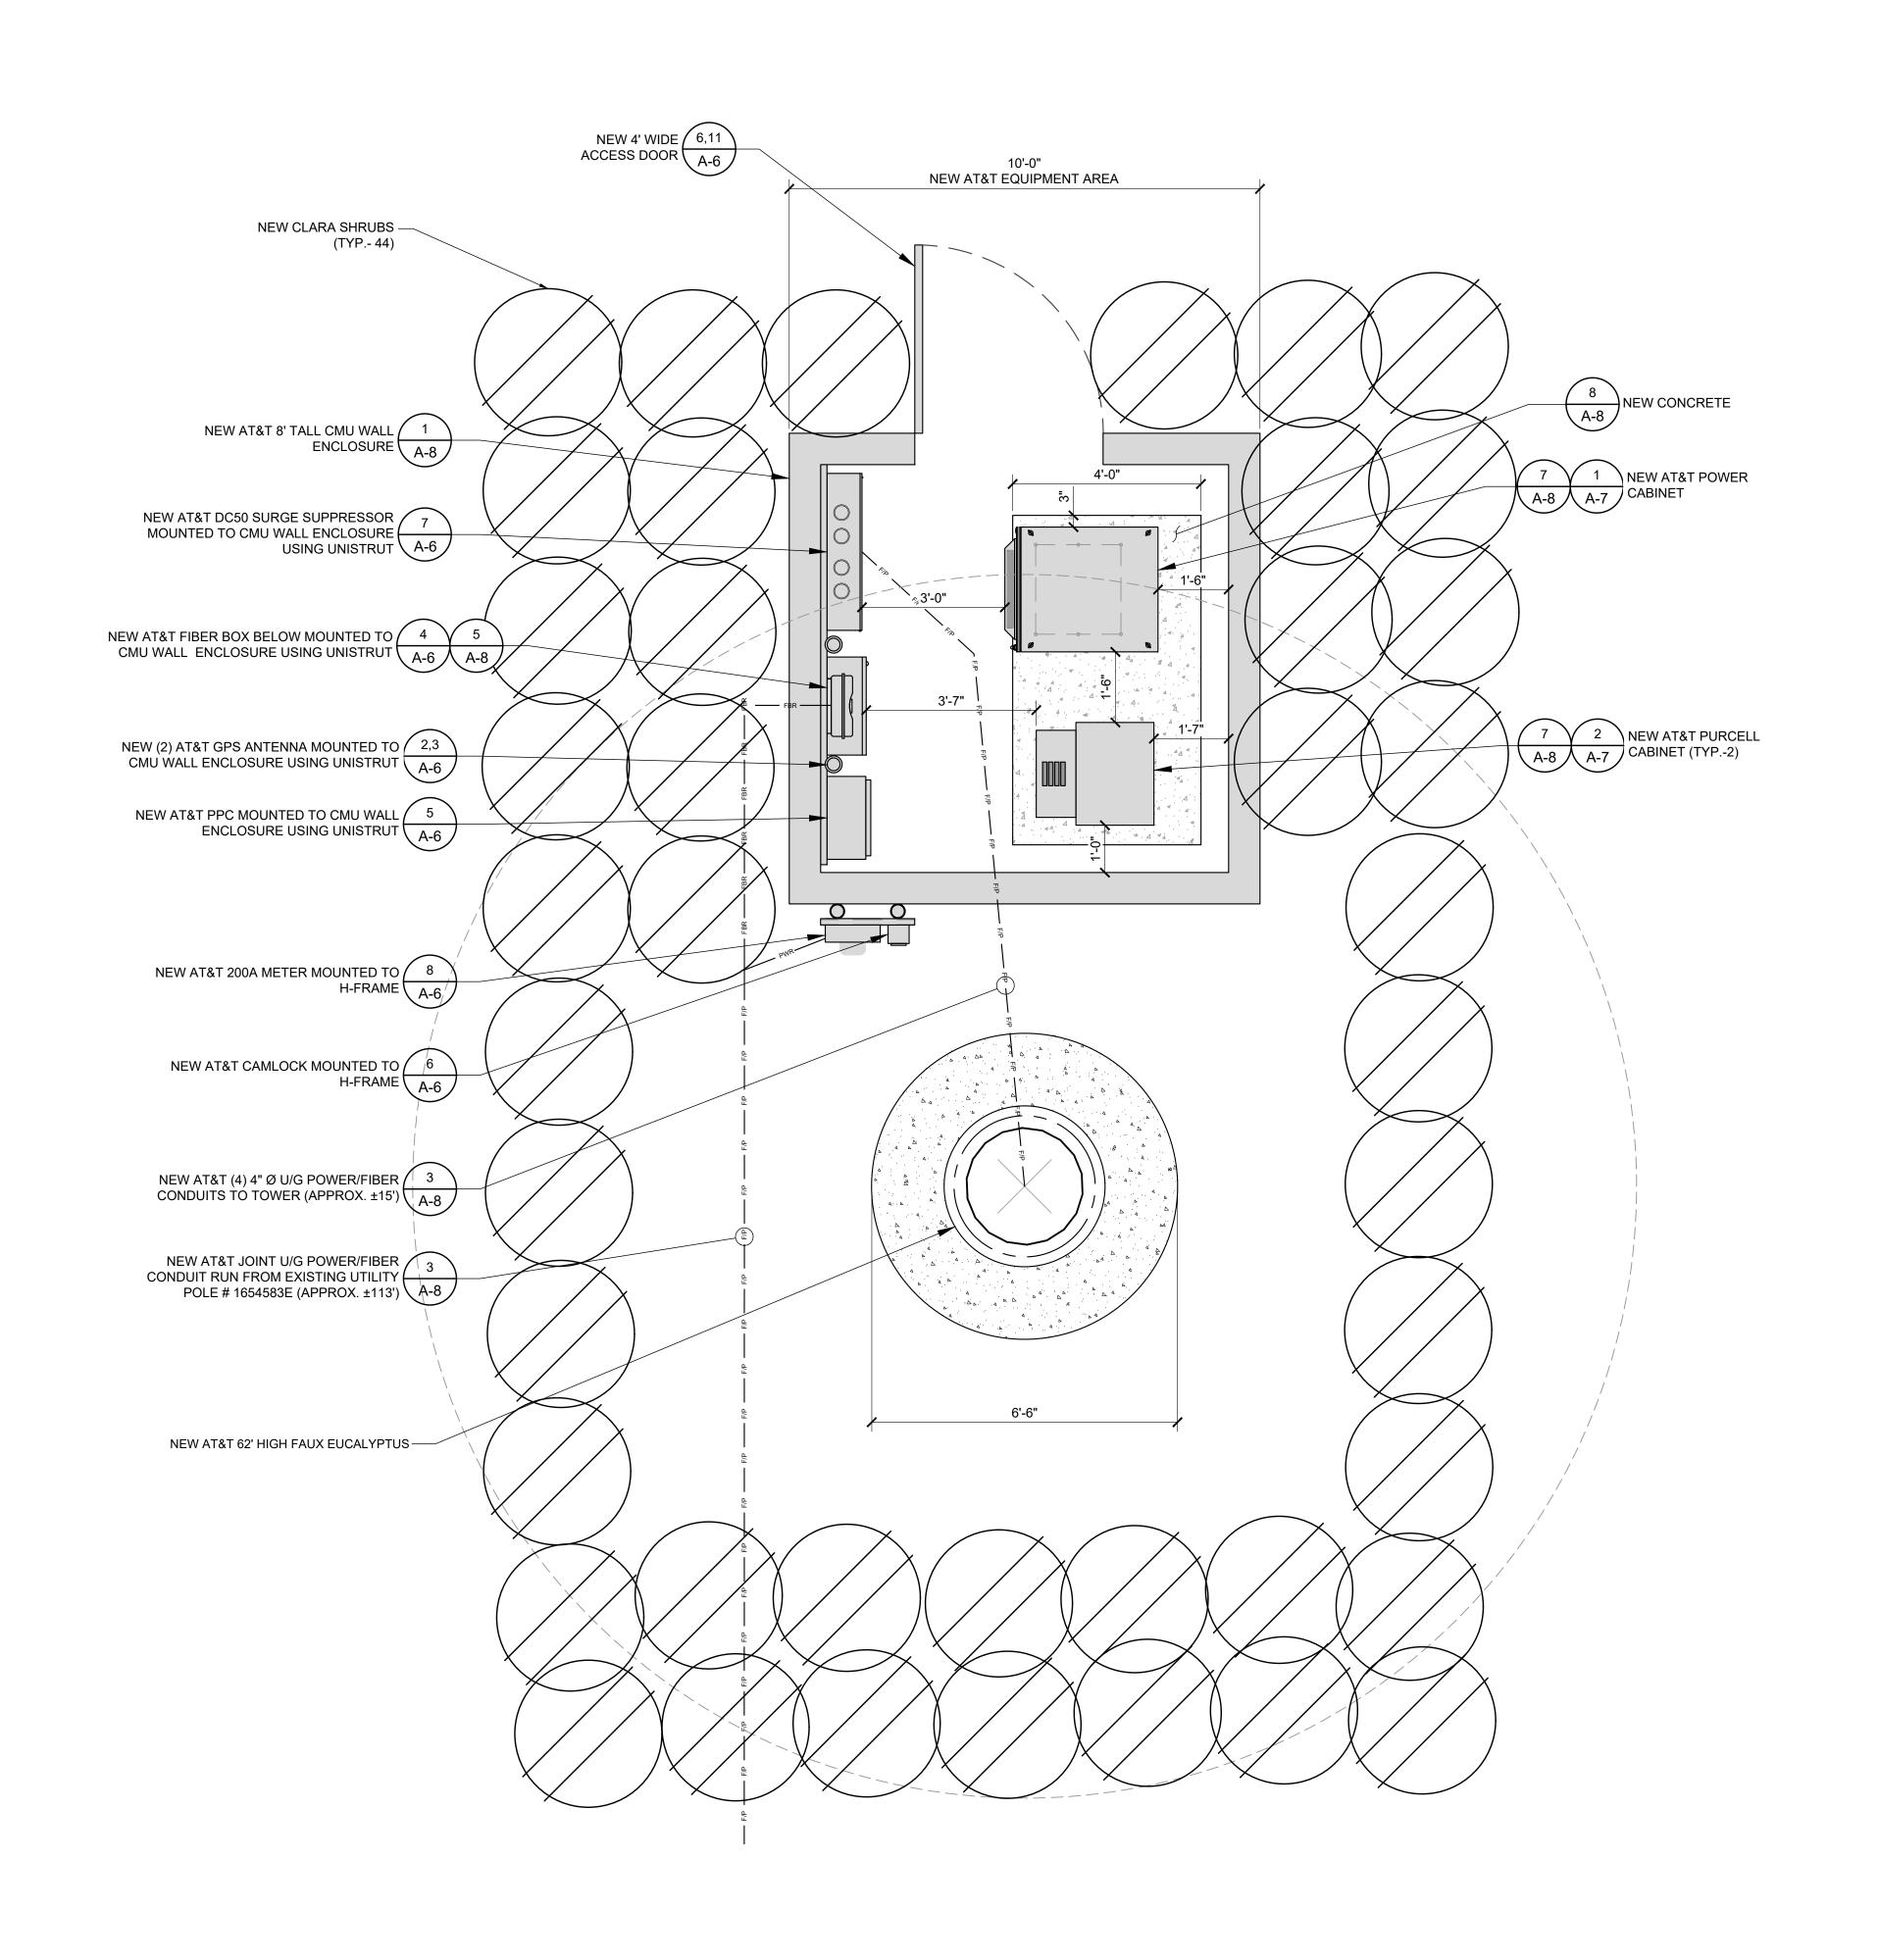
1700 N. TOWNE AVE. CLAREMONT, CA 91711

SHEET TITLE

EQUIPMENT PLAN

SHEET NUMBER

A-2



270° 90° [

EQUIPMENT PLAN

SCALE



<u>8</u> 1

	SECTOR TECHNOLOGY ANTENNA MODEL			ANTENNA SIZE	ANTENNA	RAD CENTER	TRANSMISSION CABLE	
	SECTOR	TECHNOLOGY	ANTENNA MODEL	ANTENNA SIZE	AZIMUTH	RAD CENTER	LENGTH	
°	A1	LTE	CCI TPA-45R-KU8AA-K	8'-0"	40°	53'-0"		
SECTOR	A2	C-BAND	ERICSSON AIR6419 B77D	2'-7"	40°	55'-9"	±75'	1 FIBER
ALPHA SE	AZ	C-BAND	ERICSSON AIR6419 B77G	2'-7"	40°	51'-8"		+ 3 DC
	А3	LTE	CCI TPA-45R-KU8AA-K	8'-0"	40°	42'-0"	±65'	POWER
	A4	LTE	CCI TPA-45R-KU8AA-K	8'-0"	40°	42'-0"	103	
SECTOR	B1	C-BAND	ERICSSON AIR6449 B77D	2'-7"	130°	55'-9"		
		C-BAND	ERICSSON AIR6419 B77G	2'-7"	130°	51'-8"	±75'	1 FIBER
	B2	LTE	CCI TPA-45R-KU8AA-K	8'-0"	130°	53'-0"		+ 3 DC
BETA	В3	LTE	CCI TPA-45R-KU8AA-K	8'-0"	130°	42'-0"		POWER
"	B4	LTE	CCI TPA-45R-KU8AA-K	8'-0"	130°	42'-0"		
<u>~</u>	C1	LTE	CCI TPA-45R-KU8AA-K	8'-0"	220°	53'-0"		
SECTOR	00	C-BAND	ERICSSON AIR6449 B77D	2'-7"	220°	55'-9"	±75'	1 FIBER
	C2	C-BAND	ERICSSON AIR6419 B77G	2'-7"	220°	51'-8"		+ 3 DC
GAMMA	C3	LTE	CCI TPA-45R-KU8AA-K	8'-0"	220°	42'-0"	I GE!	POWER
, O	C4	LTE	CCI TPA-45R-KU8AA-K	8'-0"	220°	42'-0"	– ±65'	
~	D4	C-BAND	ERICSSON AIR6449 B77D	2'-7"	310°	55'-9"		
SECTOR	D1	C-BAND	ERICSSON AIR6419 B77G	2'-7"	310°	51'-8"	±75'	1 FIBER
	D2	LTE	CCI TPA-45R-KU8AA-K	8'-0"	310°	53'-0"		+ 3 DC
DELTA	D3	LTE	CCI TPA-45R-KU8AA-K	8'-0"	310°	42'-0"	.051	POWER
	D4	LTE	CCI TPA-45R-KU8AA-K	8'-0"	310°	42'-0"	_ ±65'	


	REMOTE RADIO UNIT SCHEDULE						
	SECTOR	RRU TYPE	RRU LOCATION (DISTANCE FROM	MINIMUI	MINIMUM CLEARANCES		
	020101	14.0 111 2	ANTENNA)	ABOVE	BELOW	SIDES	
	A1	ERICSSON RRU 4490 B5/B12A	±10'	16"	8"	0"	
쏬	A1	ERICSSON RRU 4890 B25/B66	±10'	16"	8"	0"	
SECTOR	A2	-	-	-	-	-	
) SEC	A2	-	-	-	-	-	
	A3	-	-	-	-	-	
ALPHA	A3	ERICSSON RRU 4494 B14/B29	±10'	16"	8"	0"	
₹	A4	-	-	-	-	-	
	A4	-	-	-	-	-	
	B1	-	-	-	-	-	
ద	B1	-	-	-	-	-	
E	B2	ERICSSON RRU 4490 B5/B12A	±10'	16"	8"	0"	
SECTOR	B2	ERICSSON RRU 4890 B25/B66	±10'	16"	8"	0"	
BETA 8	В3	-	-	-	-	-	
	В3	-	-	-	-	-	
	B4	-	-	-	-	-	
	B4	ERICSSON RRU 4494 B14/B29	±10'	16"	8"	0"	
	C1	ERICSSON RRU 4490 B5/B12A	±10'	16"	8"	0"	
A.	C1	ERICSSON RRU 4890 B25/B66	±10'	16"	8"	0"	
ECTOR	C2	-	-	-	-	-	
SE	C2	-	-	-	-	-	
₹	C3	-	-	-	-	-	
GAMMA	C3	ERICSSON RRU 4494 B14/B29	±10'	16"	8"	0"	
Ď	C4	-	-	-	-	-	
	C4	-	-	-	-	-	
	D1	-	-	-	-	-	
SECTOR	D1	-	-	-	-	-	
	D2	ERICSSON RRU 4490 B5/B12A	±10'	16"	8"	0"	
)E(D2	ERICSSON RRU 4890 B25/B66	±10'	16"	8"	0"	
	D3	-	-	-	-	-	
DELTA	D3	-	-	-	_	-	
	D4	<u>-</u>		-	_	-	
	D4	ERICSSON RRU 4494 B14/B29	±10'	16"	8"	0"	

	SURGE SUPPRESSION SYSTEM			
:M	MANUFACTURER	PART NUMBER	QTY	LOCATION
/STE	RAYCAP	DC50-48-60-96-50F	1	MOUNTED INSIDE CMU WALL ENCLOSURE
Ś	RAYCAP	DC9-48-60-24-8C-EV	4	MOUNTED AT FAUX EUCALYPTUS TOWER

- CONTRACTOR IS TO REFER TO AT&T'S MOST **CURRENT RADIO** FREQUENCY DATA SHEET (RFDS) PRIOR TO CONSTRUCTION.
- 2. CABLE LENGTHS WERE DETERMINED BASED ON A VISUAL INSPECTION DURING SITE WALK. CONTRACTOR TO VERIFY ACTUAL LENGTH DURING PRE-CONSTRUCTION WALK.
- 3. CONTRACTOR TO USE ROSENBERGER FIBER LINE HANGER COMPONENTS (OR **ENGINEER APPROVED** EQUAL).
- CABLES SPECIFIED (OR ENGINEER APPROVED EQUAL).

NOTES TO CONTRACTOR

- 4. CONTRACTOR TO USE

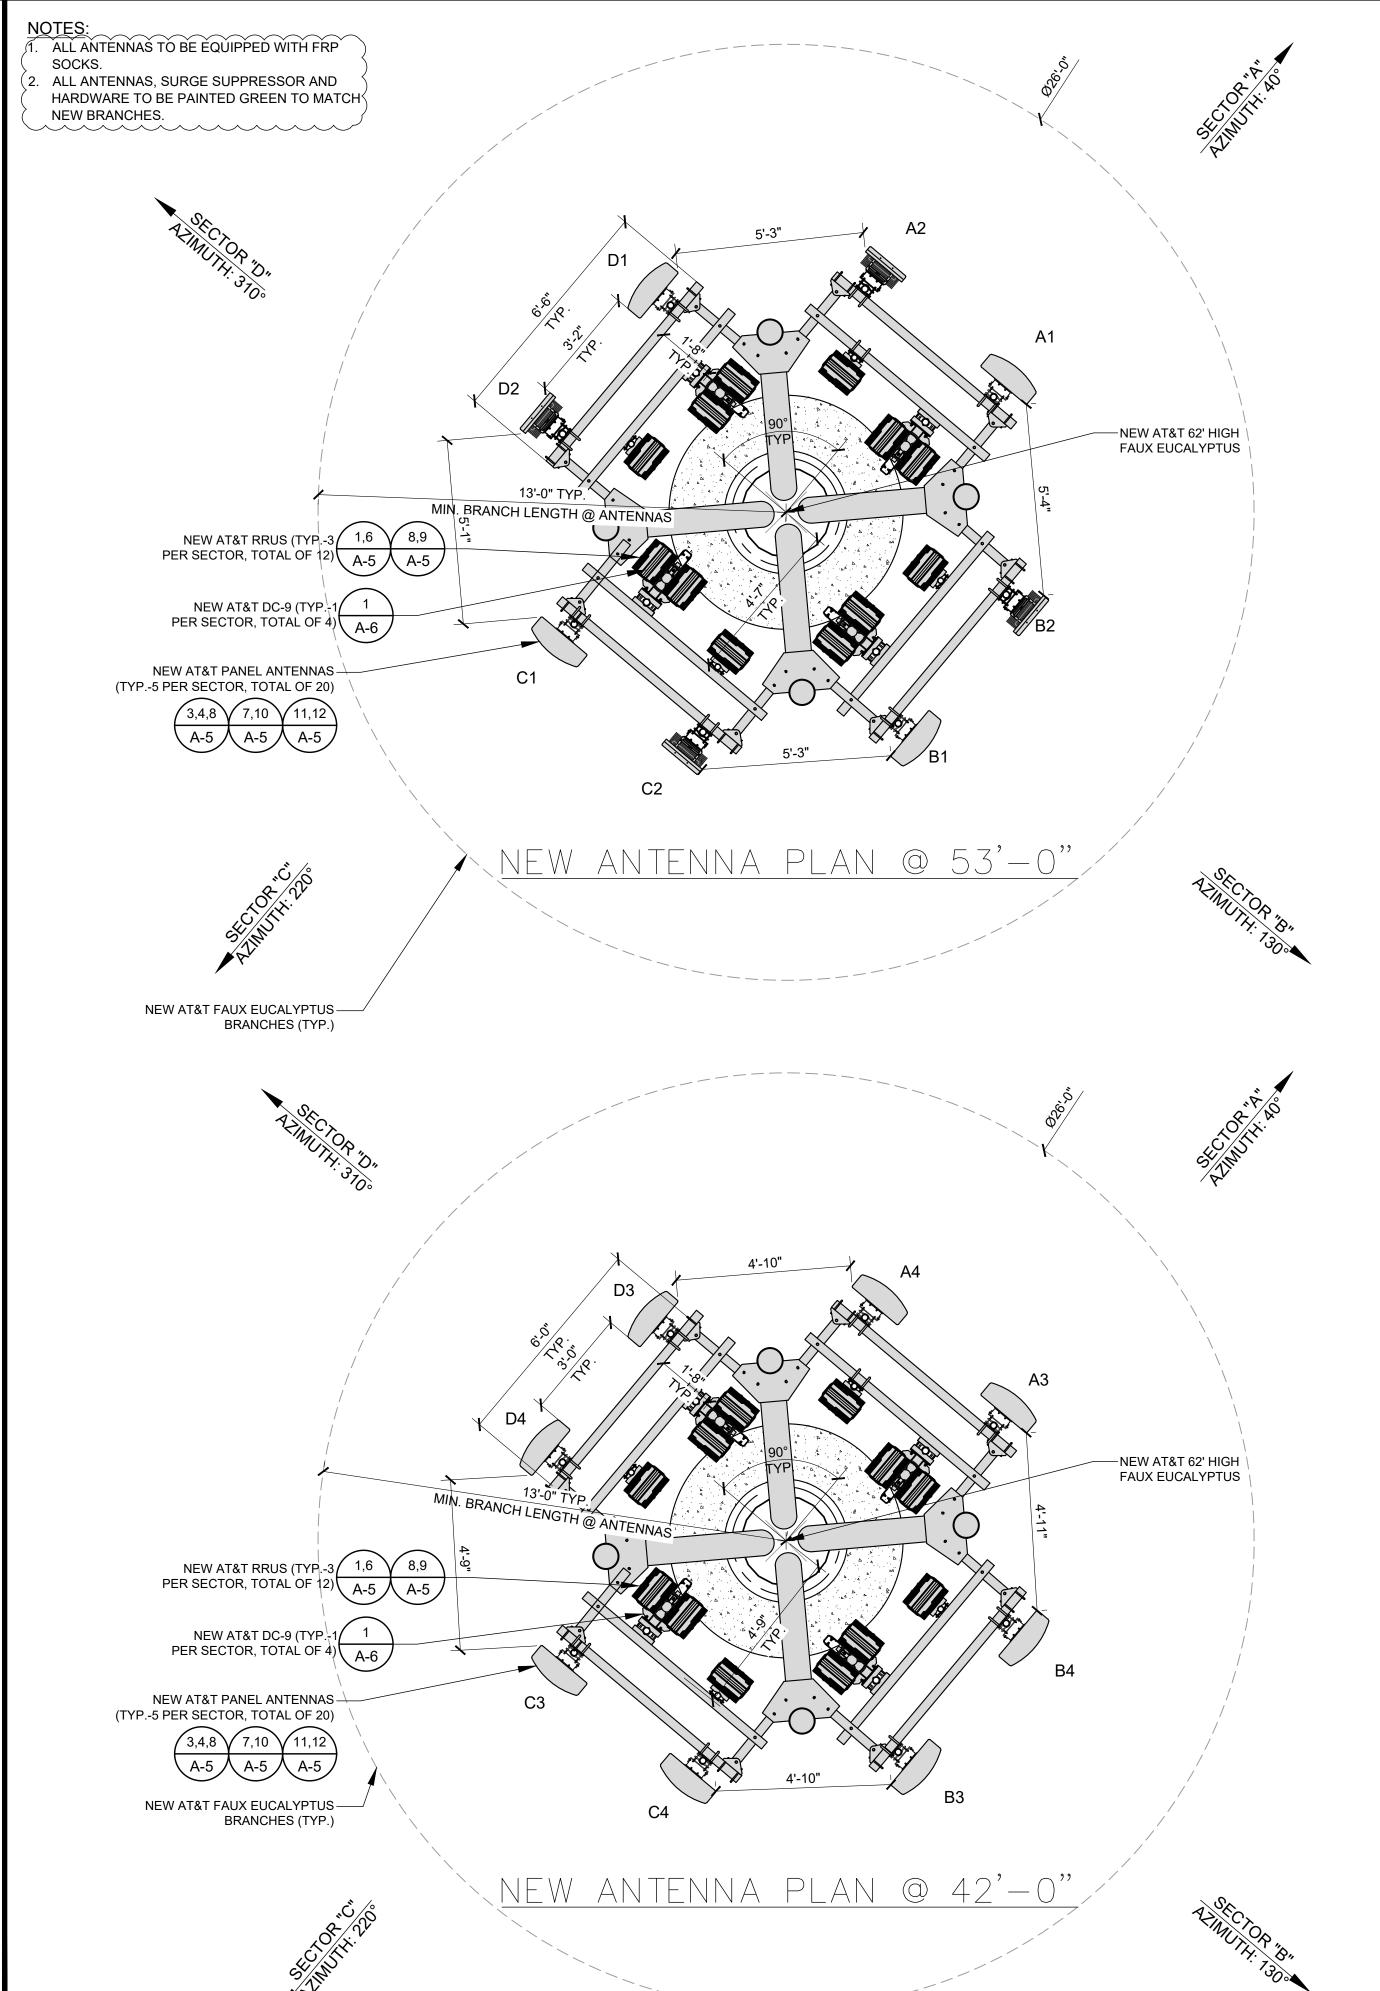



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DW/AS	GD	RB

CONSTRUCTION DRAWINGS

	S	SUBMITTALS
REV	DATE	DESCRIPTION
Α	04/26/24	90% CONSTRUCTION DRAWINGS
В	08/29/24	JX COMMENTS
0	03/12/24	100% CONSTRUCTION DRAWINGS

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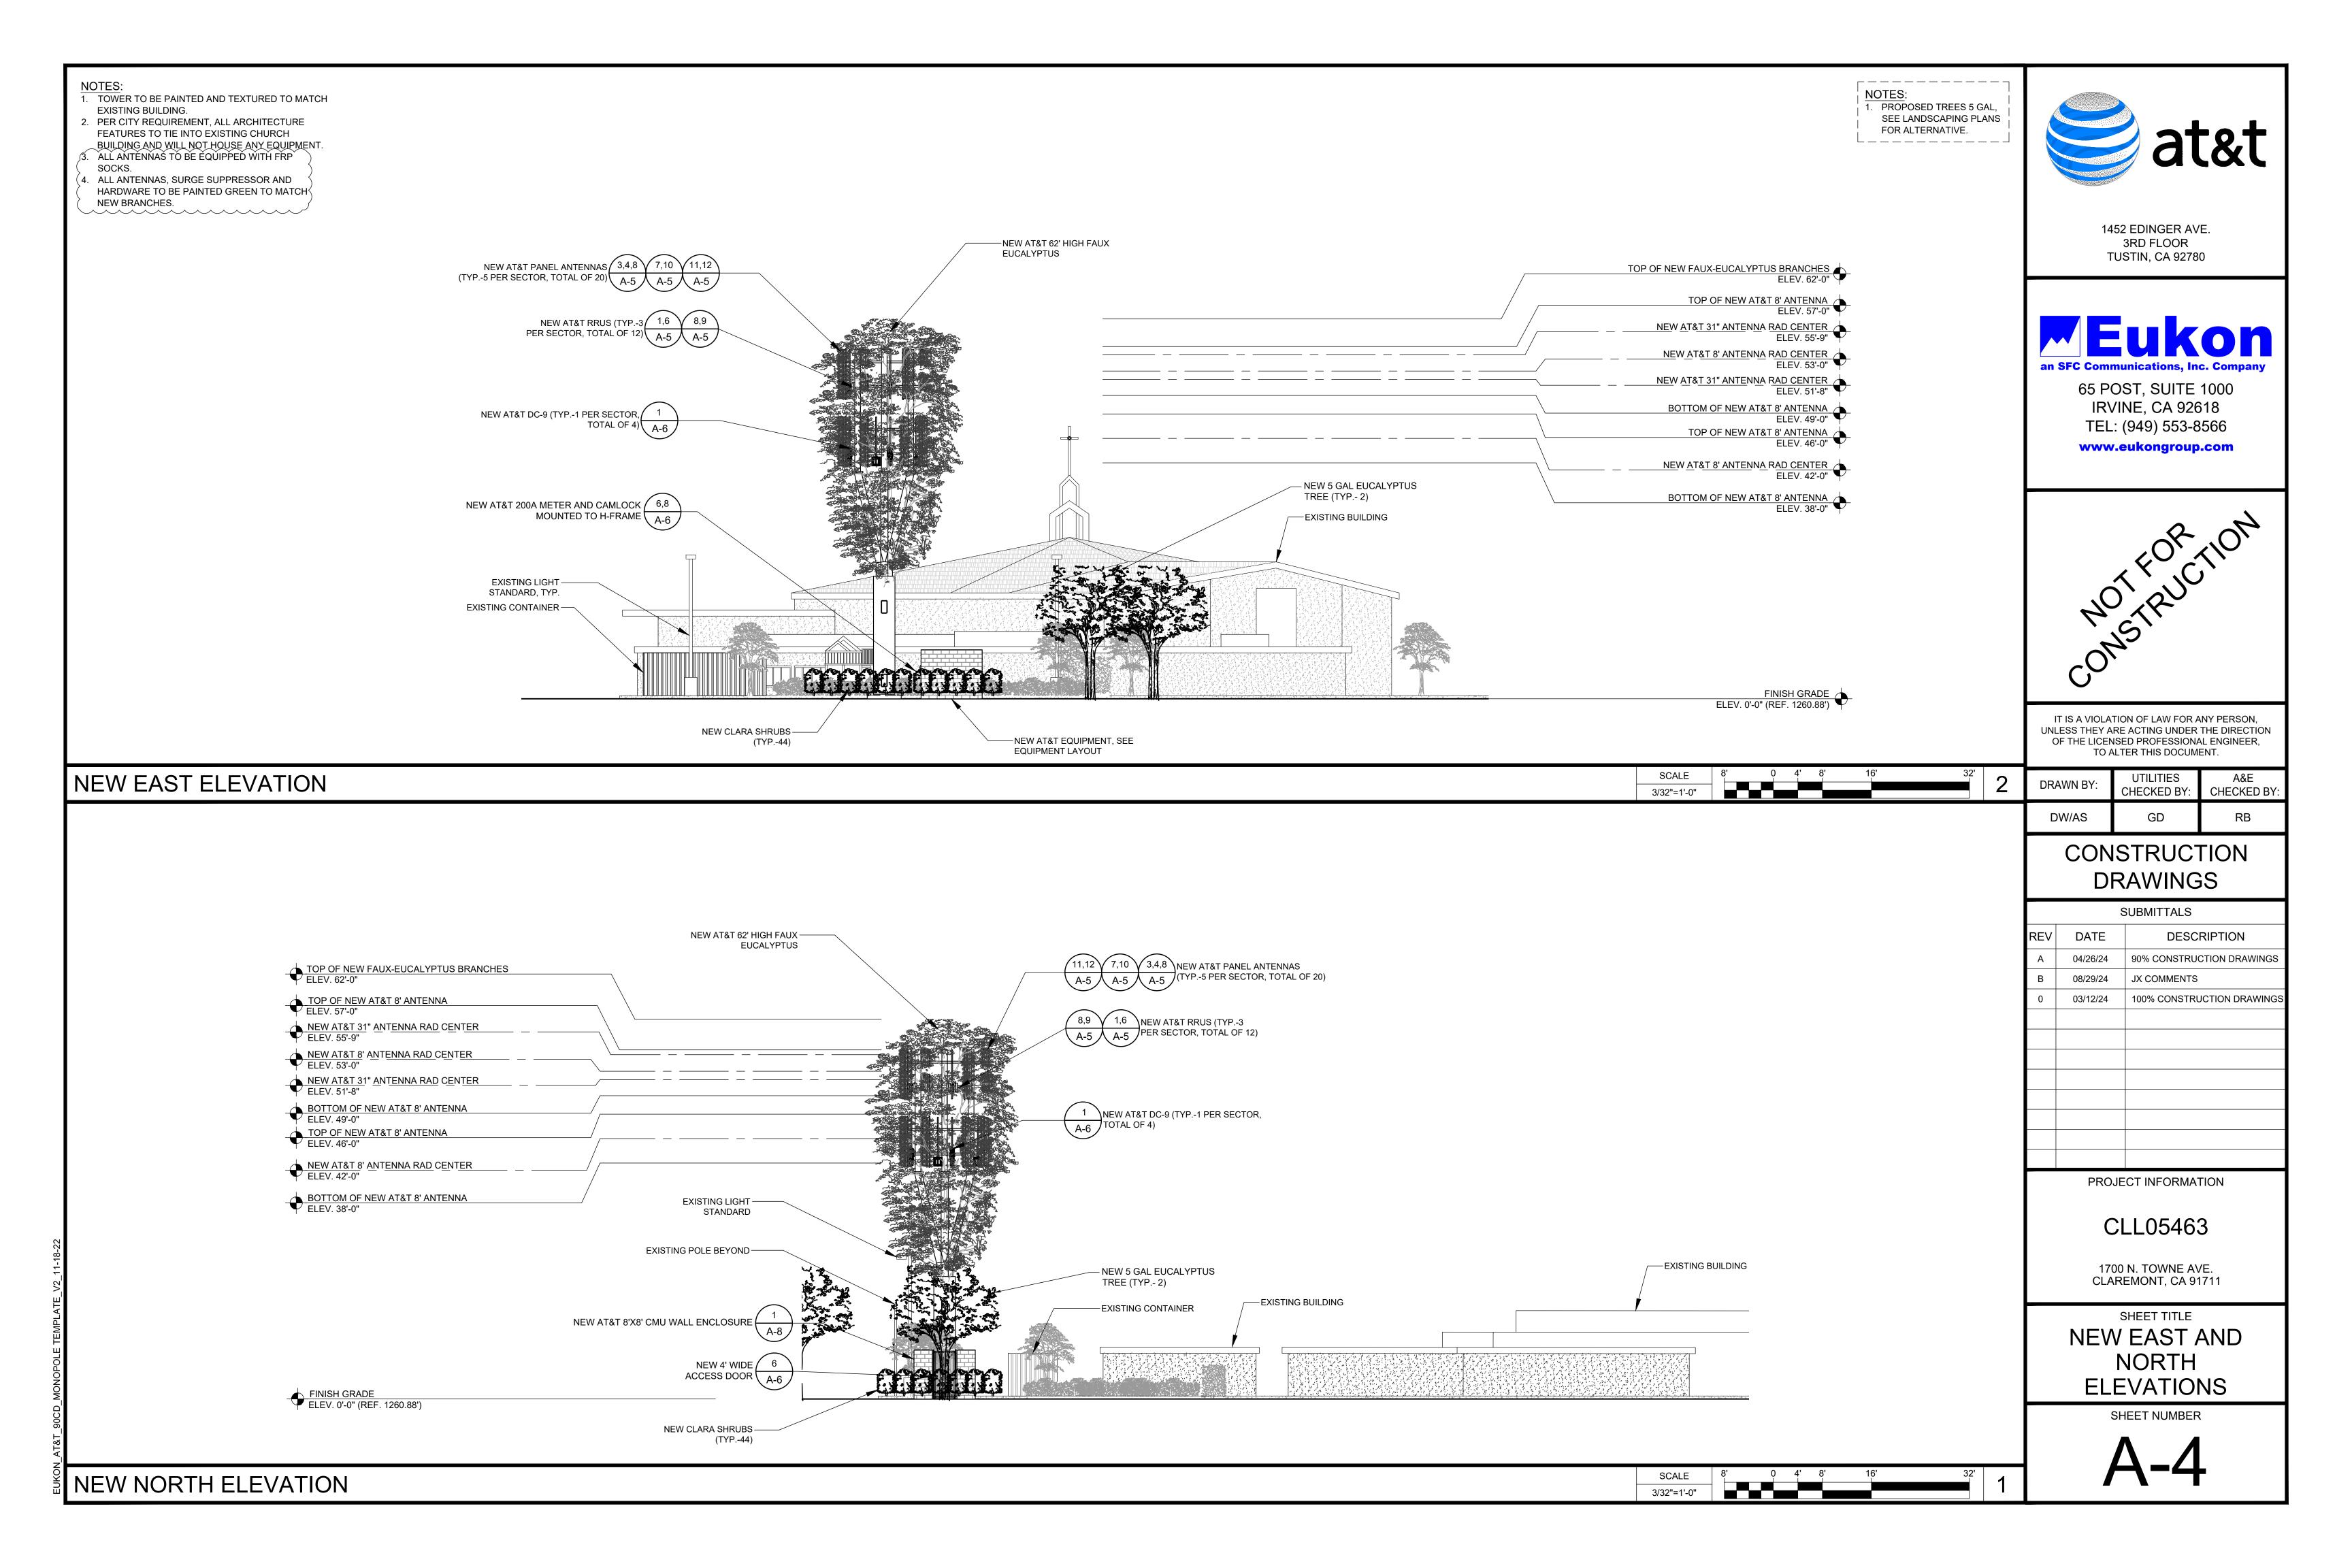
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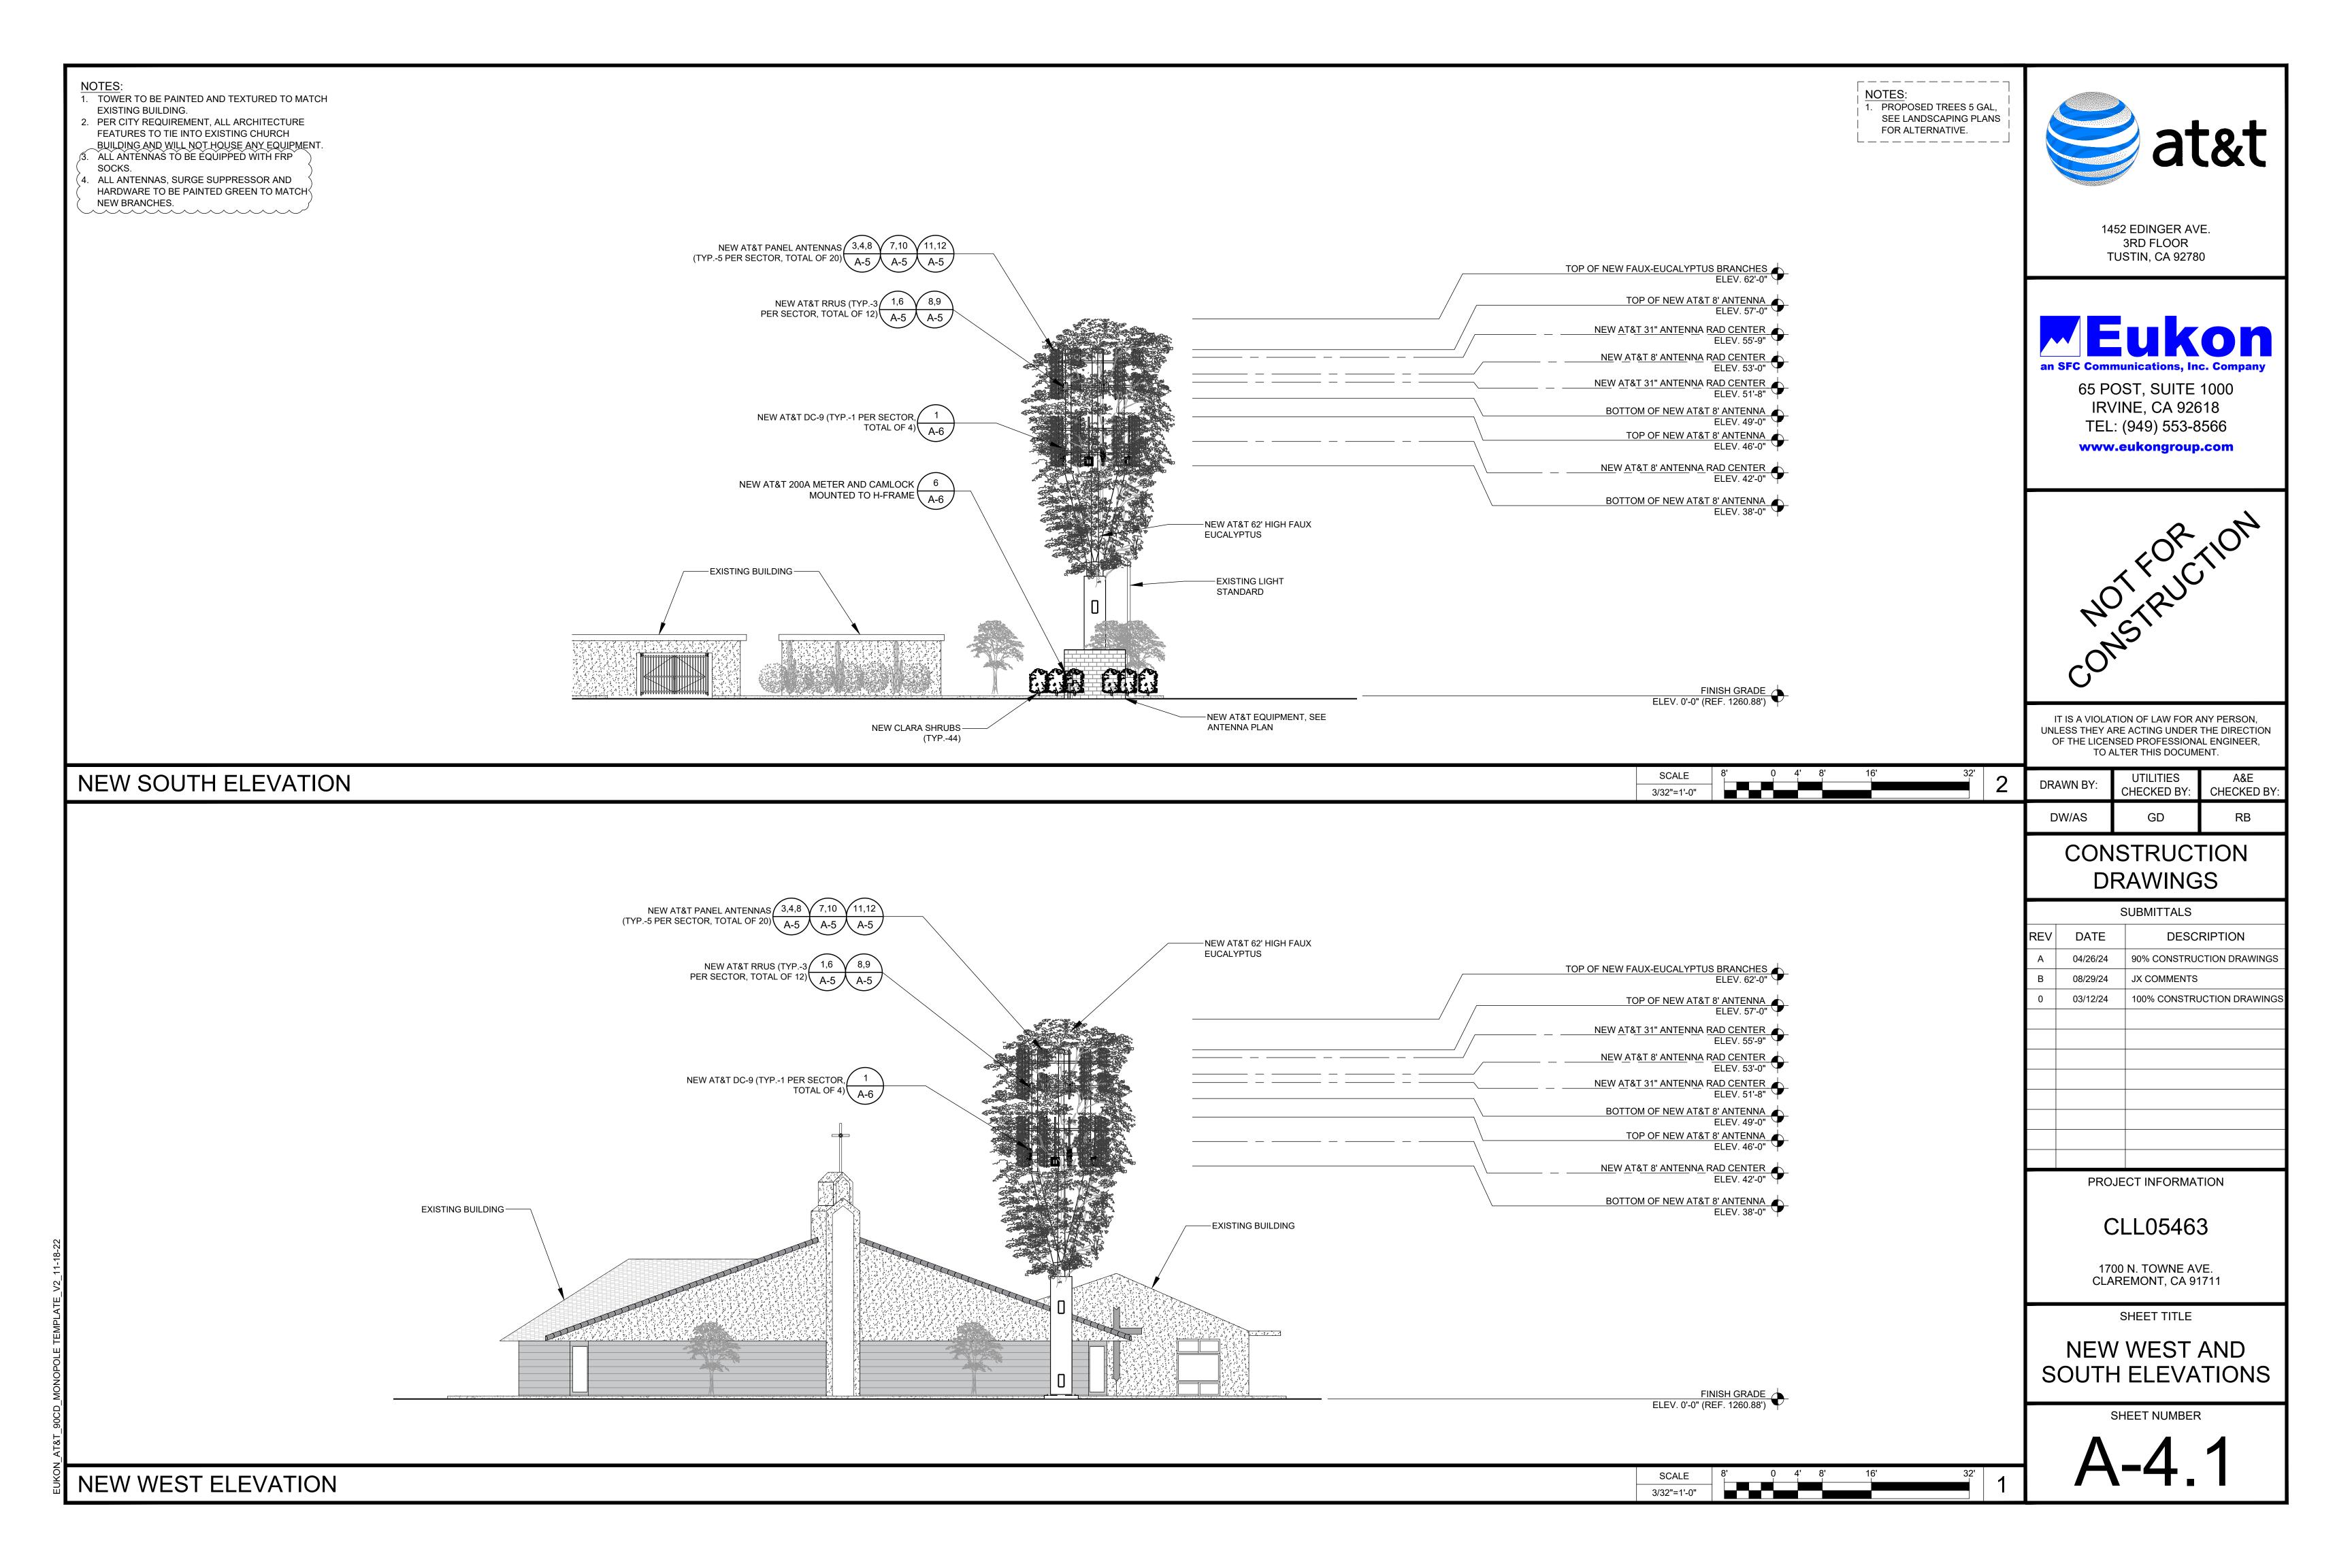
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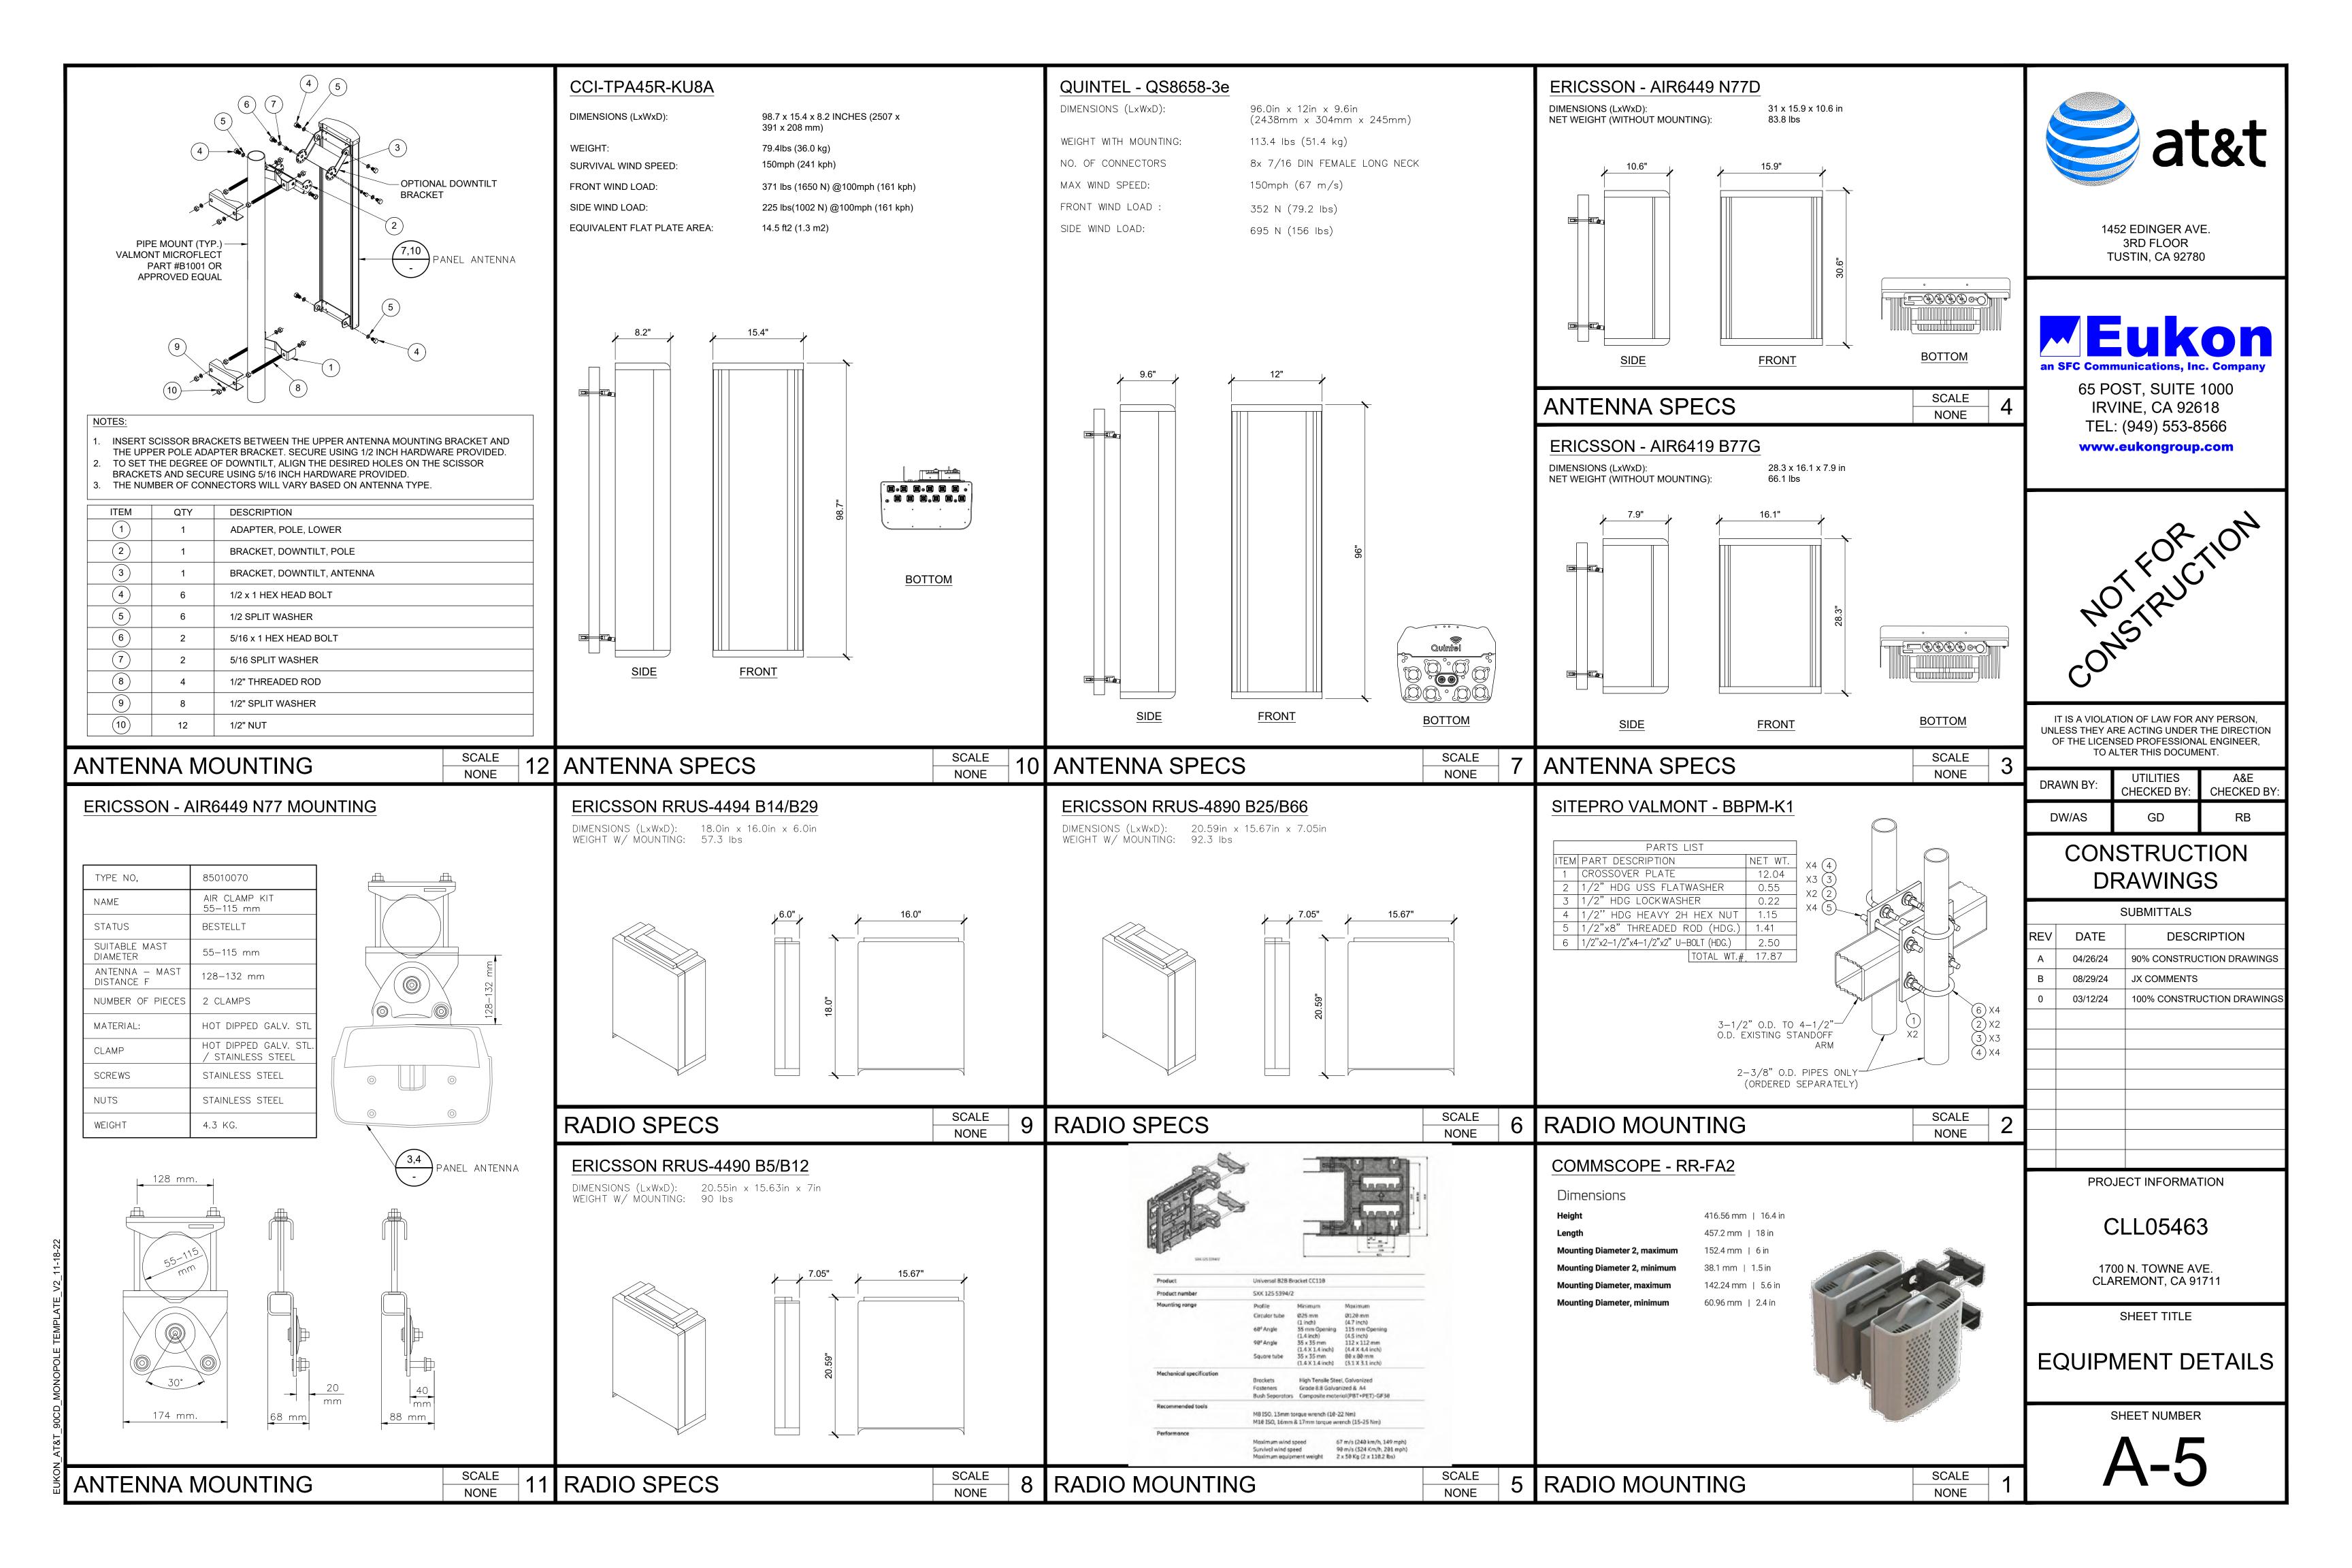
ANTENNA PLAN AND RRU SCHEDULE


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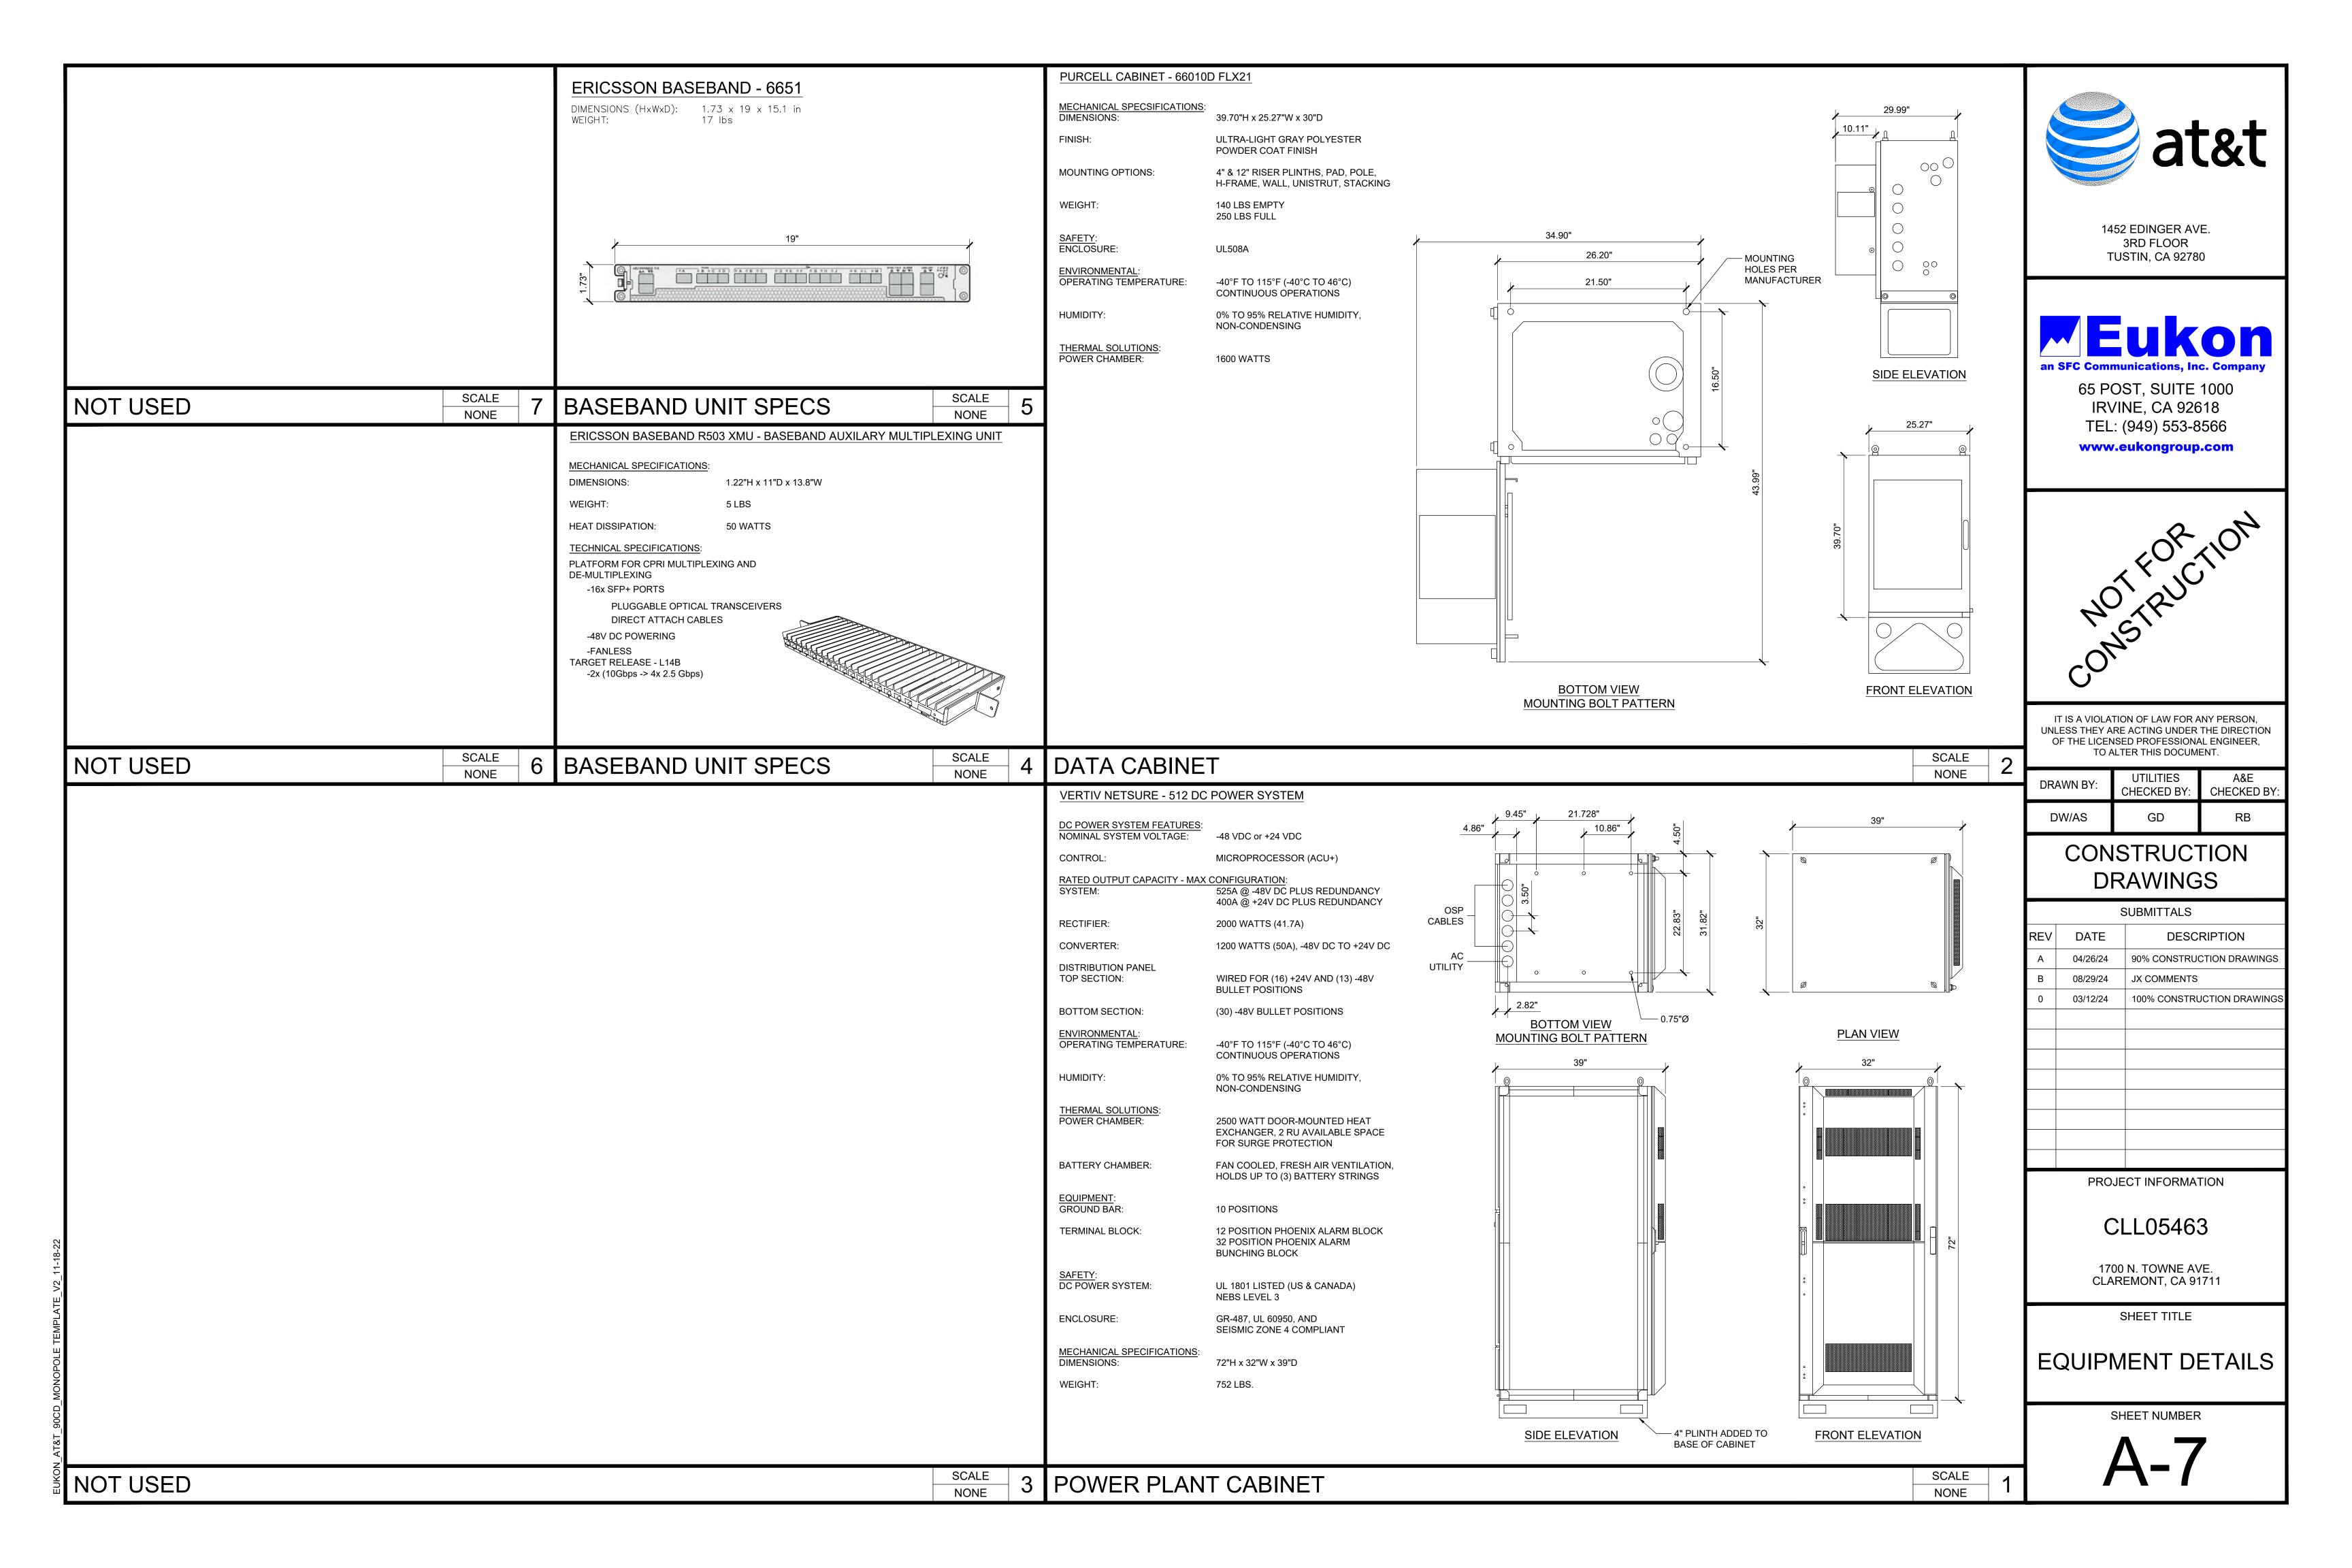
2 ANTENNA PLAN










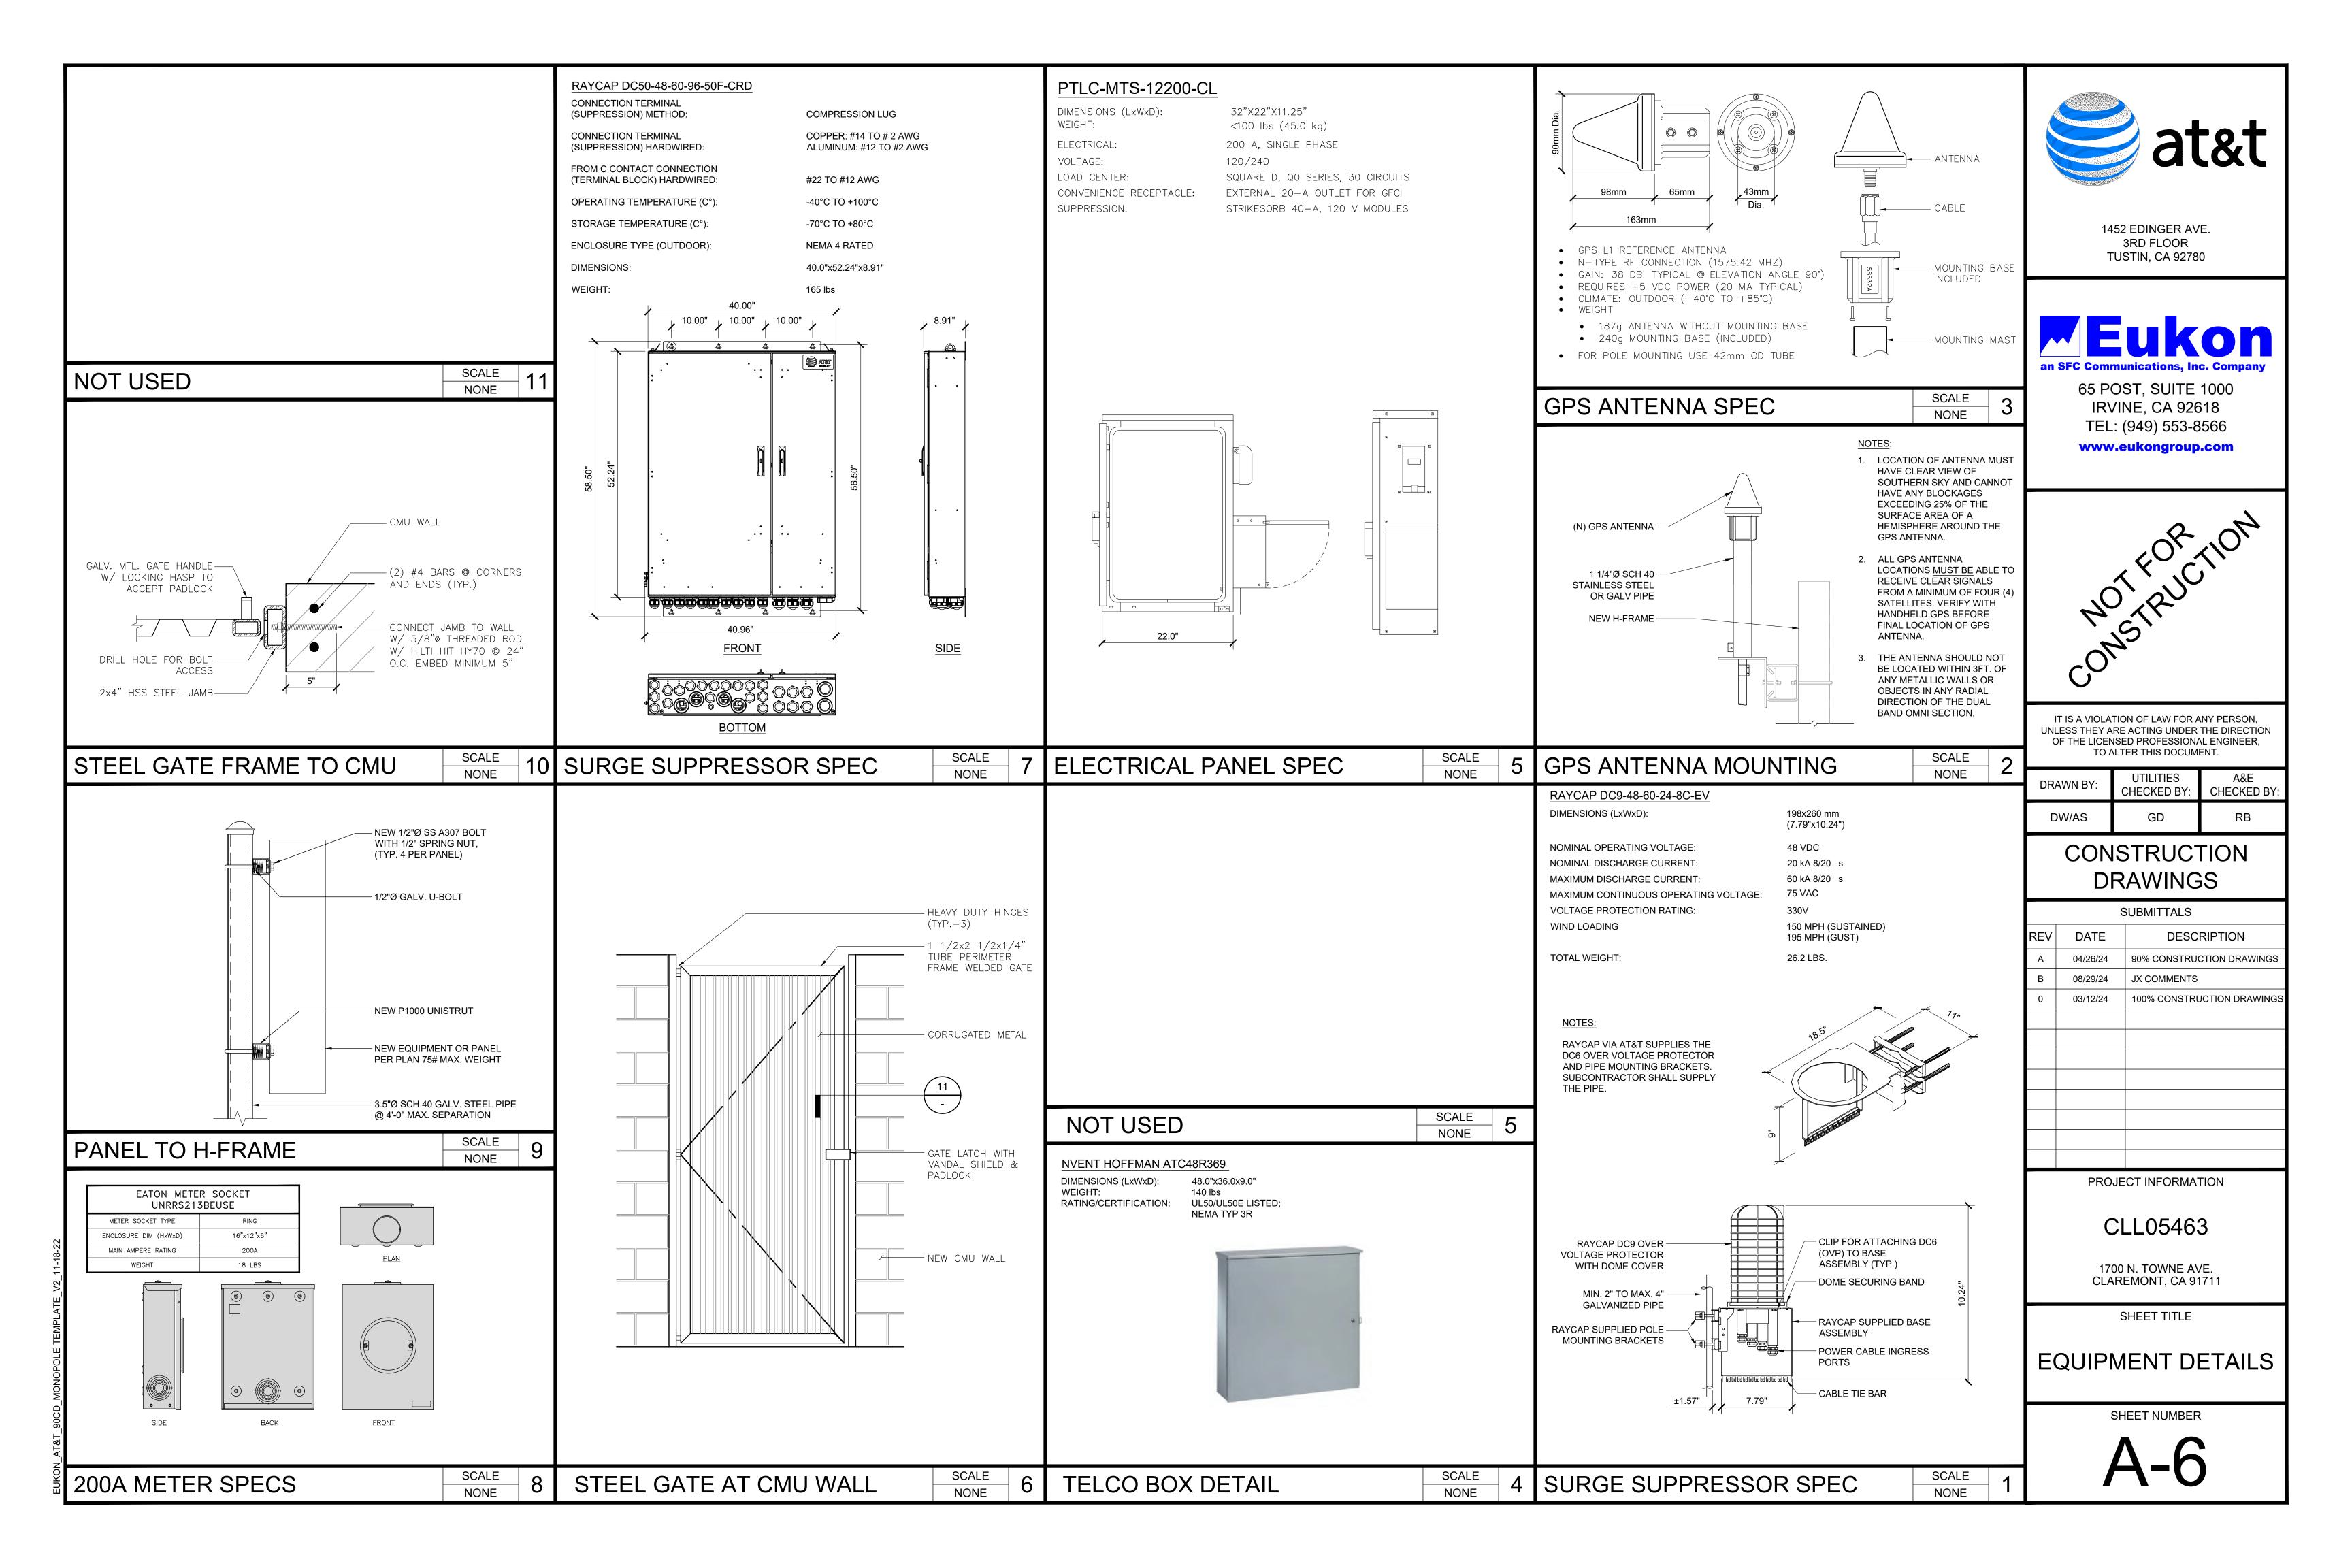

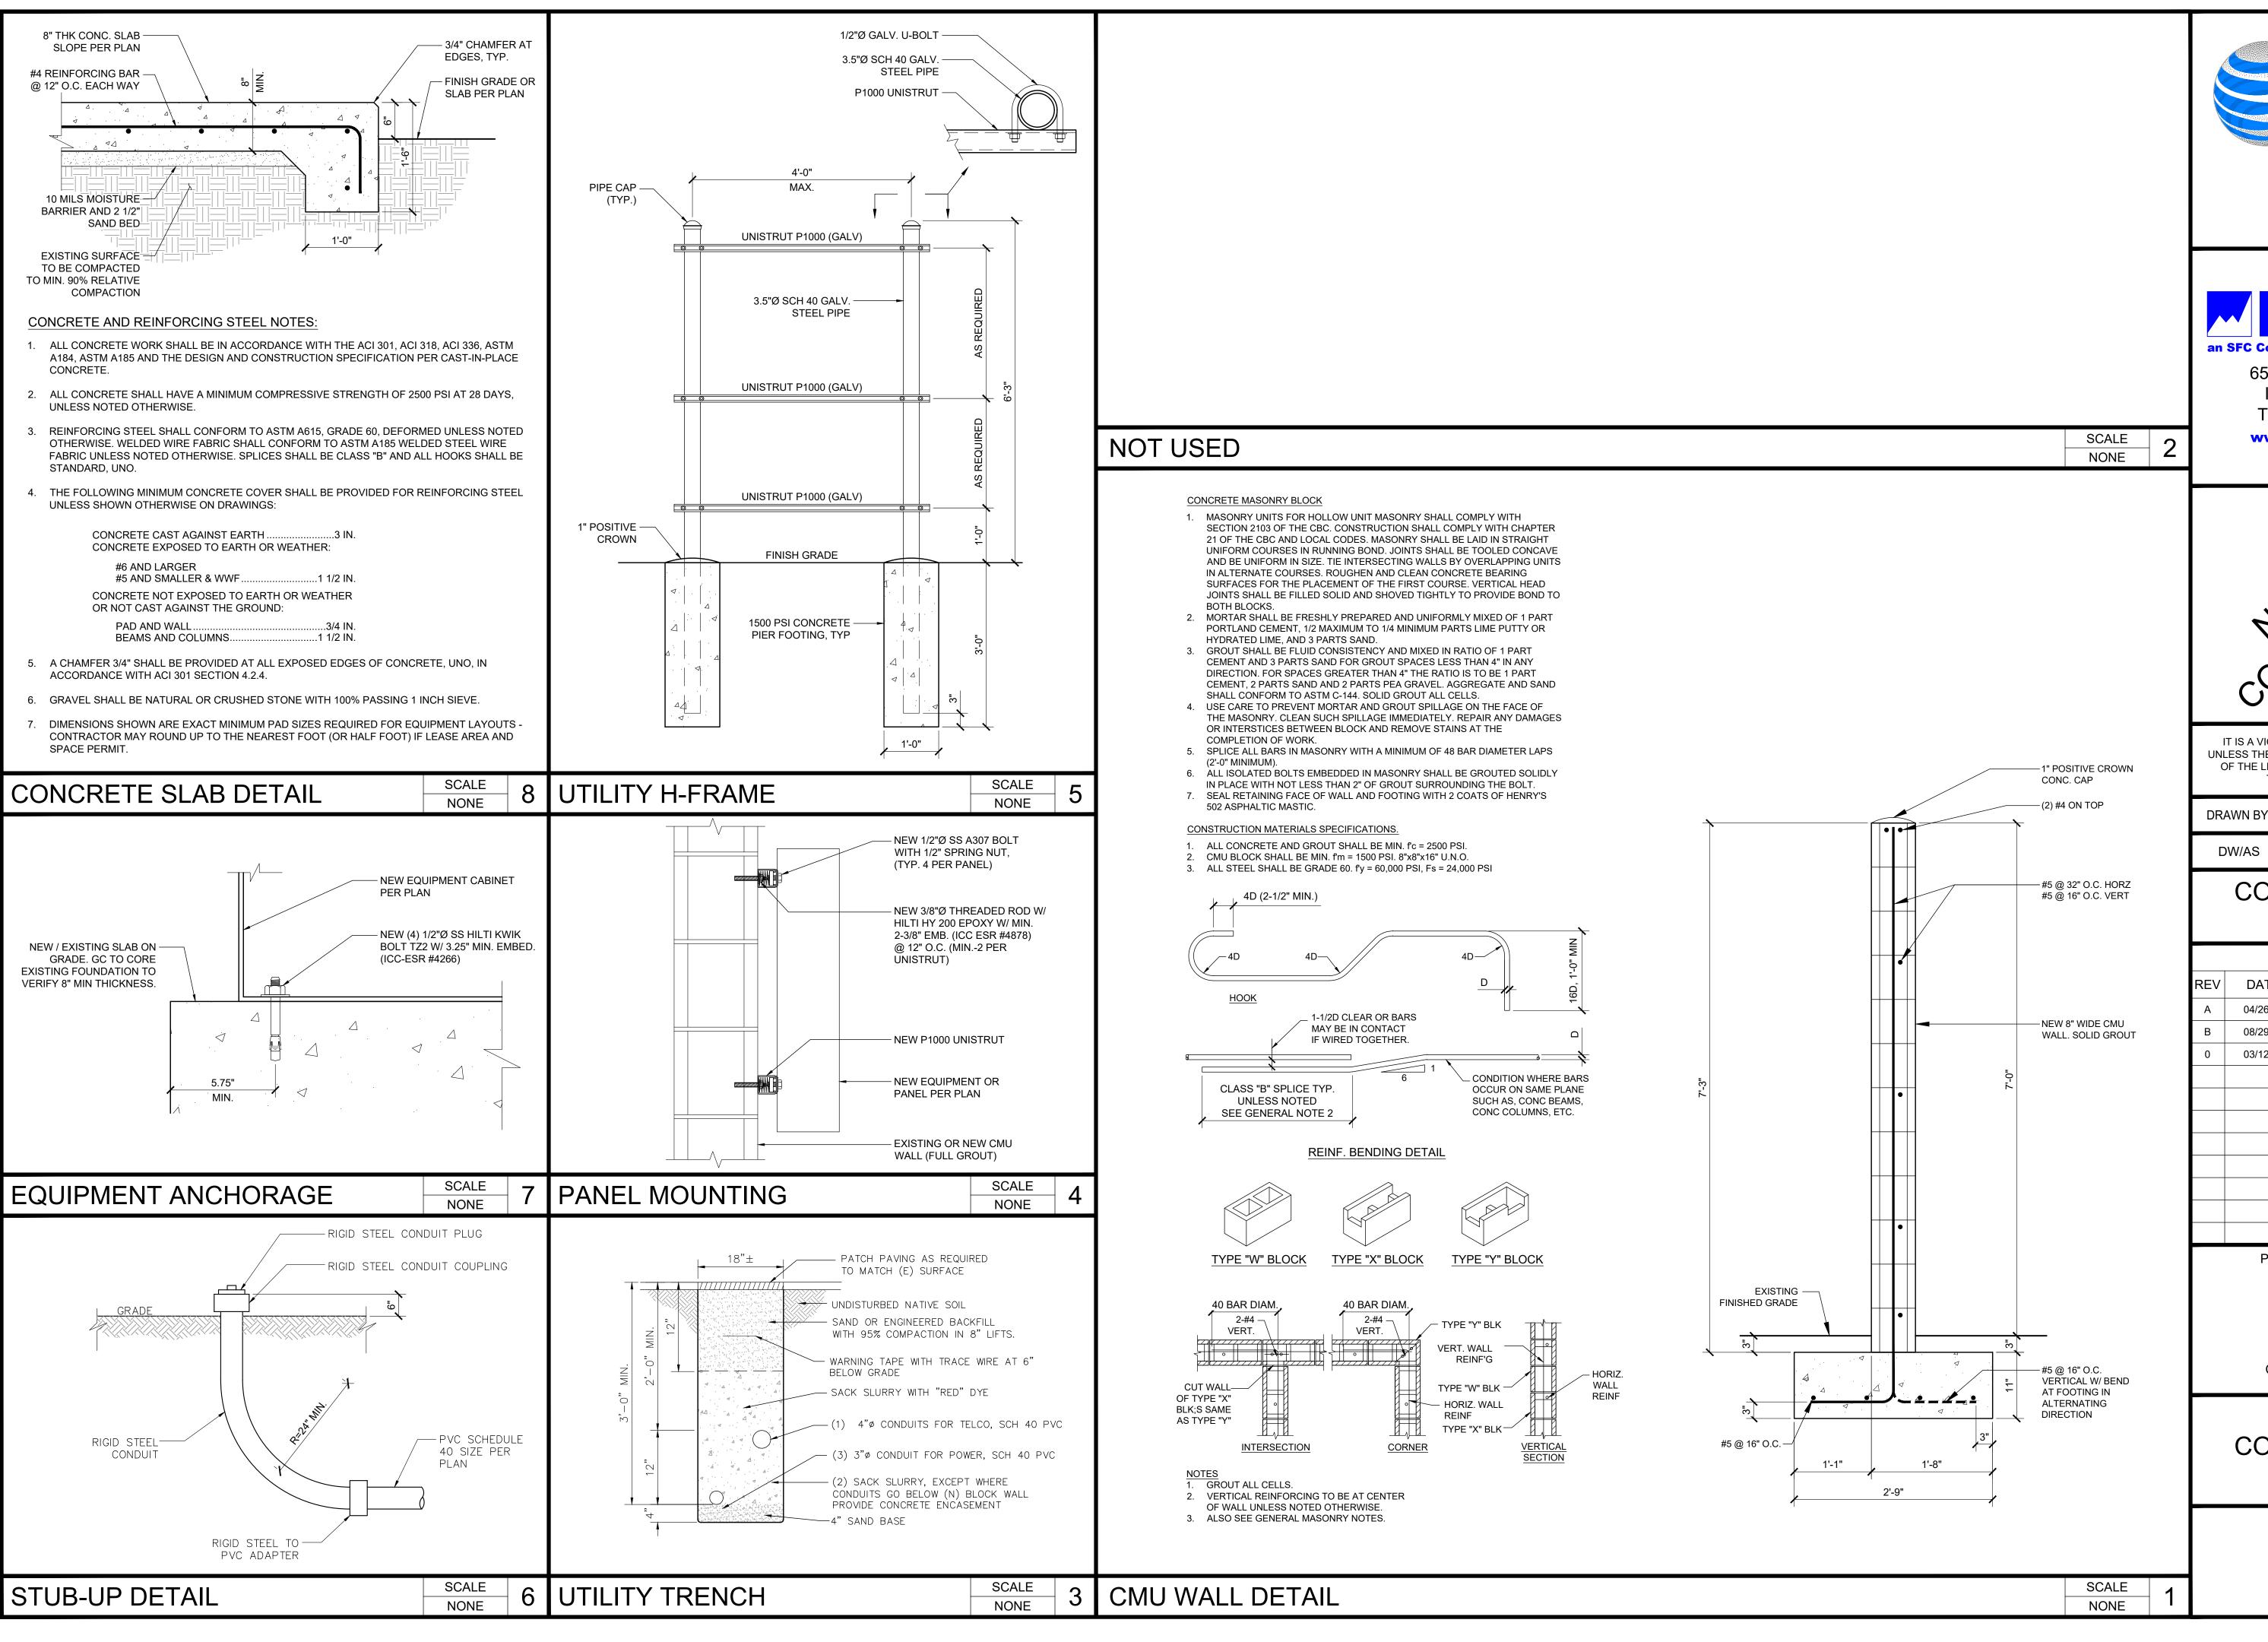



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CONSTRUCTION DRAWINGS

	SUBMITTALS		
REV	DATE	DESCRIPTION	
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В	08/29/24	JX COMMENTS	
0	03/12/24	100% CONSTRUCTION DRAWINGS	
PROJECT INFORMATION			

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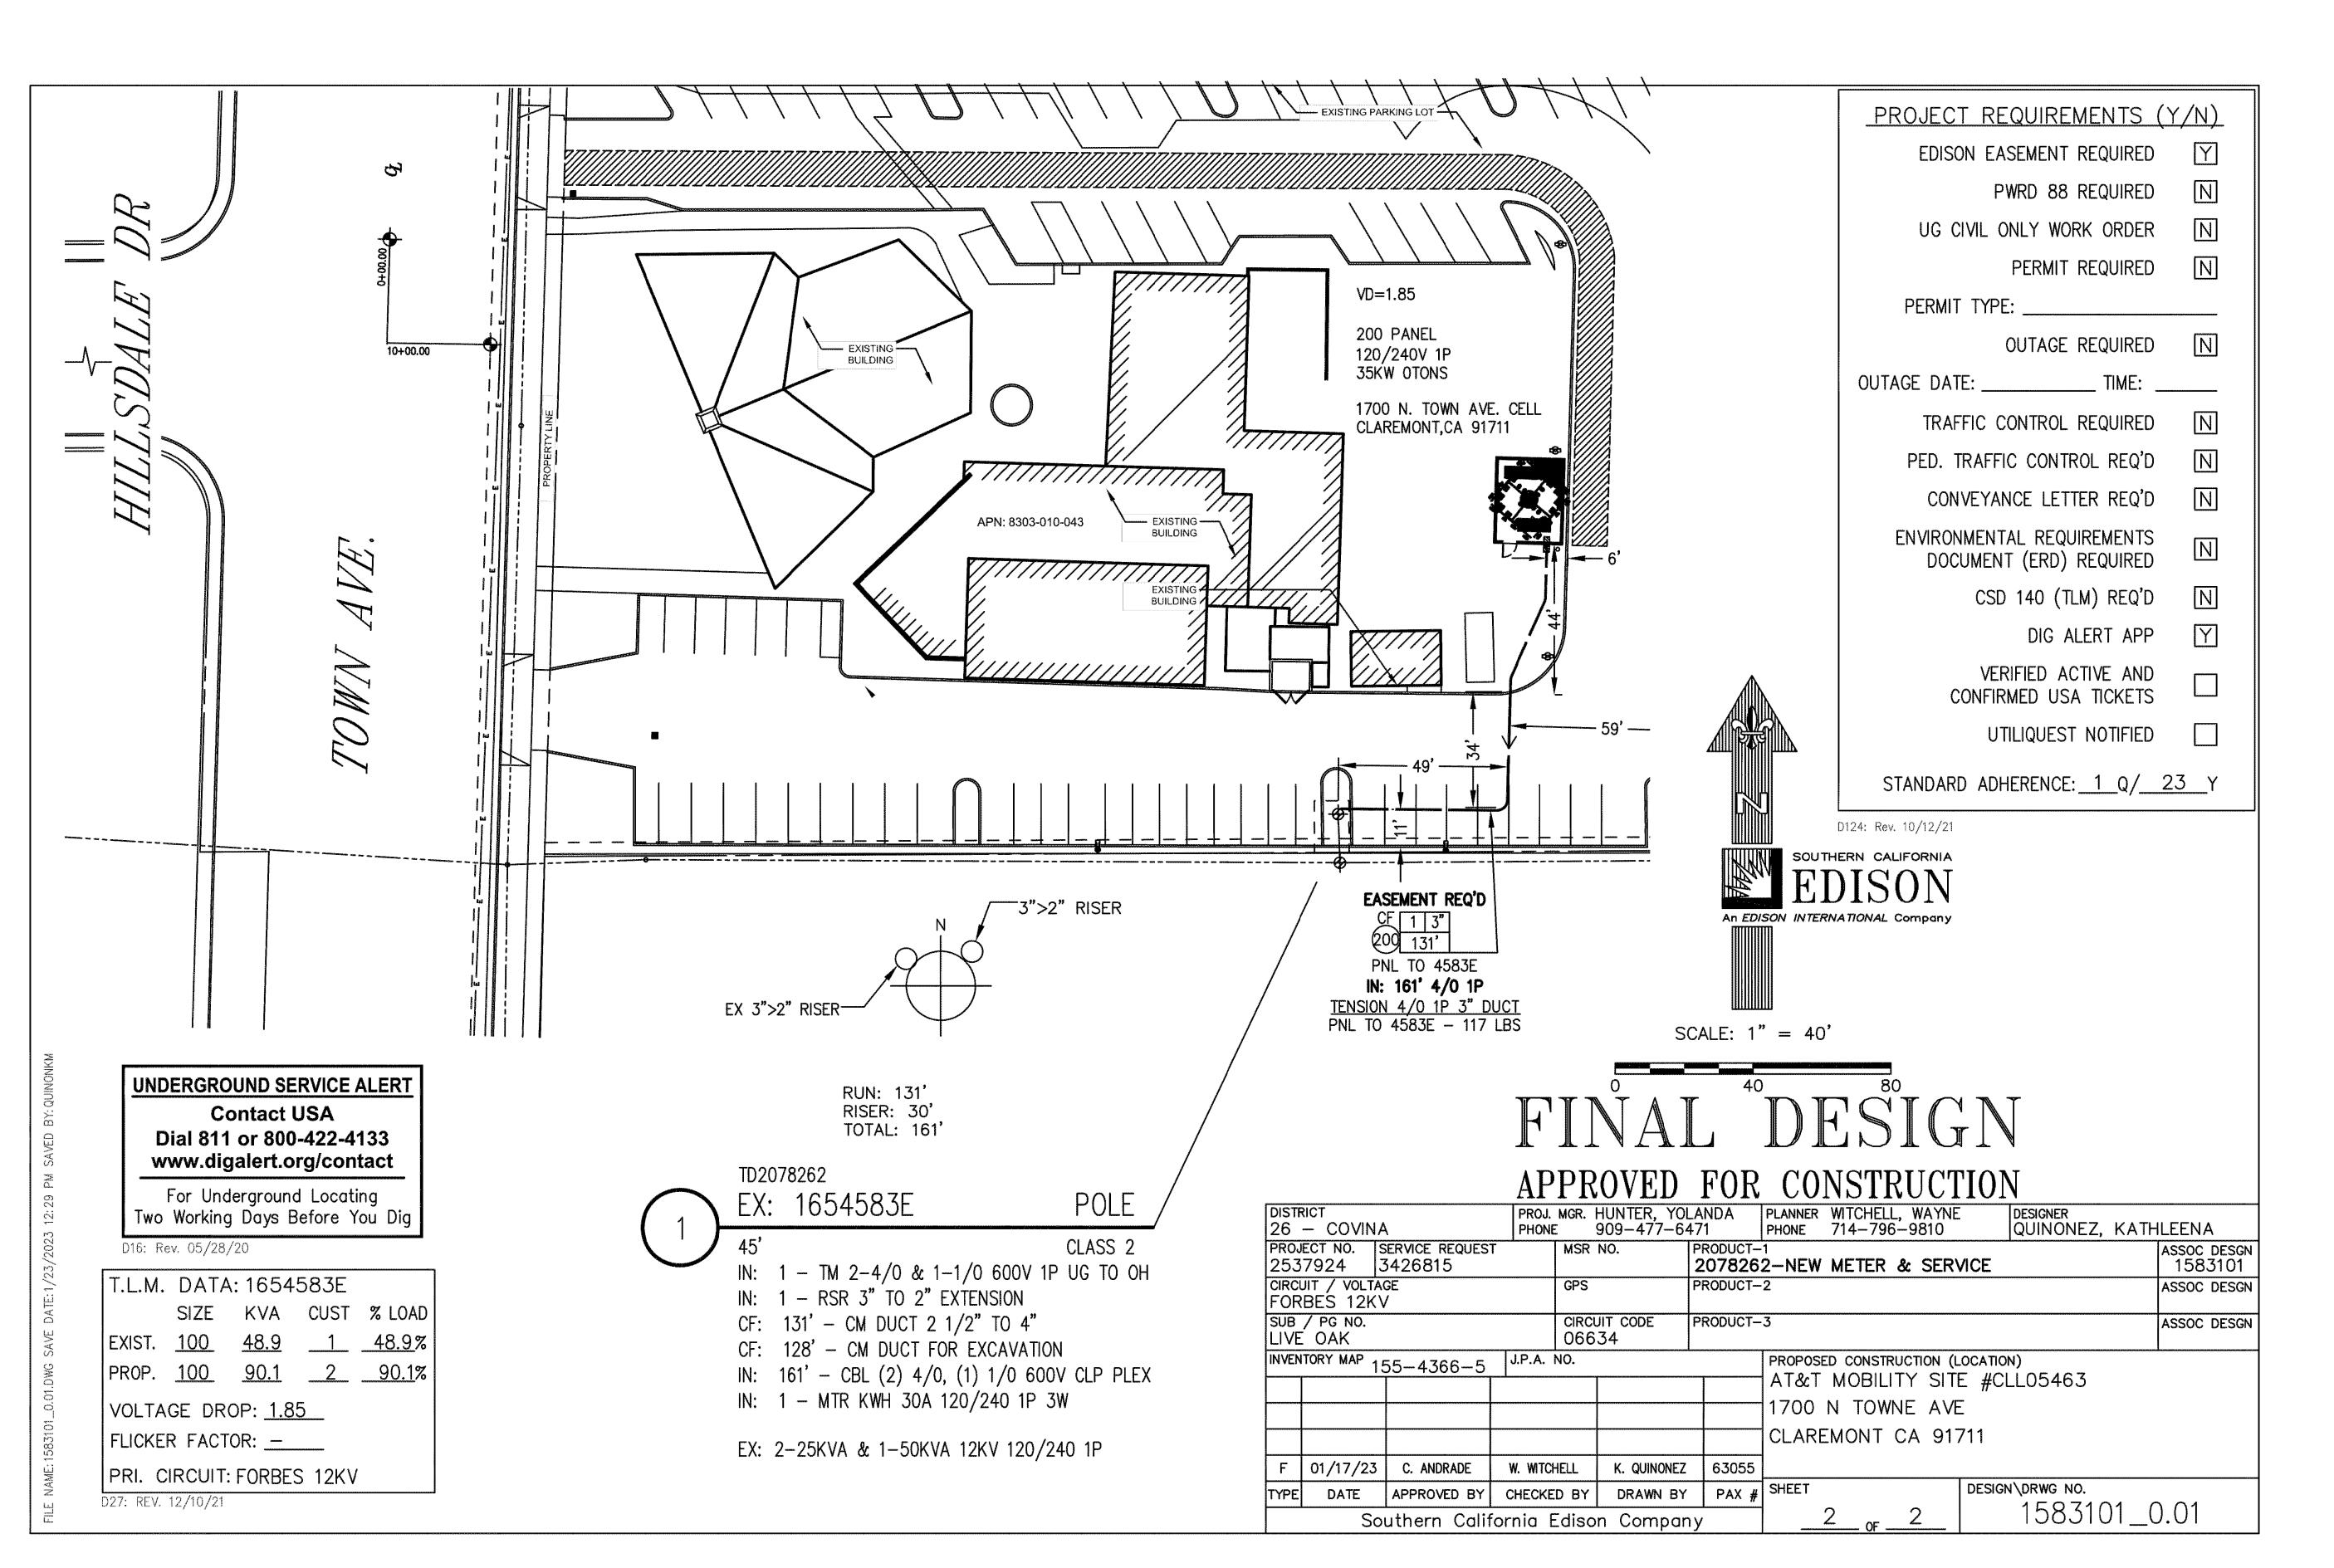
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SHEET TITLE

CONSTRUCTION DETAILS

SHEET NUMBER

A-8





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CONSTRUCTION DRAWINGS

	SUBMITTALS					
REV	DATE	DESCRIPTION				
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0	03/12/24	100% CONSTRUCTION DRAWINGS				

PROJECT INFORMATION

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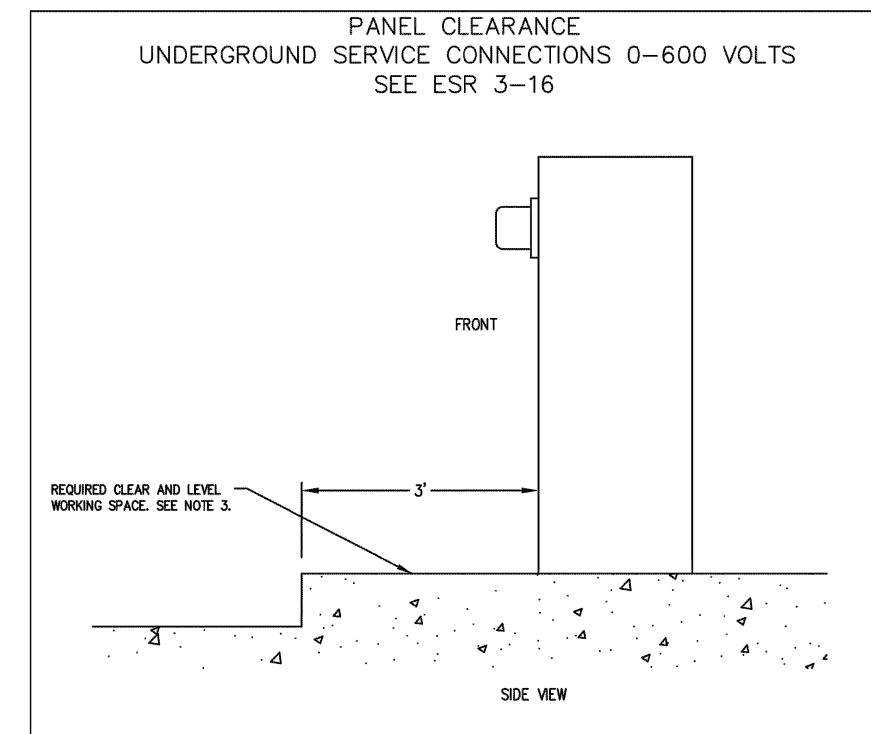
SHEET TITLE

UTILITY DESIGN

SHEET NUMBER

UD-1

EUKON_AT&T_90CD_MONOPOLE TEMPLATE_V2_11-18-22



≥ D99: 10/26/20

- A MINIMUM OF THREE (3) FEET OF CLEAR, LEVEL WORK SPACE IS REQUIRED IN FRONT OF ALL TERMINATION, METERING, AND SERVICE EQUIPMENT.
- SEE ESR-5 FOR METER-MOUNTING HEIGHT REQUIREMENTS. METER MOUNTING HEIGHT WILL BE MEASURED FROM THE STANDING AND WORKING SPACE TO THE CENTERLINE OF THE METER(S).
- WHEN SERVICE EQUIPMENT IS INSTALLED ON AN ELEVATED PORTION OF THE FLOOR/GROUND, OR HOUSEKEEEPING PAD, THE PAD SHALL BE FLUSH WITH AND EXTEND A MINIMUM OF THREE (3) FEET. THIS IS MEASURED FROM THE FRONT OF THE SERVICE EQUIPMENT OR THE OUTER DOOR(S) OF THE SWITCHBOARD NEMA 3R ENCLOSURE WHEN INSTALLED. IN NO CASE SHALL THE MAXIMUM METER HEIGHT OF SIX (6) FEET THREE (3) INCHES BE EXCEEDED.
- . TO MAINTAIN A SAFE, CLEAR, AND LEVEL WORKING AREA IN FRONT OF NEW OR EXISTING METER AND SERVICE EQUIPMENT, A CONCRETE SLAB OR OTHER SUITABLE PERMANENT HARD SURFACE, ACCEPTABLE TO THE COMPANY, MUST BE USED.
- FOR SWITCHBOARDS ABOVE 600V, FIVE—FOOT MINIMUM OF CLEAR AND LEVEL STANDING AND WORKING SPACE IS REQUIRED IN THE FRONT, REAR, AND SIDE OF ANY SECTION WHERE SUCH PART SUPPORTS OR PROVIDES ACCESS TO METERING, TESTING EQUIPMENT, OR SERVICE CABLE TERMINATION SECTIONS.

16.12 PROTECTIVE BARRIERS FOR SERVICE EQUIPMENT

BARRIER POSTS ARE USED TO PROTECT THE METER AND SERVICE EQUIPMENT, AS WELL AS PERSONNEL, FROM VEHICULAR CONTACT, AND TO PROHIBIT ENCROACHMENT INTO THE WORKING SPACE. (FOR EXAMPLE: LOADING ZONES, DRIVEWAYS, CONGESTED AREAS, OFF STREET PARKING, AND SO ON). THE CUSTOMER SHALL PROVIDE AND INSTALL "NON-REMOVABLE" BARRIERS TO PROVIDE THE PROPER SAFE WORKING CLEARANCES WHERE THE WORKSPACE IS EXPOSED TO VEHICULAR OR OTHER HAZARDOUS CONDITIONS. METERS WILL NOT BE SET UNTIL THE BARRIERS HAVE BEEN INSTALLED.

CONDUIT RADIUS REQUIREMENTS:

- A: The minimum radius for bends are: 36" for conduits 3" in diameter or smaller 48" for conduits 4" and 5" in diameter
- 60" for 6" diameter conduit B: The minimum radius for sweeps are: 36" for conduits 3" in diameter or smaller 12'-6" for conduits 4" in diameter and larger,


unless otherwise noted.

TYPICAL CONDUIT BANK SECTION


DIRECT BURIAL

2 CONDUITS MAX.

D81: Rev. 09/23/09

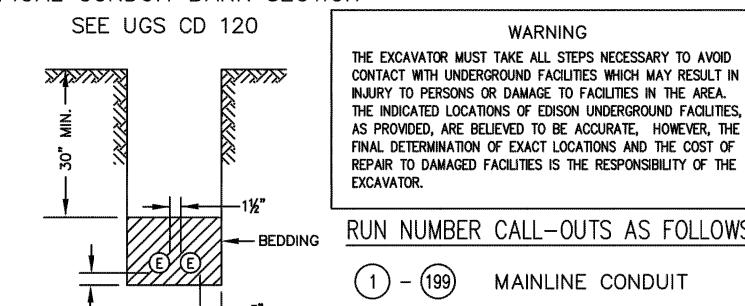

RUN NUMBER CALL-OUTS AS FOLLOWS:

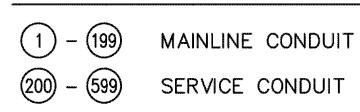


(600) SIMILAR CONSTRUCTION FOR FEWER CONDUIT

STREET LIGHT CONDUIT

D84: Rev. 10/26/20

RISER INSTALLATION USING UNISTRUT SEE DUG CR 110.2

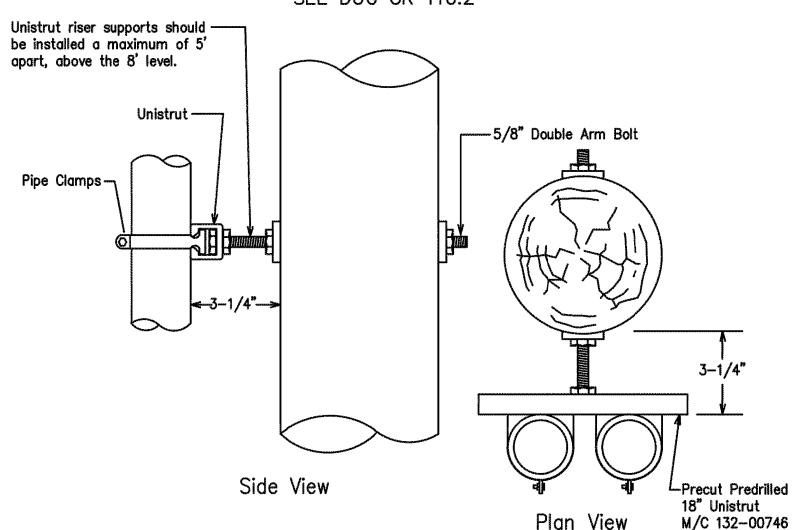

CONVENTIONAL RISER INSTALLATION

1. All notes pertaining to Figure CR 110-1.1 (Sheet 1) construction on scope CR 110.1 also apply to risers supported by a unistrut.

1.0 APPLICATION

REF.: DUG CR 110.2 D38: REV. 02/18/11

The unistrut shown in Figure CR 110-5 (Sheet 3) is the preferred method where multiple risers are required. 2.0 MATERIAL

TABLE CR 110-2: Unistrut Pipe Clamps

	•
Conduit Size (in)	Material Code
1	622-04052
2	133-48248
2.5	133-48214
3	133-00025
4	133-00017
55	133-48008
6	132-00746

CONNECTING TO EXISTING SCE STRUCTURES

tie-in to existing SCE facilities; e.g. structures, equipment, multi-conduit

• Per SCE requirements, customers are not allowed to enter, intercept or

runs/banks, or conductors. These facilities may be energized and the

inspector to schedule an appointment. Customers may connect to an existing conduit stub without a SCE inspector present.

Multi-conduit runs/banks are runs of conduit in close proximity to each

other and other SCE facilities. A conduit stub is a single empty conduit

stub that is not in close proximity to other SCE owned facilities. Refer

Per CPUC/SCE's Rule 15 B.1.A and Rule 16 D.1.A., the customer will

• The customer must adhere to all applicable Cal—OSHA, local, city, state

shoring and traffic control in place to perform the intercept/tie-in work

through the Division Inspector/P-Spec to limit exposure of excavation(s).

and federal regulations, (including, but not limited to, all necessary

• Intercept/tie-in work must be coordinated with SCE's civil contractors

pads and primary splice boxes), material (including conduit and

structures) and encasement, to be utilized in the intercept/tie-in

provide all necessary excavations (with the exception of excavation under

work will only be performed by SCE. Contact the appropriate SCE

to the work order map for details.

by SCE's underground civil contractor(s)).

D08: 11/13/18

Customer is responsible for securing excavation(s).

SCE Inspection Contact SCE 48 Hours in advance for a Pre-Construction meeting and/or Inspection. Email: NDPFCS@SCE.COM

ALL ELECTRICAL DUCTS AND STRUCTURES WILL CONFORM TO GENERAL ORDER #128 (RULES FOR CONSTRUCTION OF UNDERGROUND ELECTRICAL SUPPLY AND COMMUNICATION PRESCRIBED BY THE PUBLIC UTILITIES COMMISSION OF THE STATE OF CALIFORNIA, JANUARY 2006).

-SOLVENT WELD PIPE CAP ONTO RISER. DO NOT PERMIT EXCESS CEMENT TO ENTER CONDUIT. CAP HDG BEND WITH CONCRETE—FILLED COUPLING. 36"(MIN) RADIUS FOR 1" TO 3" INCL. 48"(MIN) RADUIS FOR 4" AND 5" 60"(MIN) RADIUS FOR 6" AND OVER AKIRIRUKIRUK GRADE 12KIRUKIRUK AKIRUK A MINIMUM EARTH COVER OVER RISER BEND TO BE AS FOLLOWS; - ENCASEMENT HDG FIBERGLASS COVER COVER #6(MIN) BARE COPPER TO GROUND RODS ---- COUPLING OR ADAPTER REAM INTERIOR OF LOWER END OF ABS RISER BEND TO PERMIT A SMOOTH TRANSITION FROM THE CONDUIT TO THE RISER. #6(MIN) BARE COPPER -

POLE RISER BEND STANDARD LOCATION

SEE UGS CD 160

ALIGN RISER WITH A TEMPORARY LENGTH OF CONDUIT; REMOVE THIS LENGTH WHEN RISER IS SET.

GROUND ROD AND CLAMP 2 PLACED 6'(MIN) SEPARATION GROUNDING TYPICAL FOR **BOTH POLE CONFIGURATIONS** APPROVED RISER BENDS ARE SHOWN ON FOLLOWING TABLE;

CONDUIT

MATERIAL 1" 1-1/2" 2" 2-1/2" 3" 4" 5" 6" HDG X X X X X X X X

NOTE: 6" HDG OR FIBERGLASS RISER BEND SHALL BE USED WHEN SPECIFIED ON THE WORKING DRAWING. SEE UGS AC 702 FOR GROUNDING HDG RISER BENDS.

- 2. THE TOP AND BOTTOM OF 3", 4", 5" OR 6" FIBERGLASS BENDS ARE FURNISHED WITH PERMANENTLY ATTACHED PVC COUPLINGS. ALSO INCLUDED IS A 6" LONG 3", 4", 5" OR 6" SCHEDULE 80 PVC STUB—OUT, SOLVENT WELDED INTO THE TOP COUPLING. SEE UGS CD 166 FOR FIBERGLASS RISER BEND MATERIAL INFORMATION AND SUPPLIERS.
- TWO GROUND RODS ARE REQUIRED AT ALL PRIMARY RISER POLES. DRIVE RODS IN TRENCH BOTTOM WITH 6' MINIMUM SEPARATION IN UNDISTURBED EARTH. LEAVE THE ROD TOPS 3" ABOVE THE TRENCH BOTTOM AND ATTACH CONTINUOUS GROUND WIRE WITH CLAMPS. EXTEND WIRE TO INDICATED LOCATION ON POLE AND STUB UP 2' ABOVE GRADE IN WOOD MOULDING. ALL GROUNDING MATERIALS FURNISHED BY CONTRACTORS. SEE UGS AC 703 FOR APPROVED GROUNDING MATERIALS.
- ENCASEMENT REQUIRED ONLY WHEN CALLED OUT ON WORKING DRAWING. PVC RISERS MAY BE SUBSTITUTED FOR FIBERGLASS FOR STRAIGHT RUNS OF 150' OR LESS IN CONDUIT SIZES 4" AND

D78: REV. 02/14/11

5/8" x 8' COPPERCLAD STEEL

FINAL DESIGN

APPROVED FOR CONSTRUCTION

DISTRICT PROJ. MGR. HUNTER PHONE 909-47			IUNTER, YOU 109-477-64	-ANDA 471	PLANNER PHONE	WITCHELI 714-796		-	DESIGNER QUINONEZ,	KAT	ΓHLEENA		
253	7924	SERVICE REQUEST 3426815		MSR NO. PRODUCT- 207826				METER	& SER	VICE			ASSOC DESGN 1583101
CIRCUIT / VOLTAGE GPS PROF			PRODUCT-	2						ASSOC DESGN			
LIVE	/ PG NO. OAK			CIRCU 0663	T CODE	PRODUCT-	3						ASSOC DESGN
INVENTORY MAP 155-4366-5 J.P.A. NO.					AT&T	ED CONSTR MOBILI N TOW	TY SIT	E #CL	v) L05463				
							CLAR	EMONT	CA 91	711			
F	01/17/23	C. ANDRADE	W. WITCH	1ELL	K. QUINONEZ	63055							
TYPE	DATE	APPROVED BY	CHECKE	CHECKED BY DRAWN BY PA		PAX #	SHEET			DESIGN	\DRWG NO.	~ <i>4</i>	0.01
	Southern California Edison Company					ıy		1 of _			158310	<i>)</i>	_U.U1



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DW/AS	GD	RB	

CONSTRUCTION **DRAWINGS**

	SUBMITTALS						
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Α	04/26/24	90% CONSTRUCTION DRAWINGS					
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0	03/12/24	100% CONSTRUCTION DRAWINGS					

PROJECT INFORMATION


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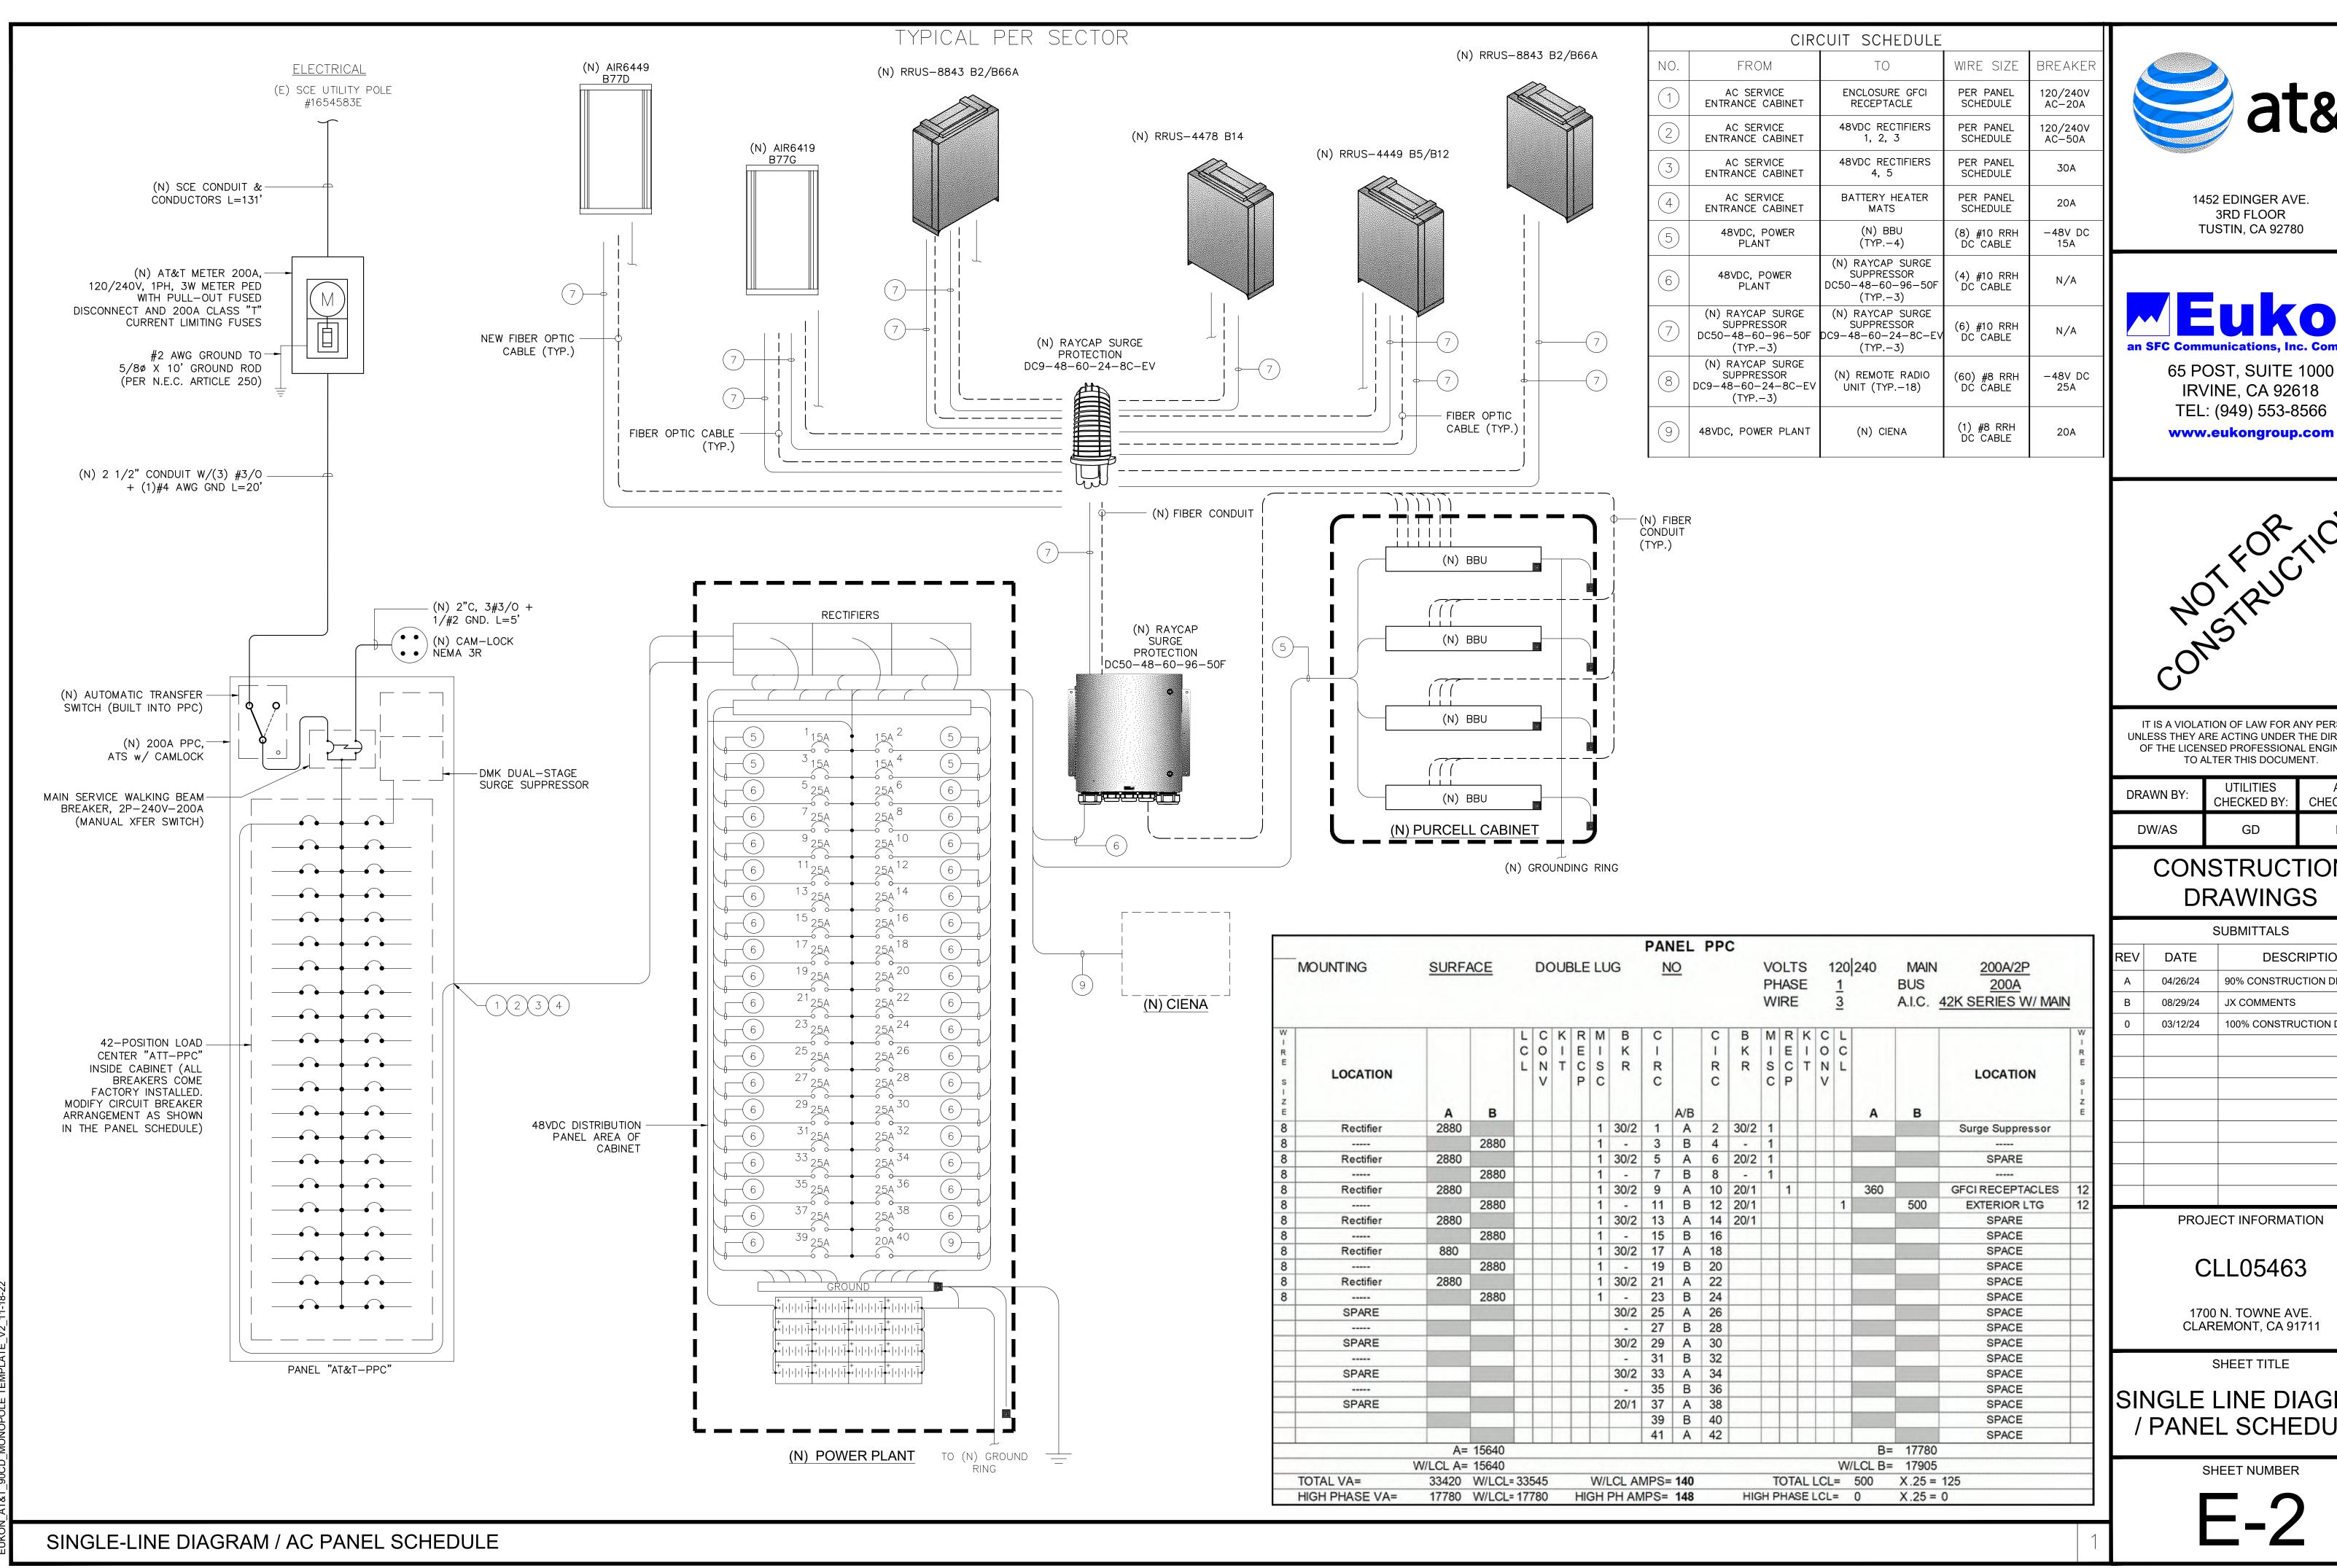
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SHEET TITLE

UTILITY DESIGN

SHEET NUMBER





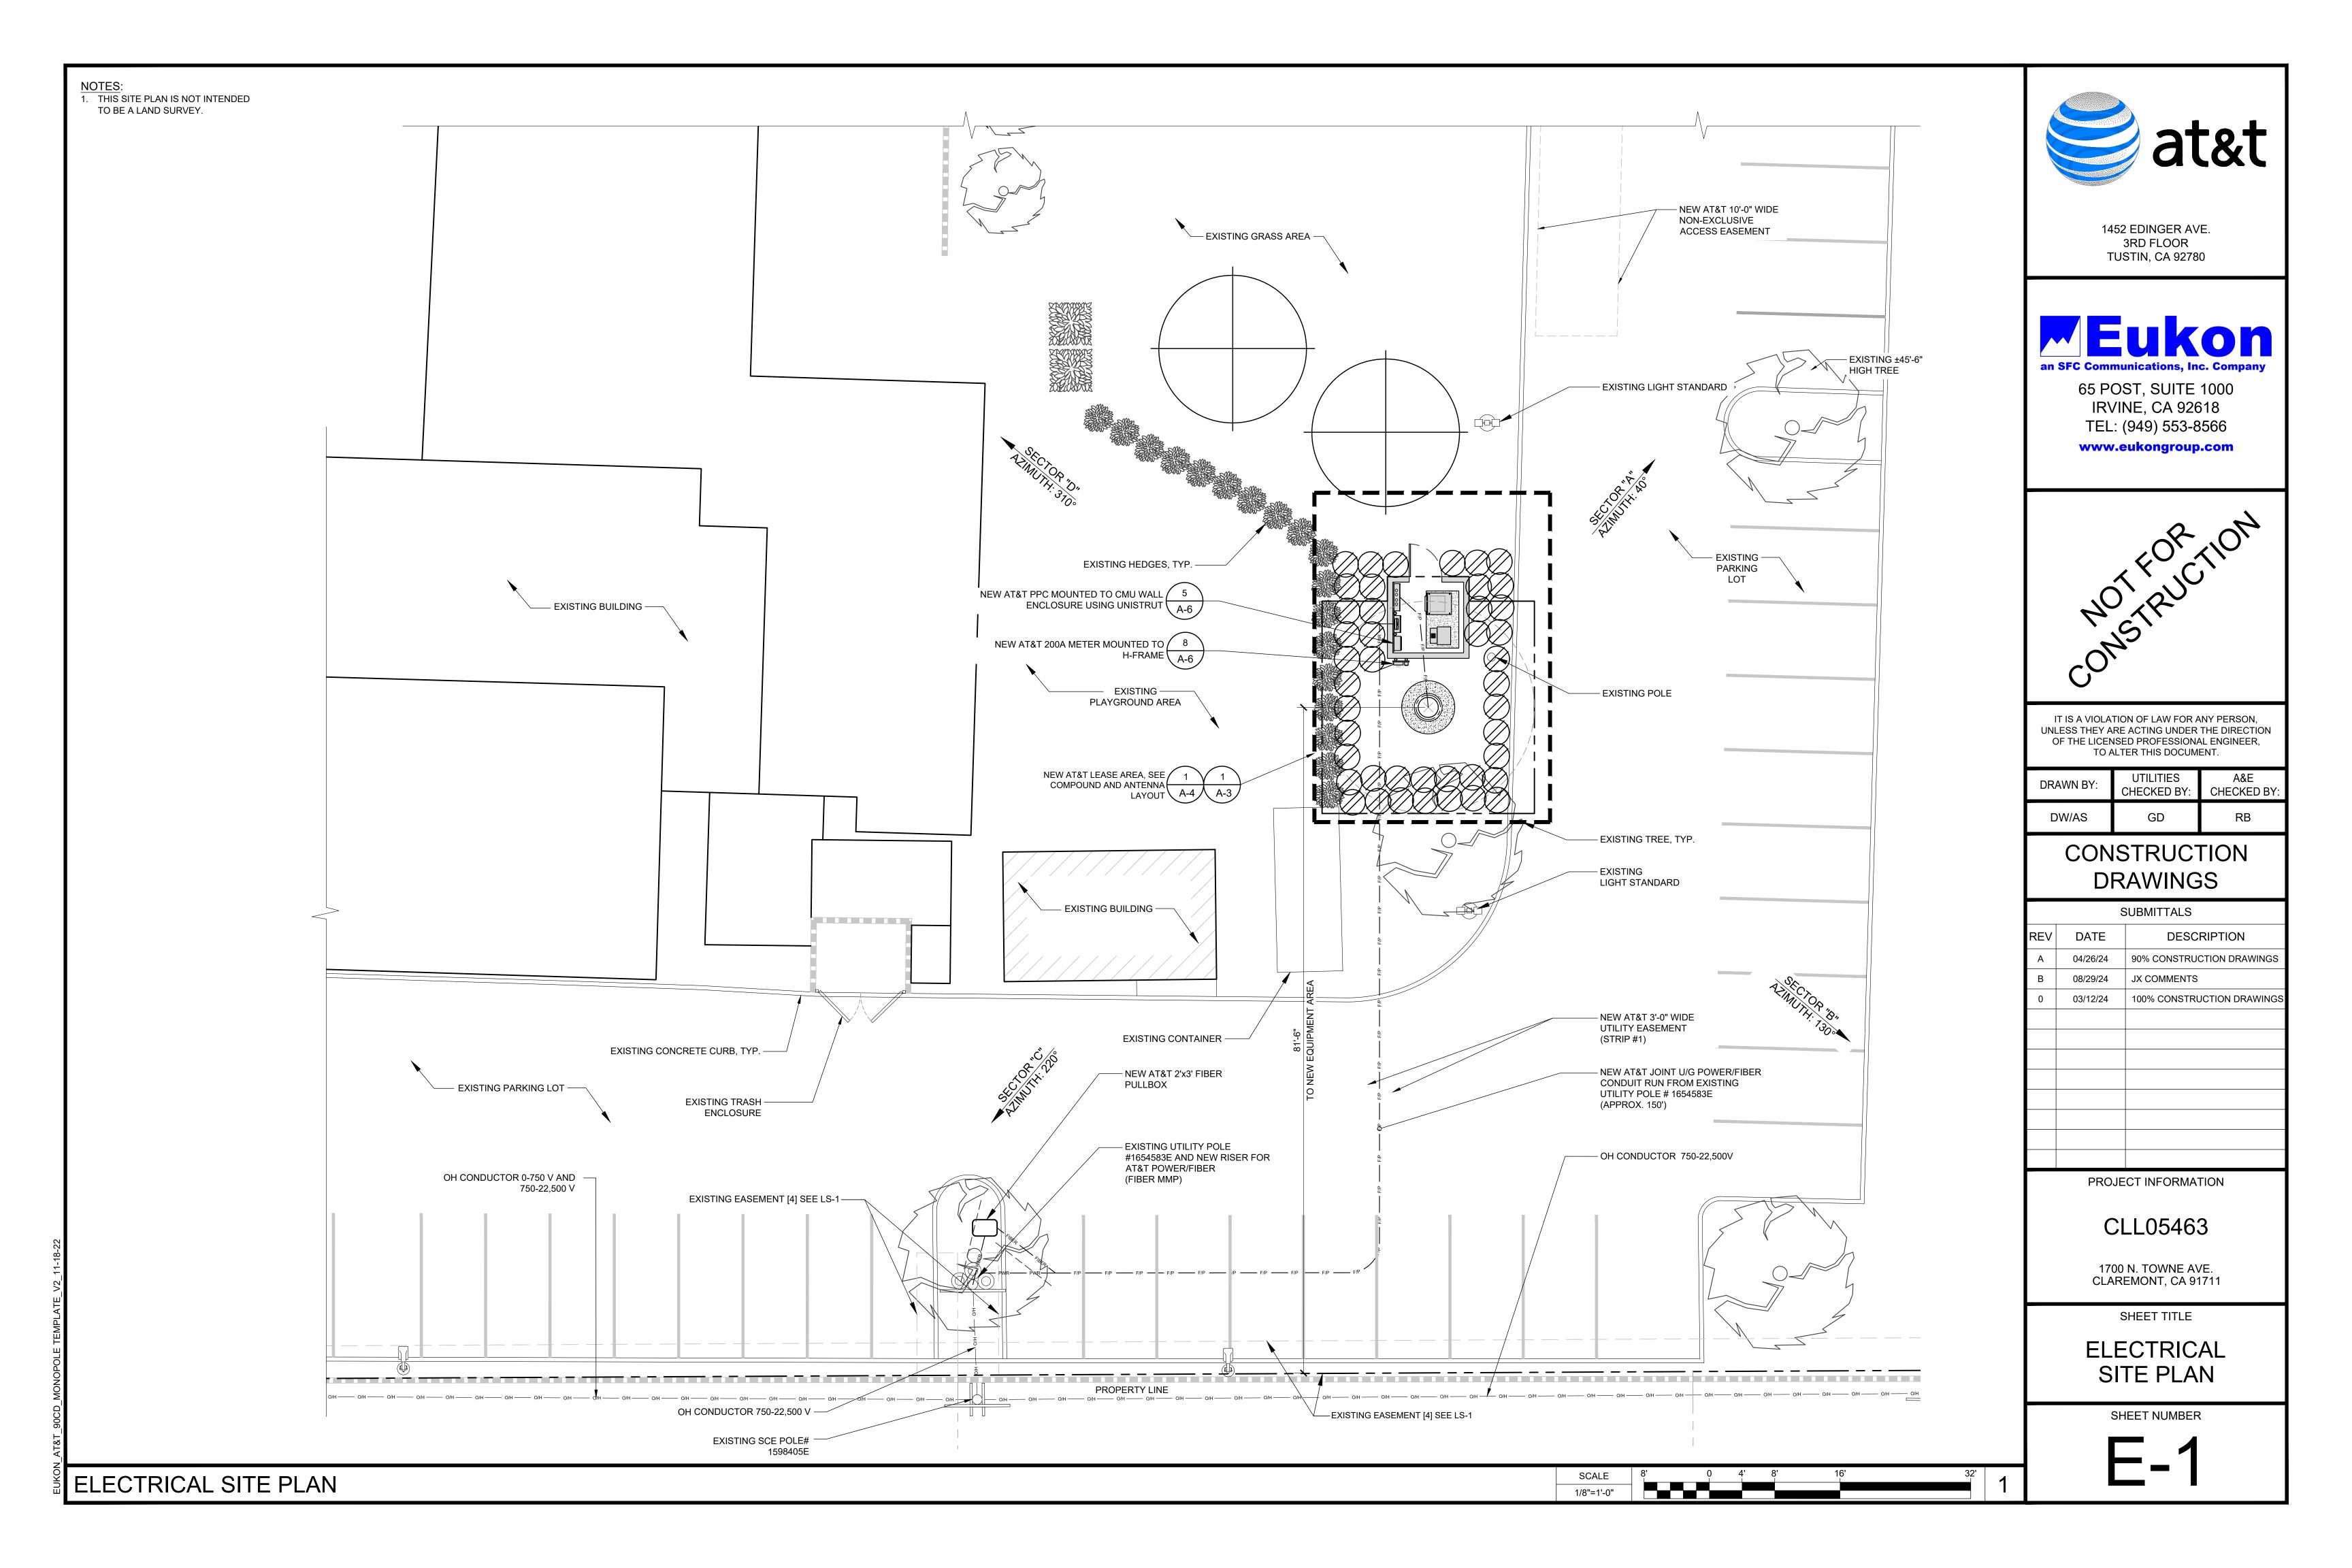



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PROJECT INFORMATION					

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SHEET TITLE

SINGLE LINE DIAGRAM / PANEL SCHEDULE

SHEET NUMBER

GENERAL REQUIREMENTS

- A. ALL WORK AND MATERIALS SHALL BE IN ACCORDANCE WITH THE LATEST RULES AND REGULATIONS OF THE NATIONAL ELECTRIC CODE AND ALL STATE AND LOCAL CODES. NOTHING IN THESE PLANS OR SPECIFICATIONS SHALL BE CONSTRUED AS TO PERMIT WORK NOT CONFORMING TO THE MOST STRINGENT OF THESE CODES. SHOULD CHANGES BE NECESSARY IN THE DRAWINGS OR SPECIFICATIONS TO MAKE THE WORK COMPLY WITH THESE REQUIREMENTS, THE CONTRACTOR SHALL IMMEDIATELY NOTIFY THE ARCHITECT IN WRITING AND CEASE WORK ON PARTS OF THE CONTRACT WHICH ARE AFFECTED.
- THE CONTRACTOR SHALL MAKE A SITE VISIT PRIOR TO BIDDING AND CONSTRUCTION TO VERIFY ALL EXISTING CONDITIONS AND SHALL NOTIFY THE ARCHITECT IMMEDIATELY UPON DISCOVERY OF ANY DISCREPANCIES. THE CONTRACTOR ASSUMES ALL LIABILITY FOR FAILURE TO COMPLY WITH THIS PROVISION.
- THE EXTENT OF THE WORK IS INDICATED BY THE DRAWINGS. SCHEDULES, AND SPECIFICATIONS AND IS SUBJECT TO THE TERMS AND CONDITIONS OF THE CONTRACT. THE WORK SHALL CONSIST OF FURNISHING ALL LABOR, EQUIPMENT, MATERIALS AND SUPPLIES NECESSARY FOR A COMPLETE AND OPERATIONAL ELECTRICAL SYSTEM. THE WORK SHALL ALSO INCLUDE THE COMPLETION OF ALL ELECTRICAL WORK NOT MENTIONED OR SHOWN WHICH ARE NECESSARY FOR SUCCESSFUL OPERATION OF ALL SYSTEMS.
- D. THE CONTRACTOR SHALL PREPARE A BID FOR A COMPLETE AND OPERATIONAL SYSTEM, WHICH INCLUDES THE COST FOR MATERIAL AND LABOR.
- WORKMANSHIP AND NEAT APPEARANCE SHALL BE AS IMPORTANT AS THE OPERATION. DEFECTIVE OR DAMAGED MATERIALS SHALL BE REPLACED OR REPAIRED PRIOR TO FINAL ACCEPTANCE IN A MANNER ACCEPTABLE TO OWNER AND ENGINEER.
- COMPLETE THE ENTIRE INSTALLATION AS SOON AS THE PROGRESS OF THE WORK WILL PERMIT. ARRANGE ANY OUTAGE OF SERVICE WITH THE OWNER AND BUILDING MANAGER IN ADVANCE. MINIMIZE DOWNTIME ON THE BUILDING ELECTRICAL SYSTEM.
- G. THE ENTIRE ELECTRICAL SYSTEM INSTALLED UNDER THIS CONTRACT SHALL BE DELIVERED IN PROPER WORKING ORDER. REPLACE, WITHOUT ADDITIONAL COST TO THE OWNER, ANY DEFECTIVE MATERIAL AND EQUIPMENT WITHIN ONE YEAR FROM THE DATE OF FINAL ACCEPTANCE.
- H. ANY ERROR, OMISSION OR DESIGN DISCREPANCY ON THE DRAWINGS SHALL BE BROUGHT TO THE ATTENTION OF THE ENGINEER FOR CLARIFICATION OR CORRECTION BEFORE CONSTRUCTION.
- "PROVIDE": INDICATES THAT ALL ITEMS ARE TO BE FURNISHED, INSTALLED AND CONNECTED IN PLACE.
- CONTRACTOR SHALL SECURE ALL NECESSARY BUILDING PERMITS AND PAY ALL REQUIRED FEES.

EQUIPMENT LOCATION

- A. THE DRAWINGS INDICATE DIAGRAMMATICALLY THE DESIRED LOCATIONS OR ARRANGEMENTS OF CONDUIT RUNS, OUTLETS, EQUIPMENT, ETC., AND ARE TO BE FOLLOWED AS CLOSELY AS POSSIBLE. PROPER JUDGMENT MUST BE EXERCISED IN EXECUTING THE WORK SO AS TO SECURE THE BEST POSSIBLE INSTALLATION IN THE AVAILABLE SPACE AND TO OVERCOME LOCAL DIFFICULTIES DUE TO SPACE LIMITATIONS OR INTERFERENCE OF STRUCTURE CONDITIONS ENCOUNTERED.
- B. IN THE EVENT CHANGES IN THE INDICATED LOCATIONS OR ARRANGEMENTS ARE NECESSARY. DUE TO FIELD CONDITIONS IN THE BUILDING CONSTRUCTION OR REARRANGEMENT OF FURNISHINGS OR EQUIPMENT, SUCH CHANGES SHALL BE MADE WITHOUT COST, PROVIDING THE CHANGE IS ORDERED BEFORE THE CONDUIT RUNS, ETC., AND WORK DIRECTLY CONNECTED TO THE SAME IS INSTALLED AND NO EXTRA MATERIALS ARE REQUIRED.
- LIGHTING FIXTURES ARE SHOWN IN THEIR APPROXIMATE LOCATIONS ONLY. COORDINATE THE FIXTURE LOCATION WITH MECHANICAL EQUIPMENT TO AVOID INTERFERENCE.
- D. COORDINATE THE WORK OF THIS SECTION WITH THAT OF ALL OTHER TRADES. WHERE CONFLICTS OCCUR, CONSULT WITH THE RESPECTIVE CONTRACTOR AND COME TO AGREEMENT AS TO CHANGES NECESSARY. OBTAIN WRITTEN ACCEPTANCE FROM ENGINEER FOR THE PROPOSED CHANGES BEFORE PROCEEDING.

SHOP DRAWINGS

SUBMIT SIX (6) COPIES OF SHOP DRAWINGS TO THE ARCHITECT FOR APPROVAL WITHIN 35 DAYS OF AWARD OF CONTRACT, SHOP DRAWINGS SHALL BE SUBMITTED IN A COMPLETE BOUND MANUAL INCLUDING LIGHT FIXTURES, SERVICE METERING, TRANSFER SWITCH, PANELBOARD, AND DISCONNECT SWITCHES. THE CONTRACTOR SHALL VERIFY DIMENSIONS OF EQUIPMENT TO INSURE THAT THEY FIT IN THE DESIGNATED AREA AND COMPLY WITH REQUIREMENTS OF ALL APPLICABLE CODES FOR REQUIRED WORKING CLEARANCES ABOUT ELECTRICAL EQUIPMENT PRIOR TO SUBMITTING SHOP DRAWINGS FOR APPROVAL. DEPARTURE FROM THE ABOVE WILL RESULT IN RE-SUBMITTAL AND DELAYS.

SUBSTITUTIONS

A. NO SUBSTITUTIONS ARE ALLOWED.

<u>TESTS</u>

BEFORE FINAL ACCEPTANCE OF WORK, THE CONTRACTOR SHALL INSURE THAT ALL EQUIPMENT, SYSTEMS, FIXTURES, ETC., ARE WORKING SATISFACTORILY AND TO THE INTENT OF THE DRAWINGS.

PERMITS

A. THE CONTRACTOR SHALL BE RESPONSIBLE FOR TAKING OUT AND PAYING FOR ALL THE REQUIRED PERMITS, INSPECTION AND EXAMINATION WITHOUT ADDITIONAL EXPENSE TO THE OWNER.

GROUNDING

NOT USED

A. THE CONTRACTOR SHALL PROVIDE A COMPLETE, AND APPROVED GROUNDING SYSTEM INCLUDING ELECTRODES. ELECTRODE CONDUCTOR, BONDING CONDUCTORS, AND EQUIPMENT CONDUCTORS AS REQUIRED BY ARTICLE 250 OF NATIONAL ELECTRICAL CODE.

- B. CONDUITS CONNECTED TO EQUIPMENT AND DEVICES SHALL BE METALLICALLY JOINED TOGETHER TO PROVIDE EFFECTIVE ELECTRICAL CONTINUITY.
- C. FEEDERS AND BRANCH CIRCUIT WIRING INSTALLED IN A NONMETALLIC CONDUIT SHALL INCLUDE A CODE SIZED GROUNDING CONDUCTOR HAVING GREEN INSULATION. THE GROUND CONDUCTOR SHALL BE PROPERLY CONNECTED AT BOTH ENDS TO MAINTAIN ELECTRICAL CONTINUITY.
- D. REFER TO GROUND BUS DETAILS. PROVIDE NEW GROUND SYSTEM COMPLETE WITH CONDUCTORS, GROUND ROD AND DESCRIBED TERMINATIONS.
- E. ALL GROUNDING CONDUCTORS SHALL BE SOLIDINNED COPPER AND ANNEALED #2 UNLESS NOTED OTHERWISE.
- F. ALL NON-DIRECT BURIED TELEPHONE EQUIPMENT GROUND CONDUCTORS SHALL BE #2 STRANDED, THHN (GREEN) INSULATION.
- G. ALL GROUND CONNECTIONS SHALL BE MADE WITH "HYGROUND" COMPRESSION SYSTEM BURNDY CONNECTORS EXCEPT WHERE NOTED OTHERWISE.
- H. PAINT AT ALL GROUND CONNECTIONS SHALL BE REMOVED.
- GROUNDING SYSTEM RESISTANCE SHALL NOT EXCEED 5 OHMS. IF THE RESISTANCE VALUE IS EXCEEDED, NOTIFY THE OWNER FOR FUTURE INSTRUCTION ON METHODS FOR REDUCING THE RESISTANCE VALUE. SUBMIT TEST REPORTS AND FURNISH TO SMART SMR ONE COMPLETE SET OF PRINTS SHOWING "INSTALLED WORK".

UTILITY SERVICE

- A. TELEPHONE AND ELECTRICAL METERING FACILITIES SHALL CONFORM TO THE REQUIREMENTS OF THE SERVING UTILITY COMPANIES. CONTRACTOR SHALL VERIFY SERVICE LOCATIONS AND REQUIREMENTS. SERVICE INFORMATION WILL BE FURNISHED BY THE SERVING UTILITIES.
- B. CONFORM TO ALL REQUIREMENTS OF THE SERVING UTILITY COMPANIES.

 ALL MATERIALS SHALL BE NEW, CONFORMING WITH THE NEC, ANSI, NEMA, AND THEY SHALL BE U.L. LISTED AND LABELED.

- 1. RIGID CONDUIT SHALL BE U.L. LABEL GALVANIZED ZINC COATED WITH ZINC INTERIOR AND SHALL BE USED WHEN INSTALLED IN OR UNDER CONCRETE SLABS, IN CONTACT WITH THE EARTH, UNDER PUBLIC ROADWAYS, IN MASONRY WALLS OR EXPOSED ON BUILDING EXTERIOR, RIGID CONDUIT IN CONTACT WITH EARTH SHALL BE 1/2 LAPPED WRAPPED WITH HUNTS WRAP PROCESS
- 2. ELECTRICAL METALLIC TUBING SHALL HAVE U.L. LABEL, FITTINGS SHALL BE COMPRESSION TYPE. EMT SHALL BE USED ONLY FOR INTERIOR RUNS.
- 3. FLEXIBLE METALLIC CONDUIT SHALL HAVE U.L. LISTED LABEL AND MAY BE USED WHERE PERMITTED BY CODE. FITTINGS SHALL BE "JAKE" OR "SQUEEZE" TYPE. SEAL TIGHT FLEXIBLE CONDUIT. ALL CONDUIT IN EXCESS OF SIX FEET IN LENGTH SHALL HAVE FULL SIZE GROUND WIRE.
- 4. CONDUIT RUNS MAY BE SURFACE MOUNTED IN CEILING OR WALLS UNLESS INDICATED OTHERWISE. CONDUIT INDICATED SHALL RUN PARALLEL OR AT RIGHT ANGLES TO CEILING, FLOOR OR BEAMS. VERIFY EXACT ROUTING OF ALL EXPOSED CONDUIT WITH ARCHITECT PRIOR TO INSTALLING.
- 5. ALL UNDERGROUND CONDUITS SHALL BE PVC SCHEDULE 40 (UNLESS NOTED OTHERWISE) AT A MINIMUM DEPTH OF 24" BELOW GRADE.
- 6. ALL CONDUIT ONLY (C.O.) SHALL HAVE PULL ROPE.
- 7. CONDUITS RUN ON ROOFS SHALL BE INSTALLED ON 4 X 4 REDWOOD SLEEPERS, 6'-0" ON CENTER, SET IN NON-HARDENING MASTIC.
- C. ALL WIRE AND CABLE SHALL BE COPPER, 600 VOLT, #12 AWG MINIMUM UNLESS SPECIFICALLY NOTED OTHERWISE ON THE DRAWINGS. CONDUCTORS #10 AWG AND SMALLER SHALL BE SOLID. CONDUCTORS #8 AWG AND LARGER SHALL BE STRANDED. TYPE THHN INSULATION USED UNLESS CONDUCTORS INSTALLED IN CONDUIT EXPOSED TO WEATHER, IN WHICH CASE TYPE THWN INSULATION SHALL BE USED.
- D. PROVIDE GALVANIZED COATED STEEL BOXES AND ACCESSORIES SIZED PER CODE TO ACCOMMODATE ALL DEVICES AND WIRING.
- E. DUPLEX RECEPTACLES SHALL BE SPECIFICATION GRADE WITH WHITE FINISH (UNLESS NOTED BY ENGINEER), 20 AMP, 125 VOLT, THREE WIRE GROUNDING TYPE, NEMA 5-20R. MOUNT RECEPTACLE AT +12" ABOVE FINISHED FLOOR UNLESS OTHERWISE INDICATED ON DRAWINGS OR IN DETAILS. WEATHERPROOF RECEPTACLES SHALL BE GROUND FAULT INTERRUPTER TYPE WITH SIERRA #WPD-8 LIFT COVERPLATES.
- F. TOGGLE SWITCHES SHALL BE 20 AMP, 120 VOLT AC, SPECIFICATION GRADE WHITE (UNLESS NOTED OTHERWISE) FINISH. MOUNT SWITCHES AT +48" ABOVE FINISHED FLOOR.
- G. PANELBOARDS SHALL BE DEAD FRONT SAFETY TYPE WITH ANTI-BURN SOLDERLESS COMPRESSION APPROVED FOR COPPER CONDUCTORS, COPPER BUS BARS, FULL SIZED NEUTRAL BUS, GROUND BUS AND EQUIPPED WITH QUICK- MAKE QUICK-BREAK BOLT-IN TYPE THERMAL MAGNETIC CIRCUIT BREAKERS. MOUNT TOP OF THE PANELBOARDS AT 6'-3" ABOVE FINISHED FLOOR. PROVIDE TYPEWRITTEN CIRCUIT DIRECTORY.
- H. ALL CIRCUIT BREAKERS, MAGNETIC STARTERS AND OTHER ELECTRICAL EQUIPMENT SHALL HAVE AN INTERRUPTING RATING NOT LESS THAN MAXIMUM SHORT CIRCUIT CURRENT TO WHICH THEY MAY BE SUBJECTED.
- GROUND RODS SHALL BE COPPER CLAD STEEL, 5/8" ROUND AND 10' LONG. COPPER WELD OR APPROVED EQUAL.

INSTALLATION

- A. PROVIDE SUPPORTING DEVICES FOR ALL ELECTRICAL EQUIPMENT, FIXTURES, BOXES, PANEL, ETC., SUPPORT LUMINARIES FROM UNDERSIDE OF STRUCTURAL CEILING, EQUIPMENT SHALL BE BRACED TO WITHSTAND HORIZONTAL FORCES IN ACCORDANCE WITH STATE AND LOCAL CODE REQUIREMENTS. PROVIDE PRIOR ALIGNMENT AND LEVELING OF ALL DEVICES AND FIXTURES.
- B. CUTTING, PATCHING, CHASES, OPENINGS: PROVIDE LAYOUT IN ADVANCE TO ELIMINATE UNNECESSARY CUTTING OR DRILLING OF WALLS, FLOORS CEILINGS, AND ROOFS. ANY DAMAGE TO BUILDING STRUCTURE OR EQUIPMENT SHALL BE REPAIRED BY THE CONTRACTOR. OBTAIN PERMISSION FROM THE ENGINEER BEFORE CORING.
- C. IN DRILLING HOLES INTO CONCRETE WHETHER FOR FASTENING OR ANCHORING PURPOSES, OR PENETRATIONS THROUGH THE FLOOR FOR CONDUIT RUNS, PIPE RUNS, ETC., IT MUST BE CLEARLY UNDERSTOOD THAT TENDONS AND/OR REINFORCING STEEL WILL NOT BE DRILLED INTO, CUT OR DAMAGED UNDER ANY CIRCUMSTANCES.
- D. LOCATION OF TENDONS AND/OR REINFORCING STEEL ARE NOT DEFINITELY KNOWN AND THEREFORE, MUST BE SEARCHED FOR BY APPROPRIATE METHODS AND EQUIPMENT VIA X-RAY OR OTHER DEVICES THAT CAN ACCURATELY LOCATE THE REINFORCING AND/OR STEEL TENDONS.
- E. PENETRATIONS IN FIRE RATED WALLS SHALL BE FIRE STOPPED IN ACCORDANCE WITH THE REQUIREMENTS OF THE C.B.C.

PROJECT CLOSEOUT

- A. UPON COMPLETION OF WORK, CONDUCT CONTINUITY, SHORT CIRCUIT, AND FALL POTENTIAL GROUNDING TESTS FOR APPROVAL. SUBMIT TEST REPORTS TO PROJECT MANAGER. CLEAN PREMISES OF ALL DEBRIS RESULTING FROM WORK AND LEAVE WORK IN A COMPLETE AND UNDAMAGED CONDITION.
- B. PROVIDE PROJECT MANAGER WITH ONE SET OF COMPLETE ELECTRICAL "AS INSTALLED" DRAWINGS AT THE COMPLETION OF THE JOB, SHOWING ACTUAL DIMENSIONS, ROUTINGS AND CIRCUITS.
- C. ALL BROCHURES, OPERATING MANUALS, CATALOG, SHOP DRAWINGS, ETC., SHALL BE TURNED OVER TO OWNER AT JOB COMPLETION.

GROUNDING NOTES

- 1. ALL DETAILS ARE SHOWN IN GENERAL TERMS. ACTUAL GROUNDING INSTALLATION REQUIREMENTS AND CONSTRUCTION ACCORDING TO SITE CONDITIONS.
- 2. ALL GROUNDING CONDUCTORS: #2 AWG SOLID BARE TINNED COPPER WIRE UNLESS OTHERWISE NOTED.
- 3. GROUND BAR LOCATED IN BASE OF EQUIPMENT WILL BE PROVIDED, FURNISHED AND INSTALLED BY THE VENDOR.
- 4. ALL BELOW GRADE CONNECTIONS: EXOTHERMIC WELD TYPE, ABOVE GRADE CONNECTIONS: EXOTHERMIC WELD TYPE.
- 5. GROUND RING SHALL BE LOCATED A MINIMUM OF 24" BELOW GRADE OR 6" MINIMUM BELOW THE FROST LINE.
- 6. INSTALL GROUND CONDUCTORS AND GROUND ROD MINIMUM OF 1'-0" FROM EQUIPMENT CONCRETE SLAB, SPREAD FOOTING, OR FENCE.
- EXOTHERMIC WELD GROUND CONNECTION TO FENCE POST TREAT WITH A COLD GALVANIZED SPRAY.

8. GROUND BARS:

- 8.1. EQUIPMENT GROUND BUS BAR (EGB) LOCATED AT BOTTOM OF ANTENNA POLE/MAST FOR MAKING GROUNDING JUMPER CONNECTIONS TO COAX FEEDER CABLES SHALL BE FURNISHED AND INSTALLED BY ELECTRICAL CONTRACTOR. JUMPERS (FURNISHED BY OWNERS) SHALL BE INSTALLED AND CONNECTED BY ELECTRICAL CONTRACTOR.
- MAIN GROUND BUS BAR (MGB) LOCATED NEAR THE BASE OF THE RADIO EQUIPMENT CABINET(S) SHALL BE FURNISHED AND INSTALLED BY ELECTRICAL CONTRACTOR.
- 9. ALL GROUNDING INSTALLATIONS AND CONNECTIONS SHALL BE MADE BY ELECTRICAL CONTRACTOR.
- 10. OBSERVE N.E.C. AND LOCAL UTILITY REQUIREMENTS FOR ELECTRICAL SERVICE GROUNDING.
- 11. GROUNDING ATTACHMENT TO TOWER SHALL BE AS PER MANUFACTURER'S RECOMMENDATIONS OR AT GROUNDING POINTS PROVIDED (2 MINIMUM).
- 12. IF EQUIPMENT IS IN A C.L. FENCE ENCLOSURE, GROUND ONLY CORNER POSTS AND SUPPORT POSTS OF GATE. IF CHAIN LINK LID IS USED, THEN GROUND LID ALSO.
- 13. GROUNDING @ PPC CABINET SHALL BE VERTICALLY INSTALLED.
- 14. ALL GROUNDING FOR ANTENNAS SHALL BE CONNECTED SO THAT IT WILL BY-PASS MAIN BUSS BAR.
- 15. ALL EMT RUNS SHALL BE GROUNDED AND HAVE A BUSHING. NO PVC ABOVE GROUND.
- "DOUBLING-UP" OF LUGS. 17. POWER AND TELCO CABS. SHALL BE GROUNDED (BONDED)

16. USE SEPARATE HOLES FOR GROUNDING @ BUSS BAR. NO


TOGETHER.18. NO "L AND B" ALLOWED ON GROUNDING. 18. PROVIDE STAINLESS STEEL CLAM AND BRASS TAGS ON COAX @ ANTENNAS AND DOGHOUSE.

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CONSTRUCTION **DRAWINGS**

	SUBMITTALS					
REV	DATE	DESCRIPTION				
Α	04/26/24	90% CONSTRUCTION DRAWINGS				
В	08/29/24	JX COMMENTS				
0	03/12/24	100% CONSTRUCTION DRAWINGS				

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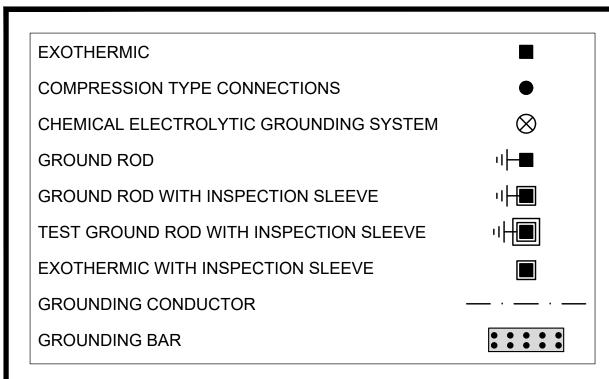
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SHEET TITLE

ELECTRICAL NOTES

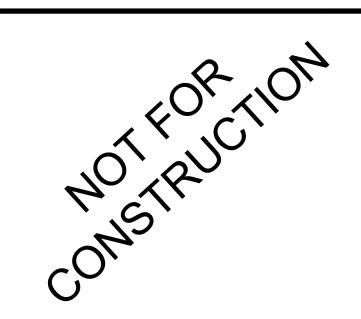SHEET NUMBER

2 | ELECTRICAL NOTES



THIS PLAN IS A SCHEMATIC ONLY AND DOES NOT SHOW ALL THE GROUNDING PROVIDED BY THE SHELTER MANUFACTURER. CONTRACTOR SHALL NOTIFY AT&T IF ANY GROUNDING TO BE PROVIDED IS INCOMPLETE OR MISSING.

NOTE: CONTRACTOR TO IMPLEMENT ALL GROUNDING REQUIREMENTS AS SPECIFIED BY CARRIER CONSTRUCTION AND INSTALLATION GUIDELINES.



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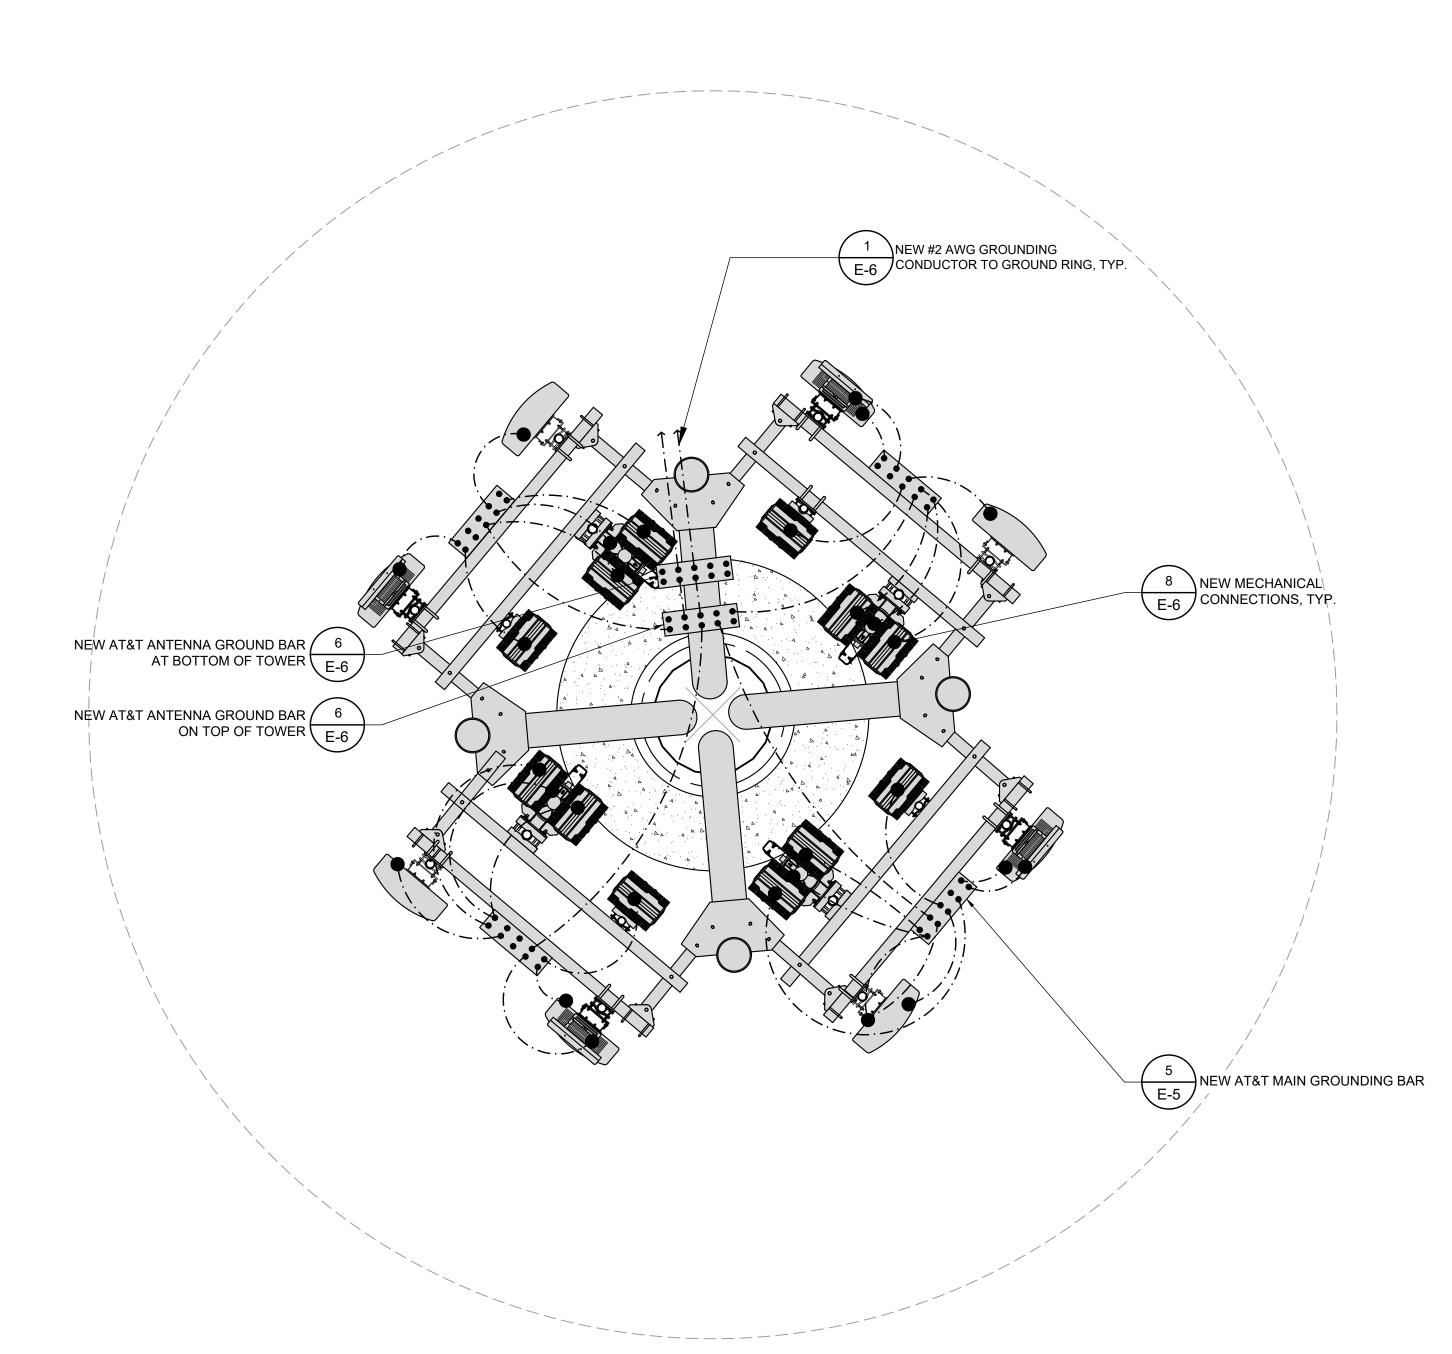
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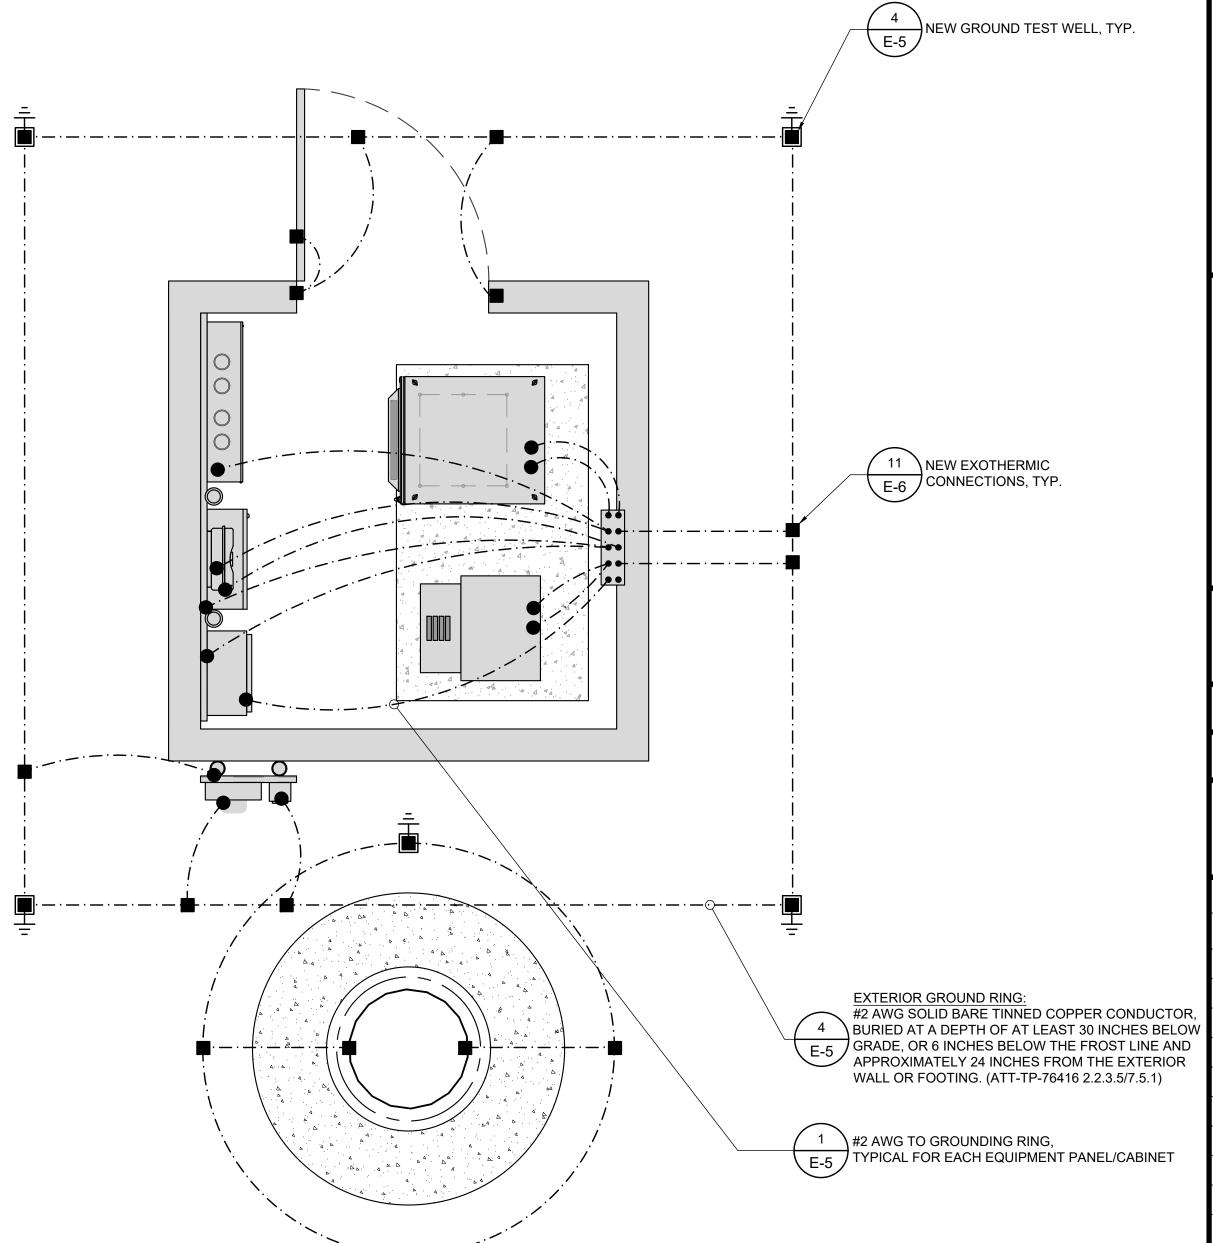
SHEET TITLE

GROUNDING PLANS

SHEET NUMBER

E-4







SCALE


0 6" 1' 2'

GROUNDING PLAN

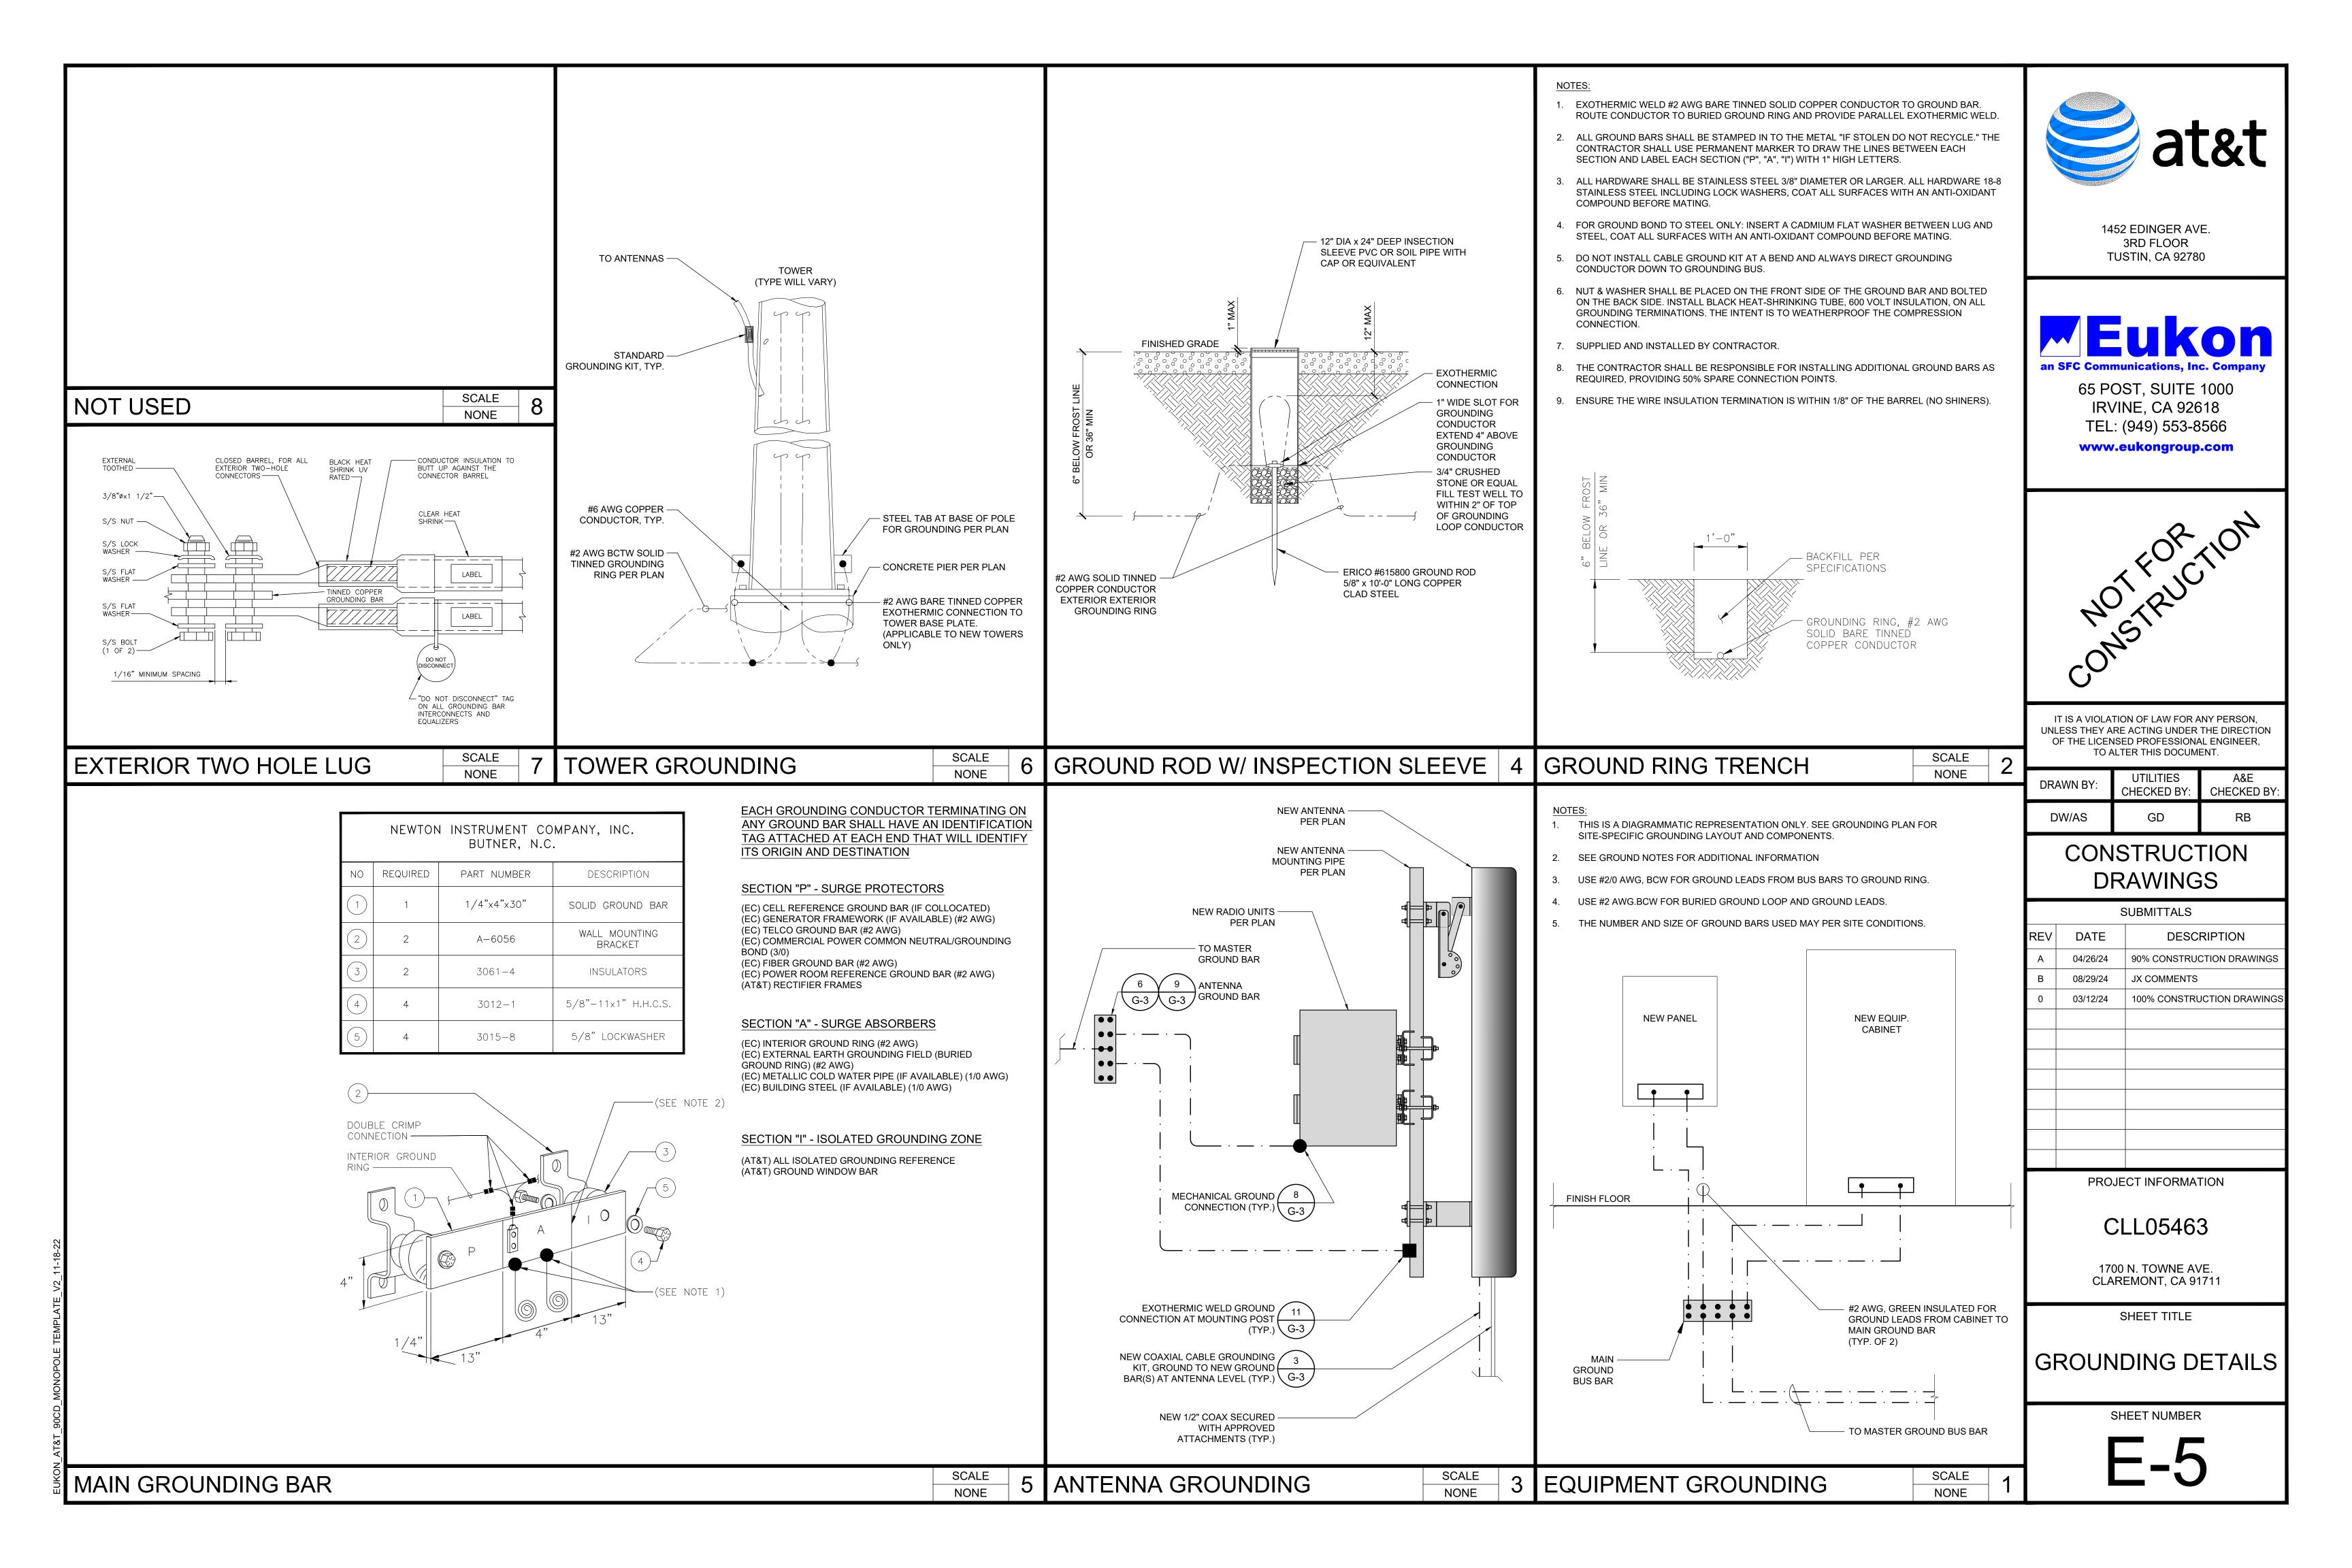

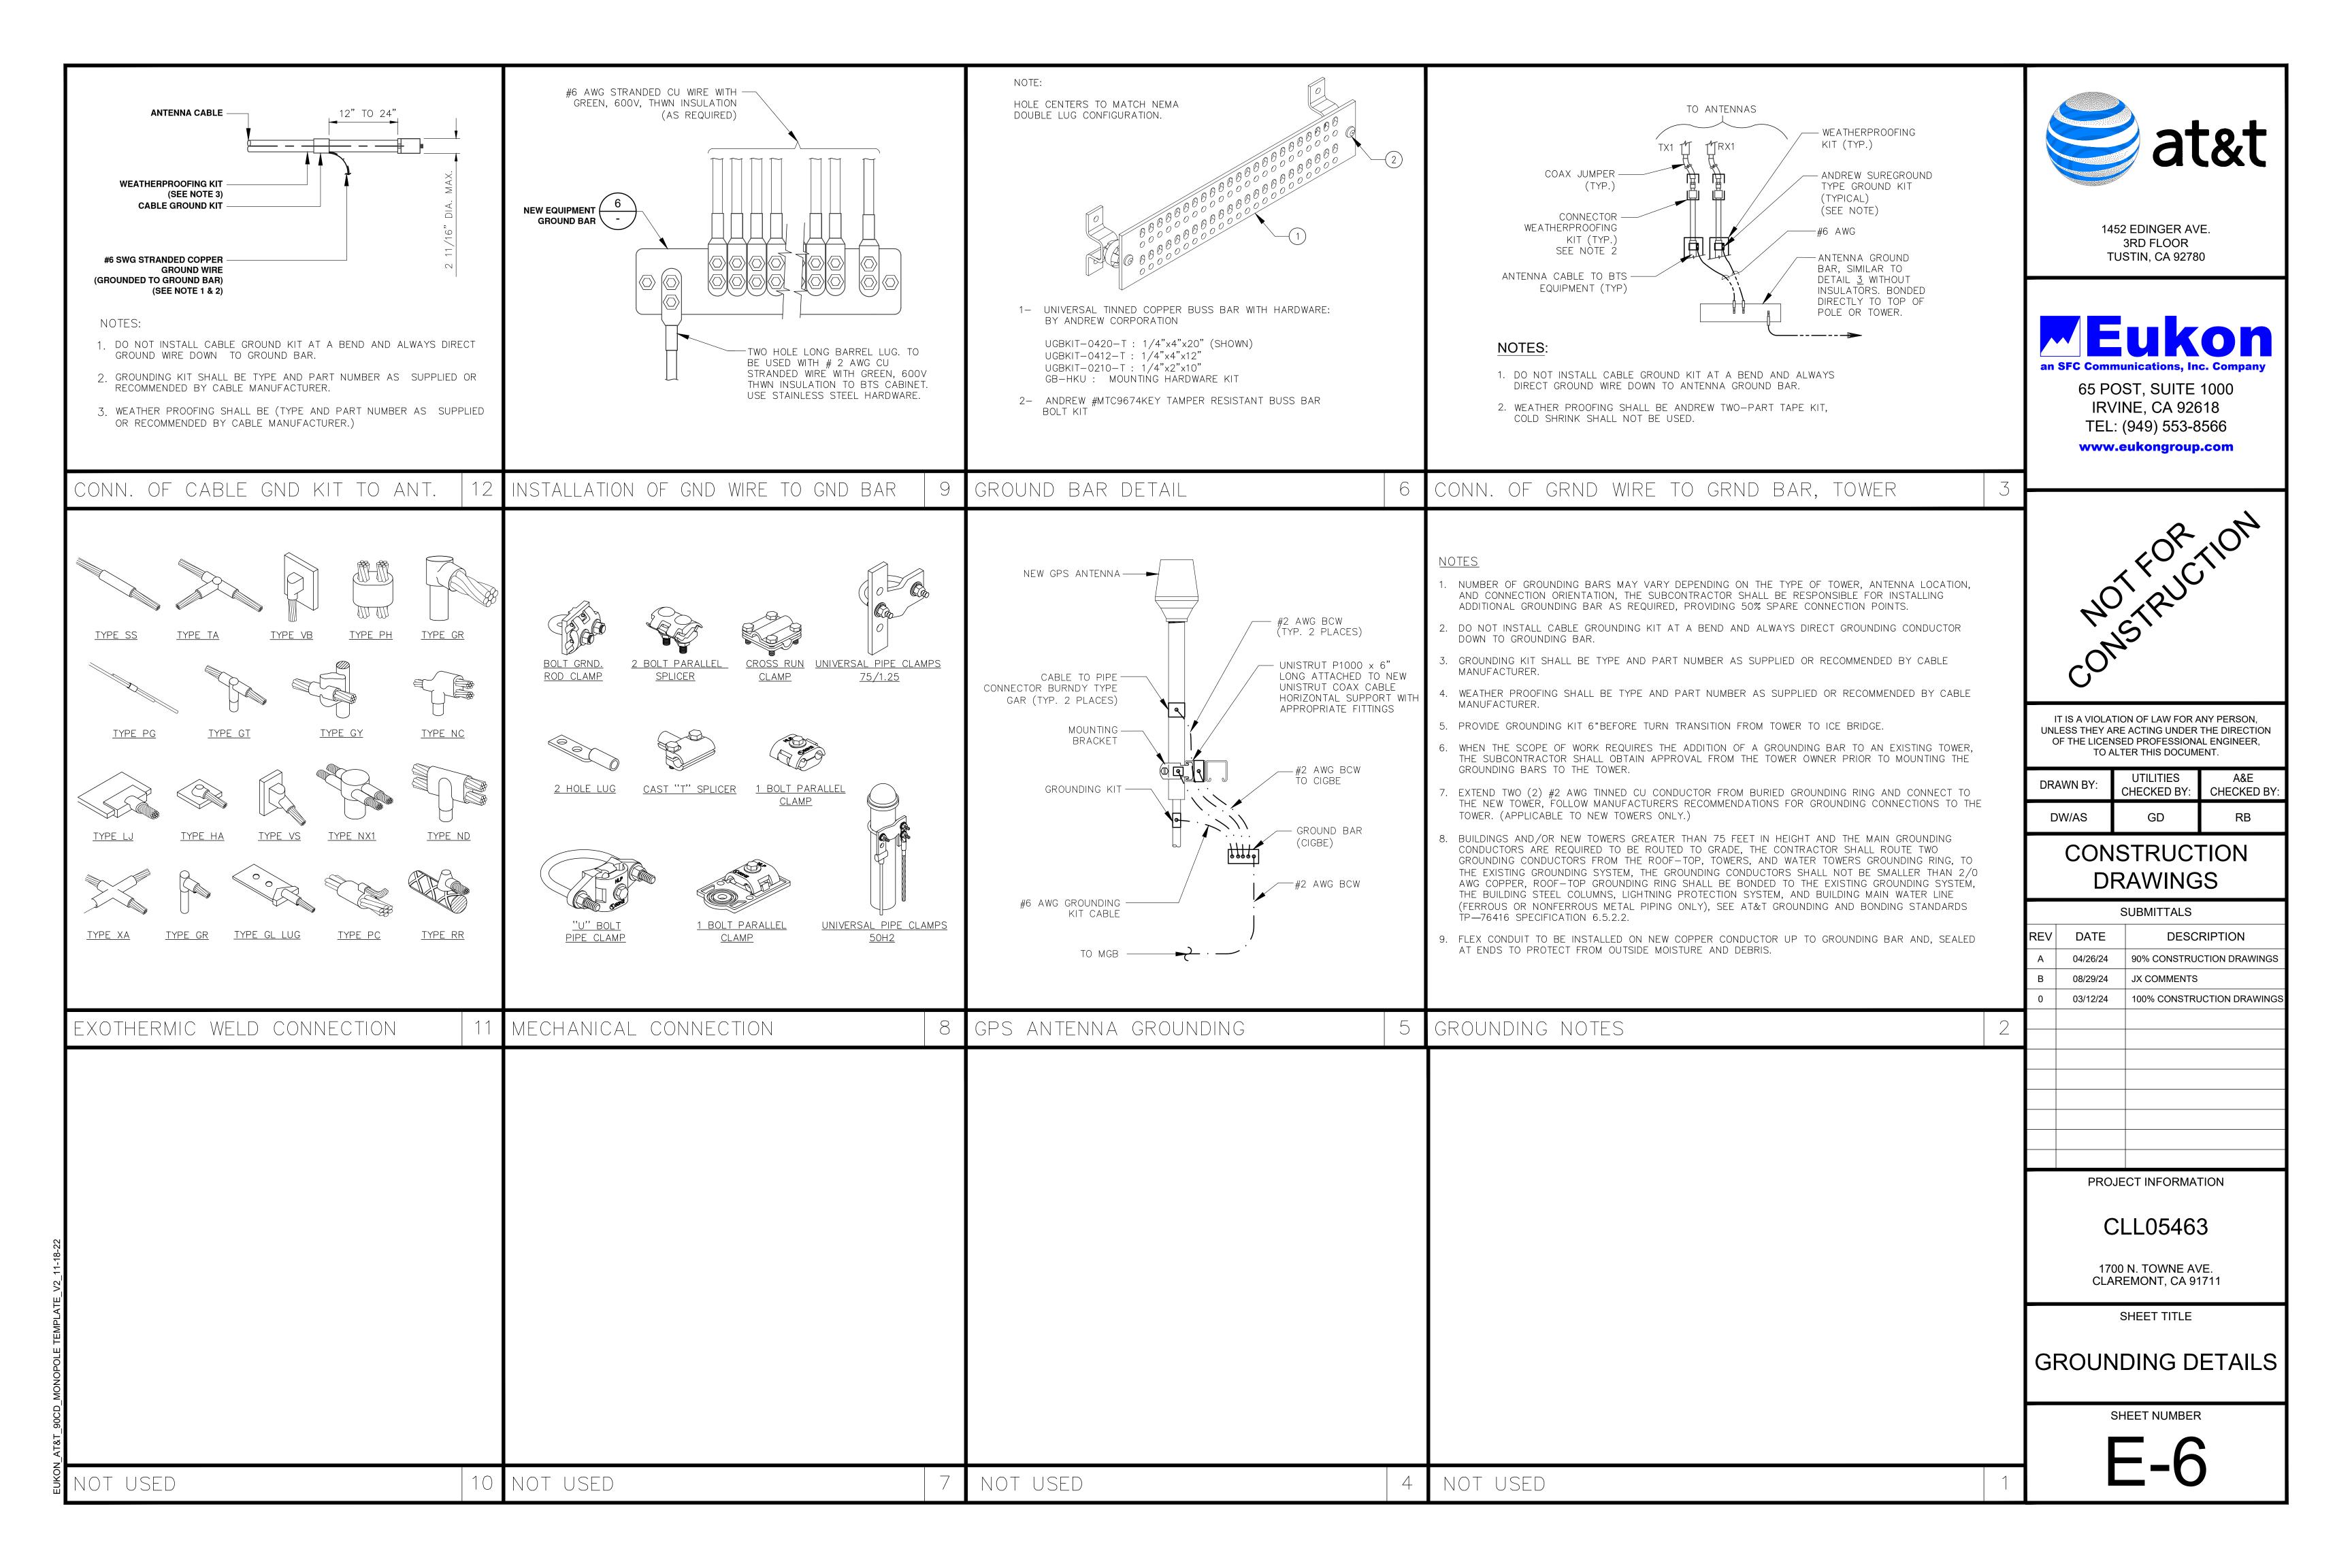



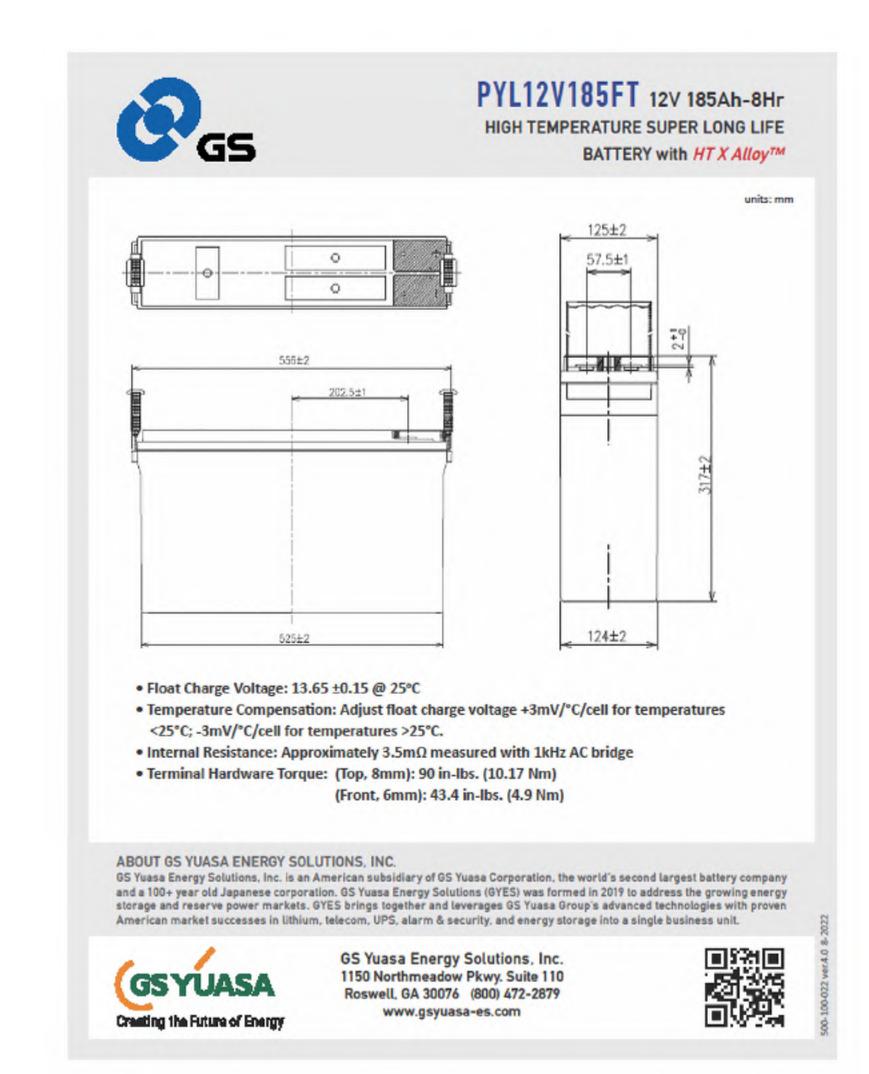

FIRE DEPARTMENT NOTES

GENERAL

1.0 ADDRESS NUMBERS:

A. APPROVED ADDRESS NUMBERS, BUILDING NUMBERS OR APPROVED BUILDING IDENTIFICATION SHALL BE PLACED IN A POSITION THAT PLAINLY LEGIBLE AND VISIBLE FROM THE STREET, ROAD, ALLEY, AND WALKWAYS GIVING ACCESS TO AND

2.0 FIRE EXTINGUISHERS:

A. PROVIDE A FIRE EXTINGUISHER (MINIMUM 2A-10BC) WITHIN A RECESSED OR SEMI-RECESSED CABINET WITHIN 75 FEET TRAVEL DISTANCE FROM ALL POINTS IN THE OCCUPANCY; THE EXTINGUISHER SHALL BE MOUNTED ON A HOOK WITHIN THE CABINET (ELEVATED OFF CABINET FLOOR); THE TOP OF THE EXTINGUISHER SHALL BE NO HIGHER THAN 48 INCHES (1219 mm) ABOVE THE FLOOR; EXTINGUISHER SHALL BE PLACED IN A EASILY ACCESSIBLE LOCATIONS WHERE THEY WILL BE READILY ACCESSIBLE AND IMMEDIATELY AVAILABLE FOR USE.

3.0 DOOR OPERATIONS:

A. ALL EXIT DOORS SHALL BE OPENABLE FROM THE INSIDE WITHOUT KEY, SPECIAL KNOWLEDGE, OR EFFORT. THE UNLATCHING OF ANY EXIT DOOR SHALL NOT REQUIRE MORE THAN ONE OPERATION.

4.0 ADDITIONAL PERMIT:

A. PRIOR TO THE FINAL INSPECTION, OBTAIN A HAZARDOUS MATERIALS PERMIT FROM THE FIRE DEPARTMENT. CONTACT THE ENVIRONMENTAL MANAGEMENT CENTER AT (916) 455-8200

5.0 REQUIRED INSPECTIONS:

- A. THE FIRE DEPARTMENT INSPECTION FOR THIS PROJECT INCLUDE THE FOLLOWING:
- 1. HAZARDOUS MATERIALS FINAL INSPECTION.
- 2. FIRE PREVENTION BUREAU FINAL INSPECTION CONTRACTOR MUST REQUEST A SEPERATE INSPECTION. INSPECTION.INCLUDES. BUT IS NOT LIMITED TO: FIRE EXTINGUISHERS; SIGNAGE; DOOR HARDWARE AND MEANS OF EGRESS; EMERGENCY/EXIT LIGHTING; ETC.

NOTE: TO SCHEDULE INSPECTIONS: CALL OFFICE OF STATE FIRE MARSHALL AT (916-445-8200) AT LEAST 48 HOURS IN ADVANCE.

BATTERY NOTES

PER CFC 2022 SECTION 1207.1.1 - STATIONARY STORAGE BATTERY SYSTEMS HAVING CAPACITIES EXCEEDING THE VALUES SHOWN IN TABLE 1207.1.1 SHALL COMPLY WITH SECTION 1207, AS APPLICABLE. SINCE THE TOTAL CAPACITY OF THE LEAD-ACID-TYPE BATTERY SYSTEM IS LESS THAN 70kWh THIS MODIFICATION IS EXEMPT FROM CFC 2022 SECTION 1207.

CAPACITY CALCULATION: (12 BATTERIES x 185Ah x 12V) / 1000 = 26.64kWh

2. DEFINITIONS PER CFC 2022 CHAPTER 2:

LEAD ACID BATTERY:
A STORAGE BATTERY THAT IS COMPRISED OF LEAD ELECTRODES IMMERSED IN A SOLUTION OF WATER AND SULPHURIC ACID ELECTROLYTE.


A CHEMICAL THAT CAUSES VISIBLE DESTRUCTION OF, OR IRREVERSIBLE ALTERATIONS IN, LIVING TISSUE BY CHEMICAL ACTION AT THE POINT OF CONTACT. A CHEMICAL SHALL BE CONSIDERED CORROSIVE IF, WHEN TESTED ON THE INTACT SKIN OF ALBINO RABBITS BY THE METHOD DESCRIBED IN DOTN 49 CFR 173.137, SUCH CHEMICAL DESTROYS OR CHANGES IRREVERSIBLY THE STRUCTURE OF THE TISSUE AT THE POINT OF CONTACT FOLLOWING AN EXPOSURE PERIOD OF 4 HOURS. THIS TERM DOES NOT REFER TO ACTION ON INANIMATE

HAZARDOUS MATERIALS:

THOSE CHEMICALS OR SUBSTANCES WHICH ARE PHYSICAL HAZARDS OR HEALTH HAZARDS AS DEFINED AND CLASSIFIED IN THIS CHAPTER, WHETHER THE MATERIALS ARE IN USABLE OR WASTE CONDITION.

HEALTH HAZARD:
A CLASSIFICATION OF A CHEMICAL FOR WHICH THERE IS STATISTICALLY SIGNIFICANT EVIDENCE THAT ACUTE OR CHRONIC HEALTH EFFECTS ARE CAPABLE OF OCCURRING IN EXPOSED PERSONS. THE TERM "HEALTH HAZARD" INCLUDES CHEMICALS THAT ARE TOXIC, HIGHLY TOXIC AND CORROSIVE.

A CHEMICAL FOR WHICH THERE IS EVIDENCE THAT IT IS A COMBUSTIBLE LIQUID, CRYOGENIC FLUID, EXPLOSIVE, FLAMMABLE (SOLID, LIQUID OR GAS), ORGANIC PEROXIDE (SOLID OR LIQUID), OXIDIZER (SOLID OR LIQUID), OXIDIZING GAS, PYROPHORIC (SOLID, LIQUID OR GAS), UNSTABLE (REACTIVÉ) MATERIAL (SOLID, LIQUID OR GAS) OR WATER-REACTIVE MATERIAL (SOLID OR LIQUID).

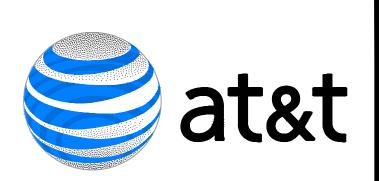


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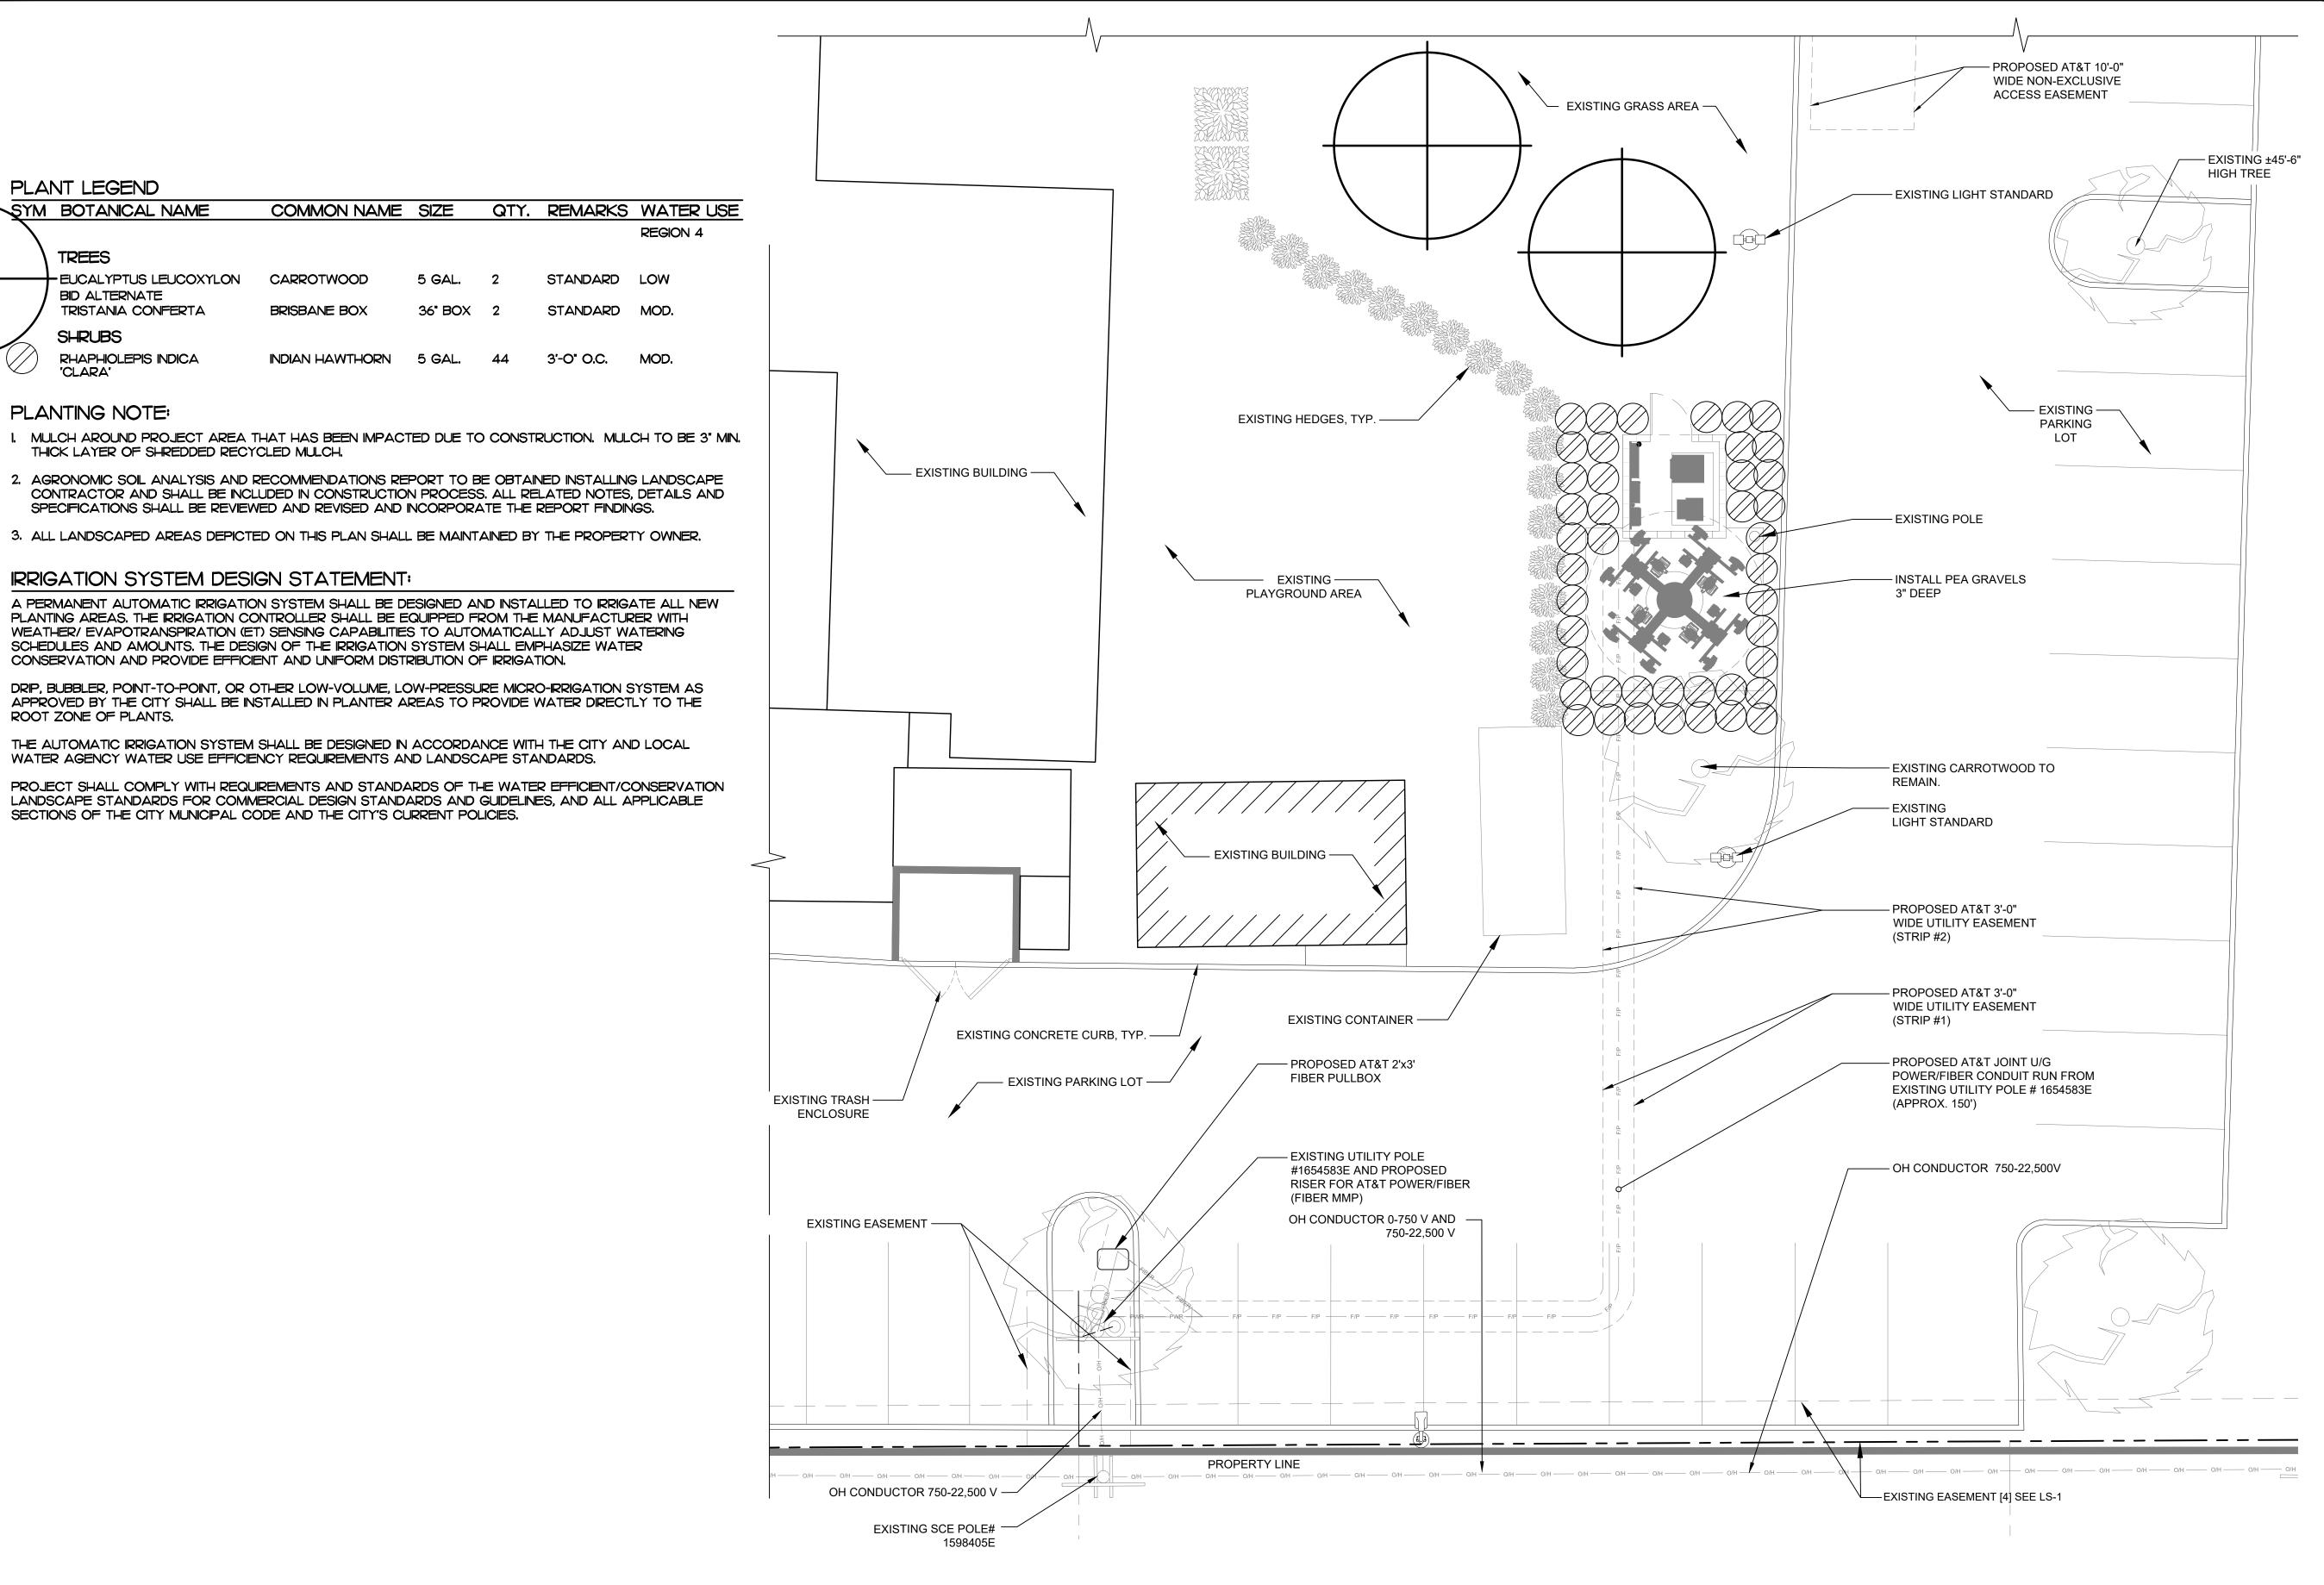
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SHEET TITLE

FIRE DEPARTMENT NOTES AND BATTERY INFORMATIO

SHEET NUMBER



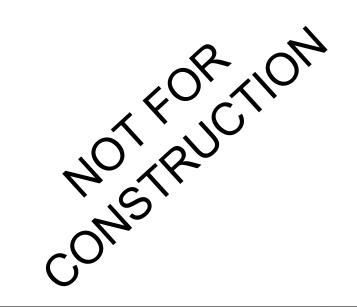




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SHEET TITLE:

PRELIMINARY LANDSCAPE PLAN

SHEET NUMBER:

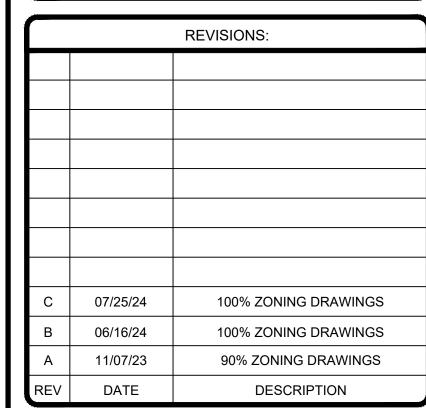PRELIMINARY LANDSCAPE PLAN

PLANT LEGEND

TREES

SHRUBS

'CLARA'

PLANTING NOTE:

ROOT ZONE OF PLANTS.

SYM BOTANICAL NAME

BID ALTERNATE

TRISTANIA CONFERTA

RHAPHIOLEPIS INDICA

EUCALYPTUS LEUCOXYLON CARROTWOOD

THICK LAYER OF SHREDDED RECYCLED MULCH.

IRRIGATION SYSTEM DESIGN STATEMENT:

BRISBANE BOX

INDIAN HAWTHORN 5 GAL.

SPECIFICATIONS SHALL BE REVIEWED AND REVISED AND INCORPORATE THE REPORT FINDINGS.

3. ALL LANDSCAPED AREAS DEPICTED ON THIS PLAN SHALL BE MAINTAINED BY THE PROPERTY OWNER.

WEATHER/ EVAPOTRANSPIRATION (ET) SENSING CAPABILITIES TO AUTOMATICALLY ADJUST WATERING

DRIP, BUBBLER, POINT-TO-POINT, OR OTHER LOW-VOLUME, LOW-PRESSURE MICRO-IRRIGATION SYSTEM AS APPROVED BY THE CITY SHALL BE INSTALLED IN PLANTER AREAS TO PROVIDE WATER DIRECTLY TO THE

THE AUTOMATIC IRRIGATION SYSTEM SHALL BE DESIGNED IN ACCORDANCE WITH THE CITY AND LOCAL

SCHEDULES AND AMOUNTS. THE DESIGN OF THE IRRIGATION SYSTEM SHALL EMPHASIZE WATER

CONSERVATION AND PROVIDE EFFICIENT AND UNIFORM DISTRIBUTION OF IRRIGATION.

WATER AGENCY WATER USE EFFICIENCY REQUIREMENTS AND LANDSCAPE STANDARDS.

SECTIONS OF THE CITY MUNICIPAL CODE AND THE CITY'S CURRENT POLICIES.

5 GAL.

36" BOX 2

REGION 4


STANDARD LOW

STANDARD MOD.

3'-0" O.C. MOD.

1/8"=1'-0"



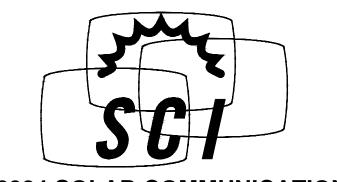

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AT&T

CLL05463
62'-0" QUAD-EUC

U.S. PATENT # 7616170 & 8035574

LOCATION:

1700 NORTH TOWNE AVENUE CLAREMONT, CA 91711 LOS ANGELES COUNTY

DRAWING INDEX

T1 TITLE SHEET

N1 NOTES & SPECIFICATIONS


S1 ELEVATION VIEWS

S2-S4 DETAILS

S5 FOUNDATION

TLE SHEET

US PATENT # 7616170 & 8035574 62'-0" QUAD-EUC 1700 NORTH TOWNE AVENUE

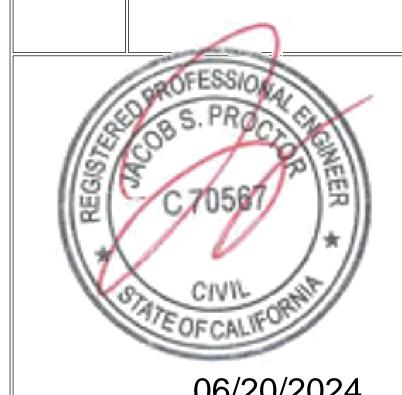

	00/20/2024		2024
DATE: 6/20/24		DESIGNED: EME	DRAFTER: EME
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T1

DESIGN CRITERIA

STRUCTURAL DESIGN IS BASED ON THE CALIFORNIA BUILDING CODE, 2022 EDITION (2021 IBC) AND THE TIA-222-H STANDARD

DESIGN LOADS:

WIND: WIND SPEED = 100 MPH (3-SEC GUST) PER THE ASCE 7-16 STANDARD
RISK CATEGORY: II
EXPOSURE: B
TOPOGRAPHIC CATEGORY: 1
CREST HEIGHT: 0 FT
ELEVATION: 1.250 FT ABOVE SEA LEVEL

ICE: NONE PER THE TIA-222-H STANDARD

SEISMIC:

IMPORTANCE FACTOR: 1.00
RISK CATEGORY: II

MAPPED SPECTRAL RESPONSE ACCELERATIONS:
 Ss = 1.737g, S1 = 0.654g
SITE CLASS: D
SPECTRAL RESPONSE COEFFICIENTS:
 Sps = 1.158g, Sp1 = 0.741g
SEISMIC DESIGN CATEGORY: D
BASIC SEISMIC-FORCE-RESISTING-SYSTEM:
 TELECOM: STEEL POLE
SEISMIC BASE SHEAR, V: 16.6 K
SEISMIC RESPONSE COEFFICIENT, Cs: 0.676
RESPONSE MODIFICATION FACTOR, R: 1.5
ANALYSIS PROCEDURE: EQUIVALENT LATERAL FORCE

STRUCTURAL STEEL

- 1. POLYGONAL MONOPOLE SHAFT STEEL SHALL CONFORM w/ ASTM A572 GR. 65, UNO.
- 2. BASEPLATE STEEL SHALL CONFORM w/ ASTM A572 GR 50, UNO.
- 3. ALL STEEL PIPE SHALL CONFORM w/ ASTM A53 GR B (35 KSI), UNO ACCEPTABLE PIPE MATERIAL ALTERNATIVES INCLUDE: A500 GR B., A106 GR B. AND API 5LX 42KSI.
- 4. ALL STEEL RECTANGULAR TUBES (HSS) SHALL CONFORM w/ ASTM A500 GR B (46 KSI),
- 5. REINFORCED PORT STEEL SHALL CONFORM w/ ASTM A572 GR 50, UNO.
- 6. ALL OTHER STEEL SHAPES & PLATES SHALL CONFORM w/ ASTM A36. UNO
- 7. ALL BOLTS FOR STEEL-TO-STEEL CONNECTIONS SHALL CONFORM w/ ASTM F3125 GR A325, UNO.
- 8. ALL U-BOLTS SHALL CONFORM w/ ASTM A36, UNO.
- 9. ALL ANCHOR BOLTS SHALL CONFORM w/ ASTM F1554 GR. 55. UNO.
- 10. ALL WELDING SHALL BE PERFORMED BY CERTIFIED WELDERS IN ACCORDANCE w/ THE LATEST VERSION OF THE AMERICAN WELDING SOCIETY AWS D1.1. STEEL WELDS SHALL BE BY E70XX LOW HYDROGEN ELECTRODES, UNO.
- 11. ALL STEEL SURFACES SHALL BE GALVANIZED IN ACCORDANCE w/ ASTM A123 AND ASTM F2329 STANDARDS.
- 12. ALL STRUCTURAL BOLTS SHALL BE TIGHTENED PER AN APPROVED PRETENSIONING METHOD AS DEFINED BY AISC. FOR EASE OF INSPECTION, THE "TURN-OF-NUT" METHOD AS DEFINED BY AISC WITH MATCH-MARKING TECHNIQUES IS RECOMMENDED.
- 13. ALL BOLT HOLES SHALL BE STANDARD SIZE PER TABLE J3.3 OF AISC UNO WASHERS ARE REQUIRED FOR ANY CONNECTION THAT HAS LARGER THAN STANDARD SIZED BOLT HOLES
- 14. ALL HEAVY HEX NUTS SHALL BE ASTM A563 GR C OR DH OR EQUIVALENT.
- 15. ALL HARDENED WASHERS SHALL BE ASTM F436 OR EQUIVALENT.

BASE DESIGN REACTIONS

MOMENT, M = 985 K-FT (1.0 WIND) SHEAR, V = 24.0 K (1.0 WIND) AXIAL, P = 29.4 K (1.2 DEAD)

GENERAL NOTES

- 1) CONTRACTOR SHALL FIELD VERIFY SITE OR LAYOUT RESTRICTIONS, SITE CONDITIONS, DIMENSIONS, AND ELEVATIONS BEFORE START OF CONSTRUCTION. ANY DISCREPANCIES SHALL BE BROUGHT TO THE ATTENTION OF SCI, INC. PRIOR TO BEGINNING PROJECT. ALL WORK SHALL BE PERFORMED USING ACCEPTED CONSTRUCTION PRACTICES. CONTRACTOR TO VERIFY MATERIALS PROVIDED BY SCI PRIOR TO INSTALLATION.
- 2) ALL ENGINEERING PLANS, DRAWINGS, DESIGNS, CALCULATIONS AND SPECIFICATIONS (COLLECTIVELY, "PLANS") ARE DESIGNED TO THE PROPRIETARY MANUFACTURING SPECIFICATIONS OF SOLAR COMMUNICATIONS INTERNATIONAL, INC. ("SCI") INTENDED AND AUTHORIZED SOLELY FOR USE WITH PRODUCT PRODUCED BY SCI. UNAUTHORIZED USE IS STRICTLY PROHIBITED. CUSTOMER AGREES TO DEFEND, INDEMNIFY AND HOLD SCI HARMLESS FROM AND AGAINST ANY AND ALL DEMANDS, CLAIMS, SUITS, PROCEEDINGS, LOSSES, LIABILITIES, DAMAGES, FEES, COSTS AND EXPENSES (INCLUDING, WITHOUT LIMITATION, REASONABLE ATTORNEYS' FEES AND COSTS) ARISING FROM OR RELATING TO ANY UNAUTHORIZED USE OF SCI'S PLANS BY CUSTOMER.
- 3) NO FIELD MODIFICATIONS MAY BE MADE TO STRUCTURE WITHOUT THE EXPRESS WRITTEN CONSENT FROM THE ENGINEER OF RECORD. SCI, INC AND ENGINEER OF RECORD ASSUME NO RESPONSIBILITY FOR THE STRUCTURE IF ALTERATIONS AND/OR ADDITIONS ARE MADE TO THE DESIGN AS SHOWN IN THESE DRAWINGS.
- 4) THE CONTRACTORS AND ALL SUBCONTRACTORS SHALL COMPLY WITH ALL LOCAL CODES, REGULATIONS, AND ORDINANCES AS WELL AS STATE DEPARTMENT OF INDUSTRIAL REGULATIONS AND DIVISION OF INDUSTRIAL SAFETY (OSHA) REQUIREMENTS.
- 5) THE CONTRACTOR SHALL SUPERVISE AND DIRECT ALL WORK TO THE BEST OF HIS/HER ABILITY AND SKILL. CONTRACTOR SHALL BE SOLELY RESPONSIBLE FOR ALL CONSTRUCTION MEANS, METHODS, TECHNIQUES, PROCEDURES, AND SEQUENCES, AND FOR COORDINATING ALL PORTIONS OF THE WORK UNDER THE CONTRACT.
- 6) THE CONTRACTOR SHALL VERIFY, COORDINATE, AND PROVIDE ALL NECESSARY BLOCKING, BACKING, FRAMING, HANGERS OR OTHER SUPPORTS FOR ALL ITEMS REQUIRING SAME. WHETHER SHOWN OR NOT. THE CONTRACTOR SHALL BE RESPONSIBLE FOR ALL TEMPORARY BRACING, SHORING, FORMWORK, ETC., AND SHALL CONFORM TO ALL NATIONAL, STATE, AND LOCAL ORDINANCES AND CODES, IN ORDER TO SAFELY EXECUTE ALL STAGES OF WORK TO COMPLETE THIS PROJECT.
- 7) IT IS THE INTENT OF THESE DRAWINGS TO SHOW THE COMPLETED INSTALLATION OF THE STRUCTURE SHOWN.
- 8) CONTRACTOR ASSUMES RESPONSIBILITY FOR JOB SITE CONDITIONS DURING THE COURSE OF CONSTRUCTION OF THE PROJECT. INCLUDING THE SAFETY OF ALL PERSONS AND PROPERTY IN ACCORDANCE WITH GENERALLY ACCEPTED CONSTRUCTION PRACTICES. THIS REQUIREMENT APPLIES CONTINUOUSLY, AND IS NOT LIMITED TO NORMAL WORKING HOURS.
- 9) IT IS THE RESPONSIBILITY OF THE CONTRACTOR TO LOCATE ALL EXISTING UTILITIES, SHOWN OR NOT SHOWN. THE CONTRACTOR IS FINANCIALLY RESPONSIBLE FOR REPAIR OR REPLACEMENT OF UTILITIES OR OTHER PROPERTY DAMAGED IN CONJUNCTION WITH THE EXECUTION OF WORK ON THIS PROJECT.
- 10) BRANCHES OR OTHER DESIGN TECHNIQUE SHALL BE USED TO DISGUISE THE TRANSITION FROM THE MAIN TRUNK TO THE TRI-ARMS.
- 11) ANTENNA COVERS SHALL CONSIST OF A DURABLE MATERIAL MATCHED TO THE COLOR OF THE TREE EMBEDDED WITH LEAVES MATCHING THE LEAF DENSITY OF THE TREE.
- 12) THE MAIN TRUNK, TRI-ARMS AND BRANCHES SHALL HAVE FULL BARK CLADDING, COMPLETE WITH
- CURLED PIECES OF BARK EXTENDING FROM THE STRUCTURE.


 13) ALL MOUNTING HARDWARE, CABLING, NUTS AND BOLTS, AND OTHER EQUIPMENT, INCLUDING TOWER MOUNTED AMPLIFIERS, USED ON THE MONOEUCALYPTUS TREE SHALL BE PAINTED TO MATCH THE TREE DESIGN.
- 14) ALL CABLING SHALL BE WIRED INTERNAL TO THE TREE STRUCTURE TO THE EXTENT POSSIBLE
- 15) ALL GALVANIZED SURFACES MUST BE TOUCHED UP WITH ZINC-RICH "COLD-GALV" COMPOUND AFTER FIELD DRILLING OR MINOR DAMAGE CAUSED DURING SHIPPING AND INSTALLATION.

SPECIAL INSPECTIONS, TESTING & STRUCTURAL OBSERVATION

- STEEL FABRICATION SHALL BE DONE ON THE PREMISES OF A FABRICATOR REGISTERED AND APPROVED AS REQUIRED BY THE BUILDING OFFICIAL TO PERFORM SUCH WORK WITHOUT SPECIAL INSPECTION. ALTERNATIVELY, SPECIAL INSPECTION OF MATERIALS, WELDING, AND FABRICATION PROCEDURES SHALL BE REQUIRED FOR FABRICATION BY AN UNAPPROVED FABRICATOR.
- 2. NO FIELD WELDING SHALL BE PERMITTED
- 3. NONDESTRUCTIVE TESTING IS REQUIRED FOR CJP GROOVE WELDS IN MATERIAL 5/16" THICK OR GREATER.
- 4. THE FOLLOWING SPECIAL INSPECTIONS SHALL BE REQUIRED PER CHAPTER 17 OF THE BUILDING CODE:
 - SPECIAL INSPECTION OF HIGH-STRENGTH BOLTING (WHEN APPLICABLE)
 - PERIODIC SPECIAL INSPECTION IF BOLTS ARE PRETENSIONED WITH MATCH-MARKING TECHNIQUES
 - CONTINUOUS SPECIAL INSPECTION OF ALL OTHER HIGH-STRENGTH BOLTING
 - PERIODIC SPECIAL INSPECTION OF PLACEMENT OF REINFORCING STEEL
 - CONTINUOUS SPECIAL INSPECTION OF ANCHOR BOLTS PRIOR TO AND DURING CONCRETE PLACEMENT
 - · CONTINUOUS SPECIAL INSPECTION OF CONCRETE PLACEMENT
 - · CONTINUOUS SPECIAL INSPECTION OF DRILLING OPERATIONS FOR PIER FOUNDATIONS
 - CONTINUOUS SPECIAL INSPECTION TO VERIFY LOCATION, PLUMBNESS, DIAMETER, AND LENGTH OF PIER FOUNDATIONS
 - SAMPLING & TESTING OF CONCRETE PER CHAPTER 17 OF THE BUILDING CODE TO VERIFY STRENGTH AND SLUMP
- 4. SPECIAL INSPECTION IS NOT REQUIRED FOR WORK OF A MINOR NATURE OR AS WARRANTED BY CONDITIONS IN THE JURISDICTION AS APPROVED BY THE BUILDING OFFICIAL. THUS, SPECIAL INSPECTION ITEMS ABOVE MAY BE WAIVED AS DEEMED APPROPRIATE BY THE BUILDING OFFICIAL.
- 5. NO STRUCTURAL OBSERVATION IS REQUIRED UNLESS NOTED IN CHAPTER 17 OF THE BUILDING CODE OR BY THE JURISDICTION.

DISCLAIMERS

- 1. ALL STRUCTURAL COMPONENTS TO BE CONNECTED TOGETHER SHALL BE COMPLETELY FIT UP ON THE GROUND OR OTHERWISE VERIFIED FOR COMPATIBILITY PRIOR TO LIFTING ANY COMPONENT INTO PLACE. REPAIRS REQUIRED DUE TO FIT-UP OR CONNECTION COMPATIBILITY PROBLEMS AFTER PARTIAL ERECTION ARE THE FINANCIAL RESPONSIBILITY OF THE CONTRACTOR.
- 2. SOME TELECOMMUNICATION STRUCTURES ARE SUSCEPTIBLE TO WIND-INDUCED OSCILLATIONS. OSCILLATIONS MAY OCCUR AT LOW OR MODERATE WIND SPEEDS AND MAY CAUSE STRUCTURAL DAMAGE. TIA PROVIDES NO PRACTICAL ANALYTICAL METHOD TO PREDICT AND PREVENT WIND-INDUCED STRUCTURAL OSCILLATIONS. VECTOR STRUCTURAL ENGINEERING RECOMMENDS FREQUENT MONITORING TO IDENTIFY WIND-INDUCED OSCILLATION AND REGULAR CONDITION ASSESSMENTS TO IDENTIFY FATIGUE CRACKING, LOOSE OR MISSING BOLTS, AND ANY OTHER STRUCTURAL DEFECTS. ANY OSCILLATION OR DEFECTS OBSERVED SHALL BE IMMEDIATELY REPORTED TO VECTOR STRUCTURAL ENGINEERING FOR FURTHER EVALUATION AND POSSIBLE REPAIRS OR MODIFICATIONS WHICH MAY BE REQUIRED AT THE OWNER'S EXPENSE.
- 3. WHERE EFFECTIVE PROJECTED AREAS (EPA) ARE USED, IT IS THE RESPONSIBILITY OF OTHERS TO VERIFY INSTALLED EQUIPMENT DOES NOT EXCEED LISTED EPA.

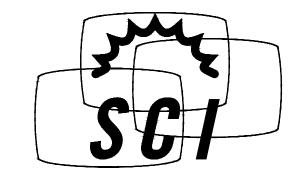

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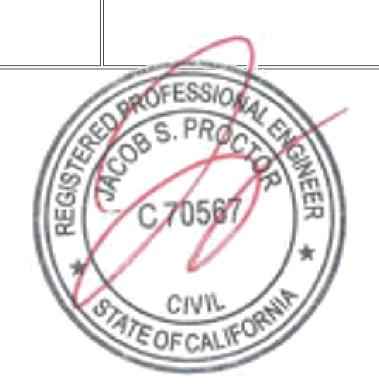
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62'-0" QUAD-E
1700 NORTH TOWNE /
CLAREMONT, CA 9

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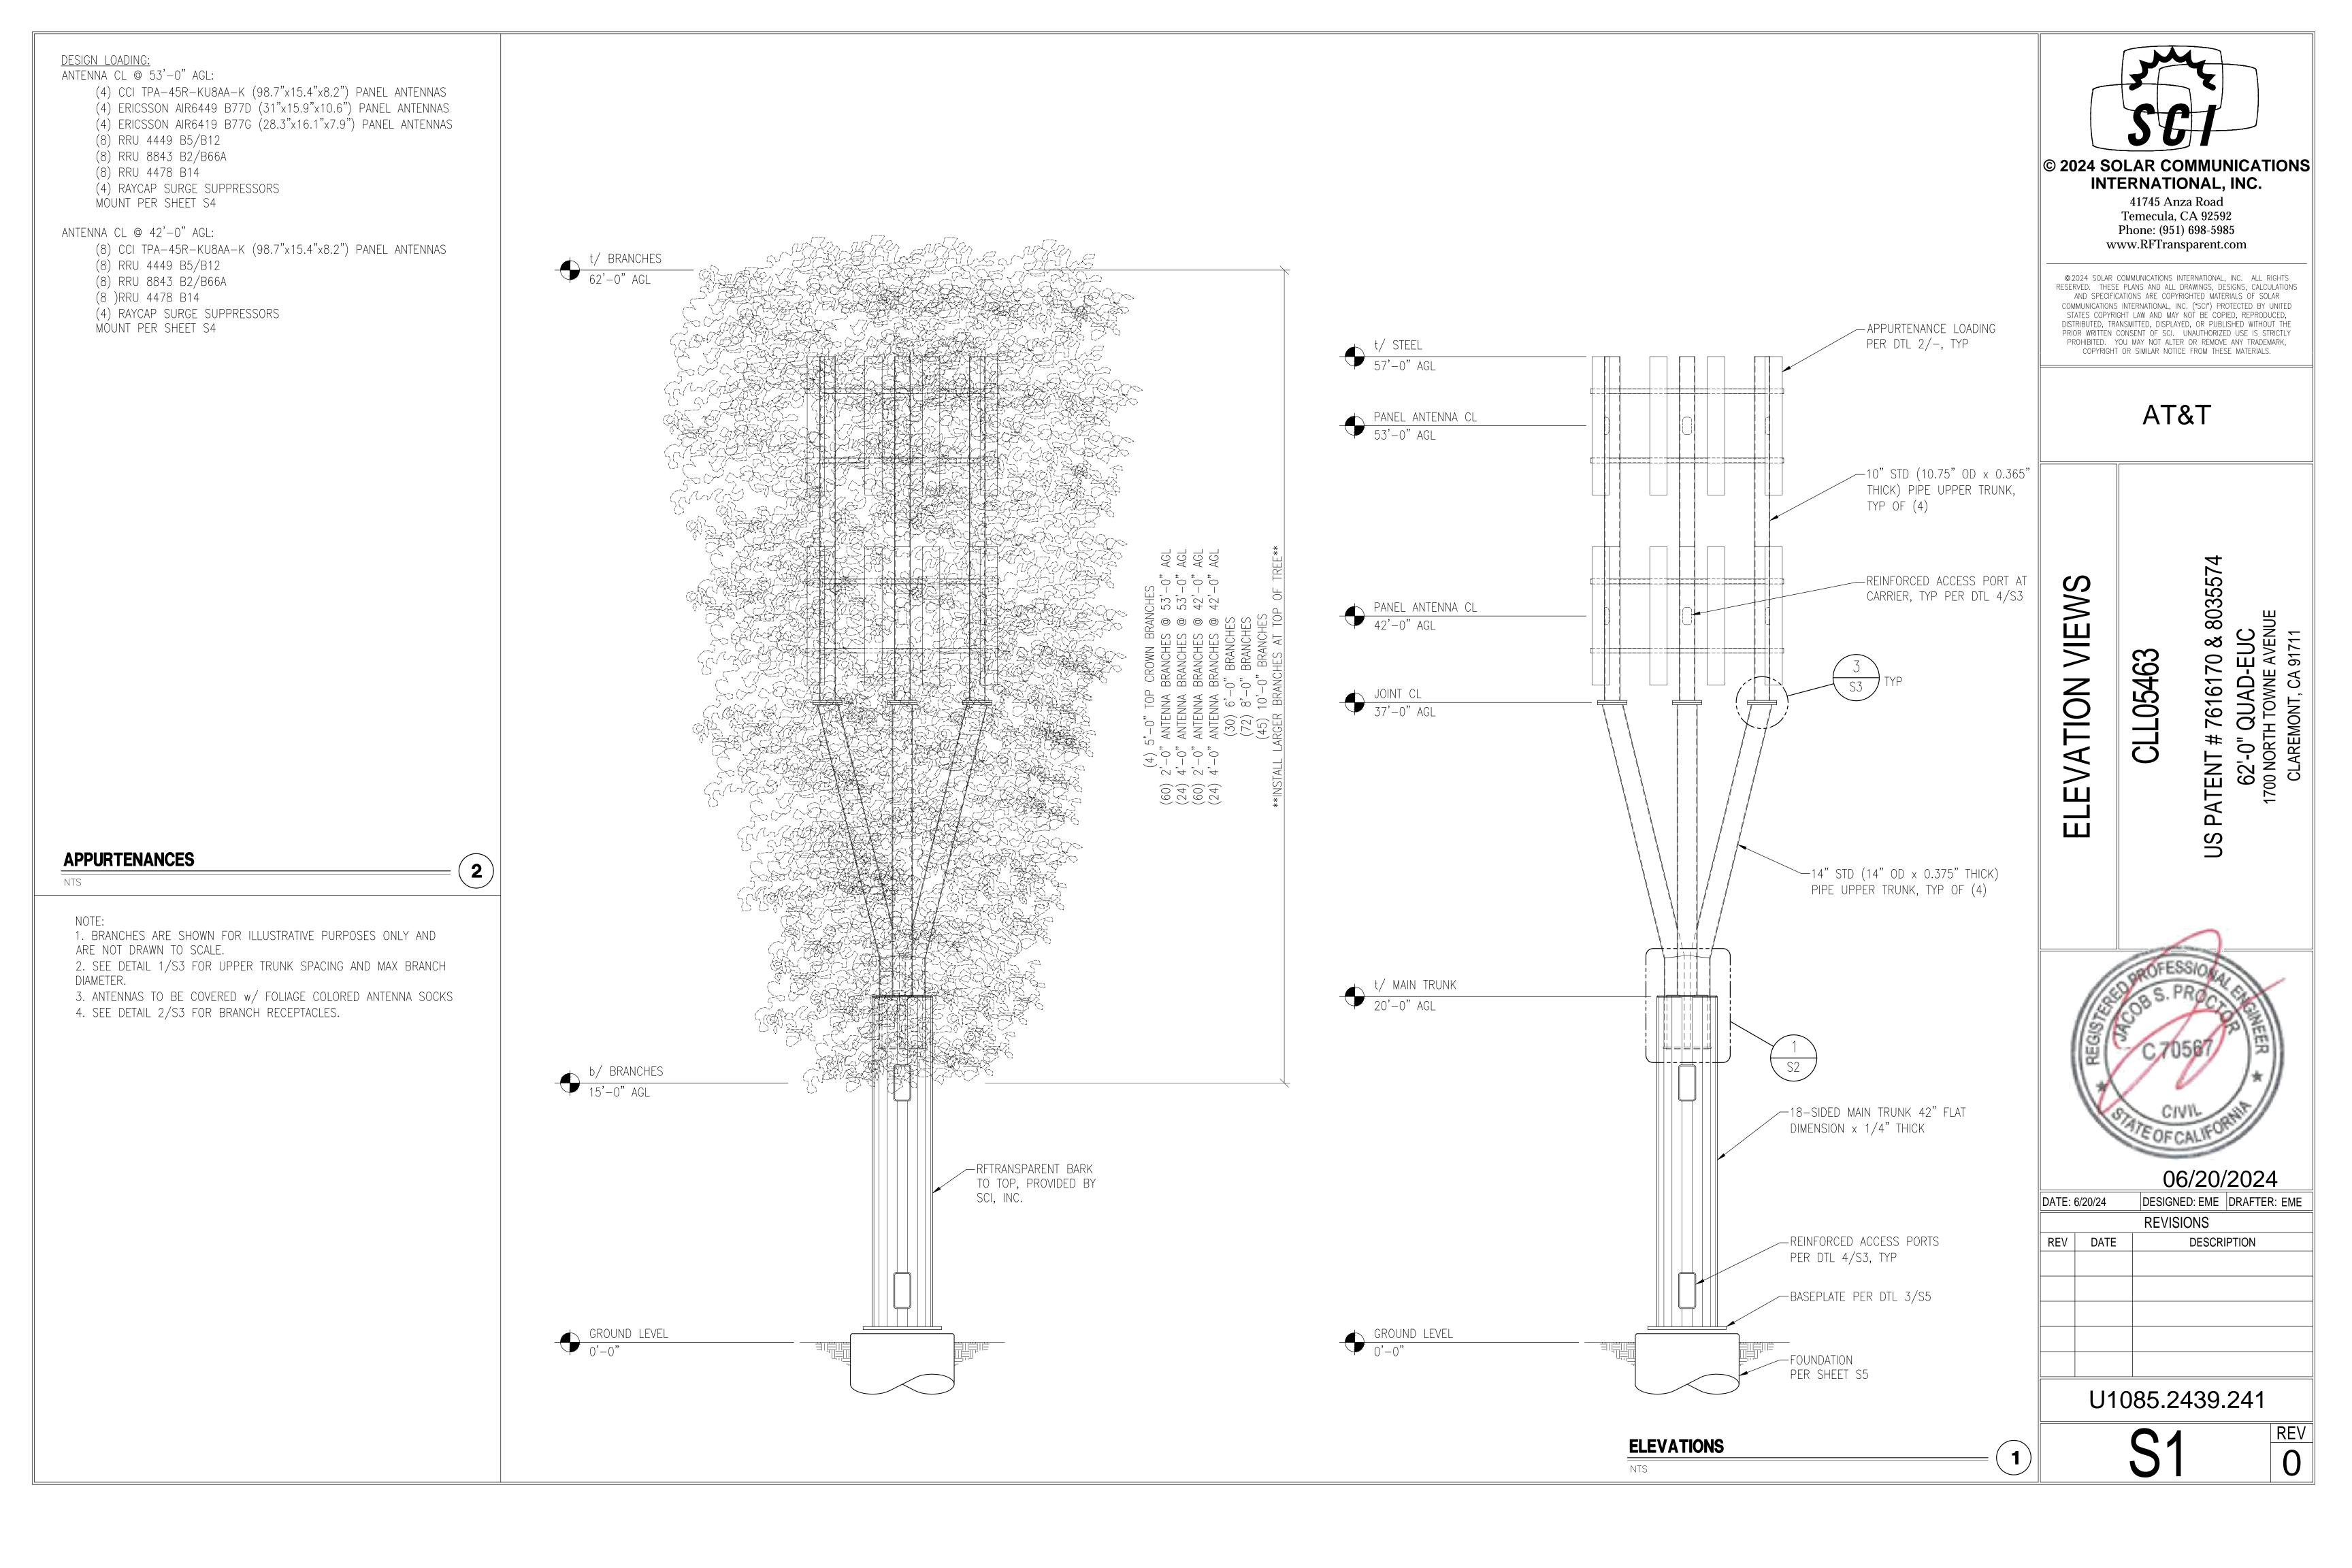
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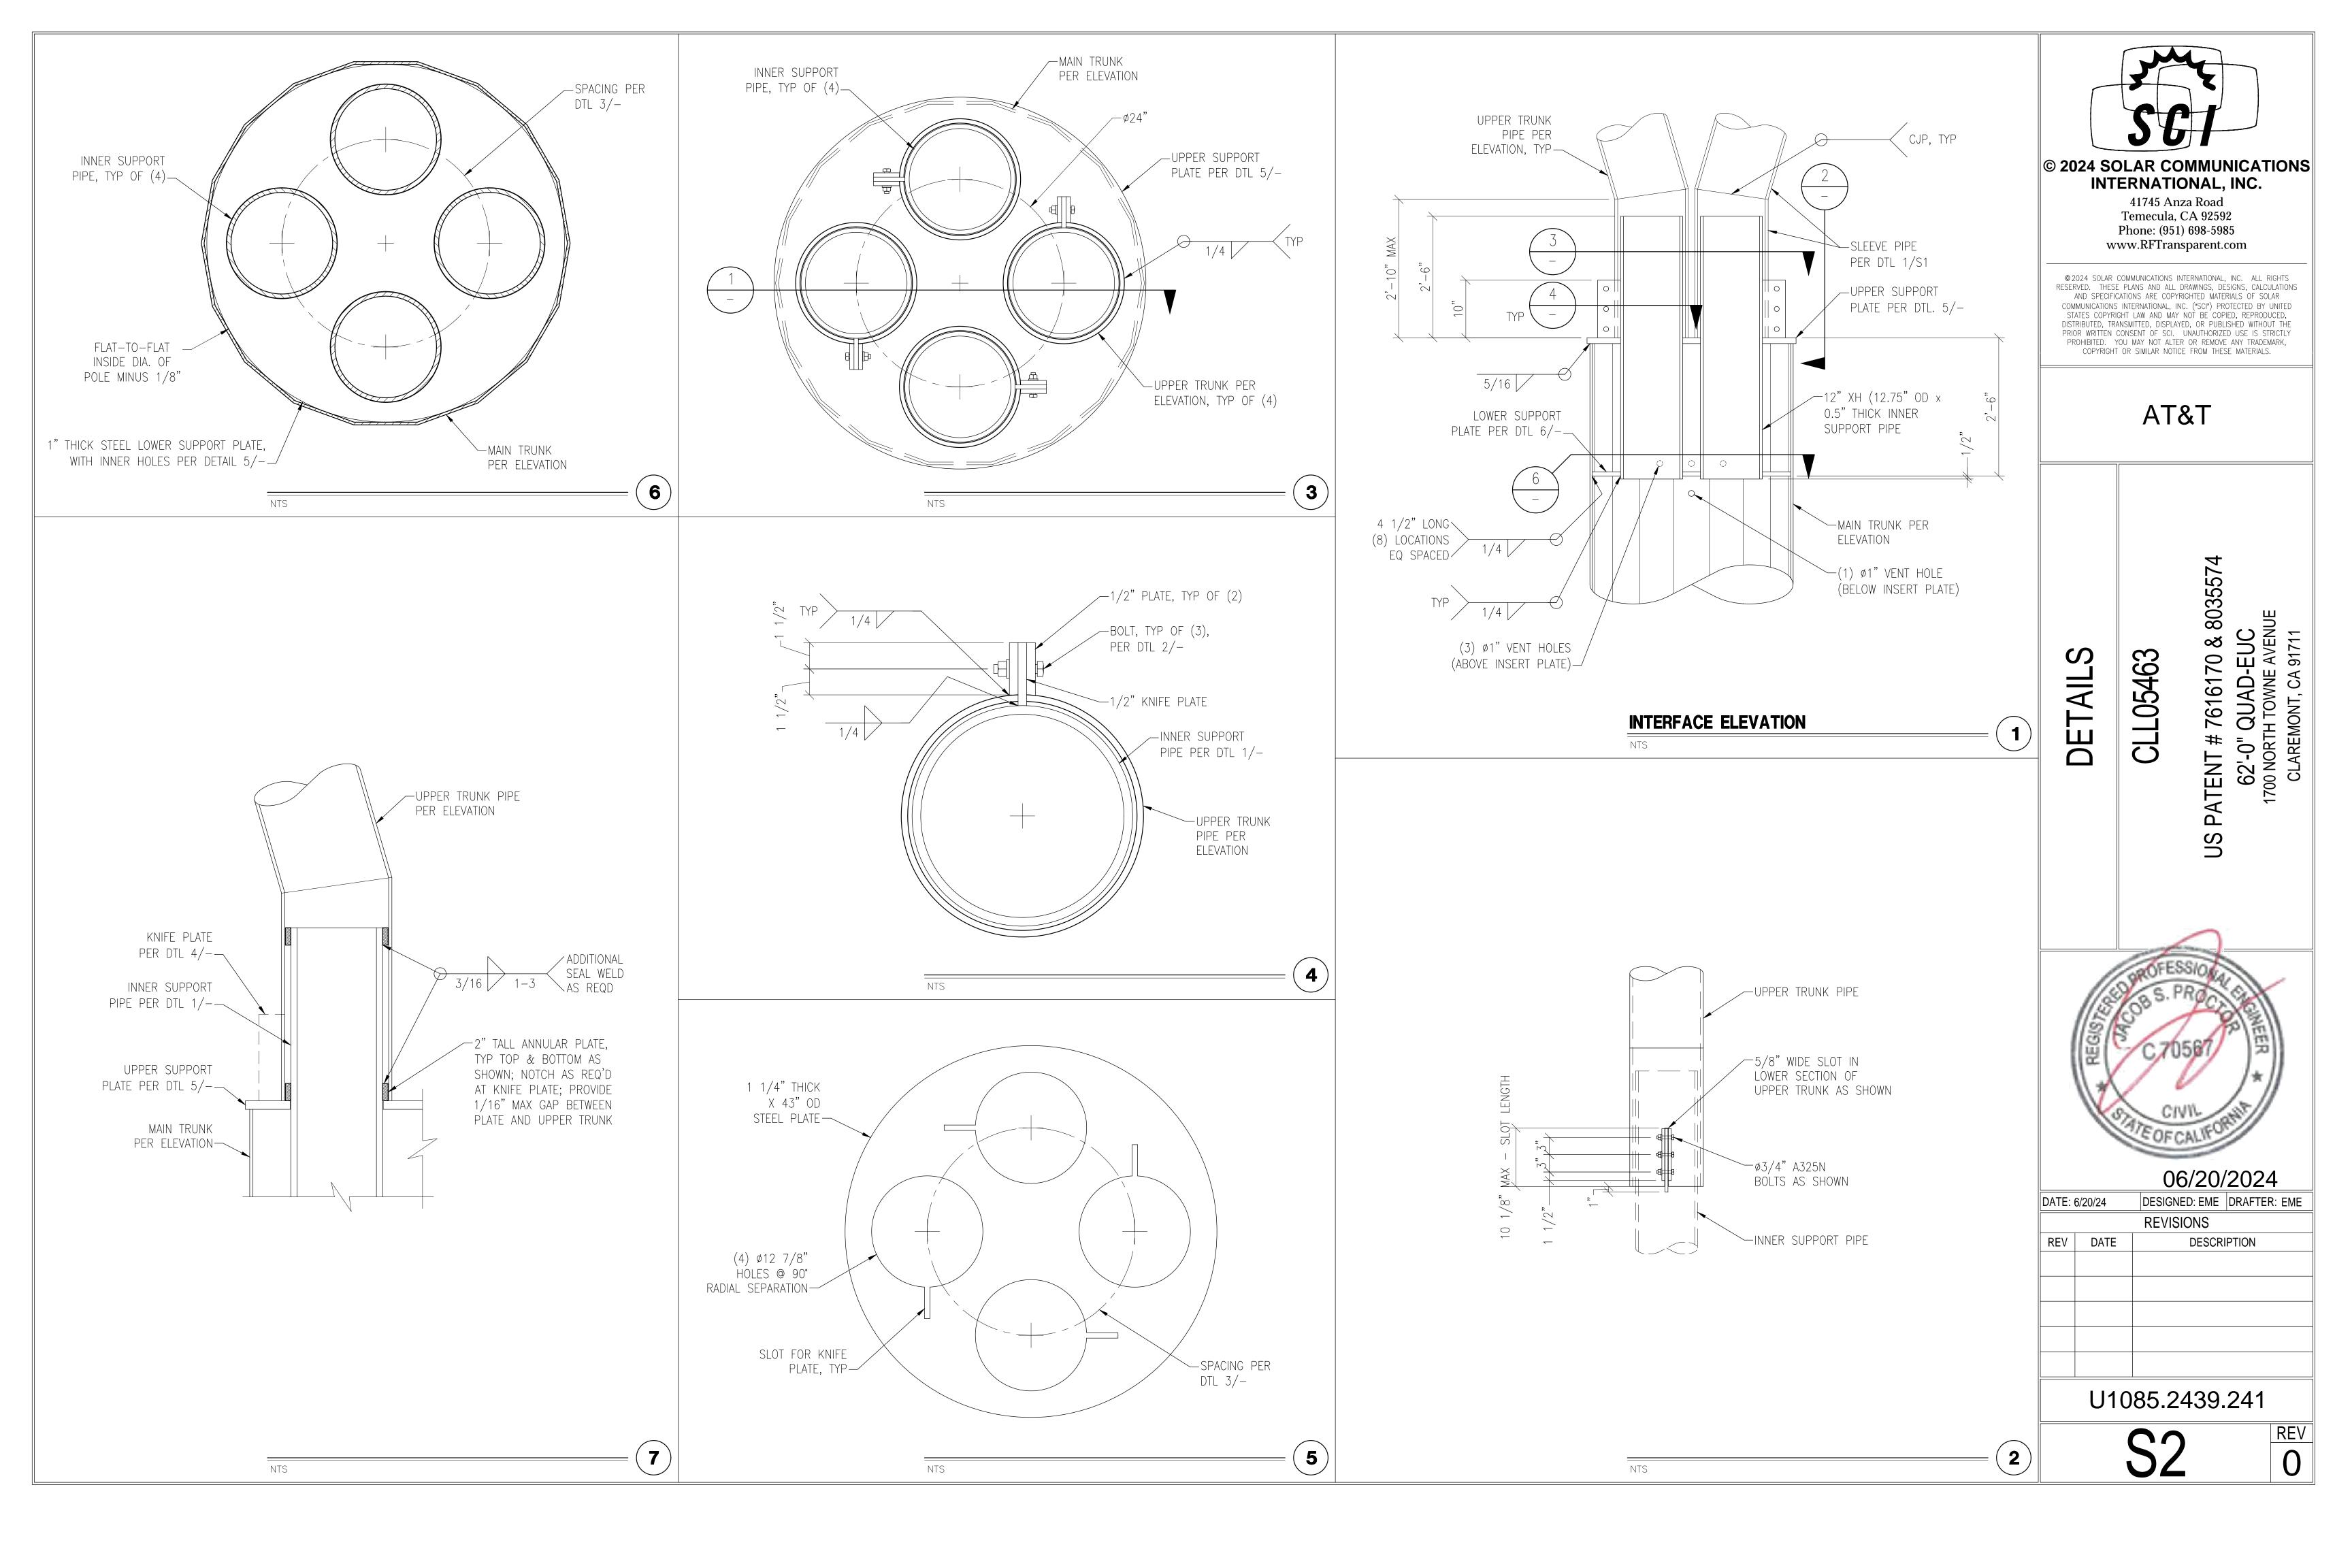
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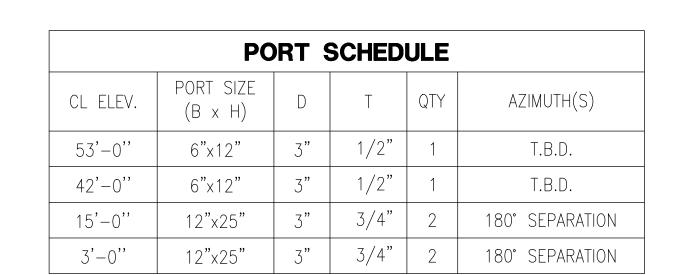
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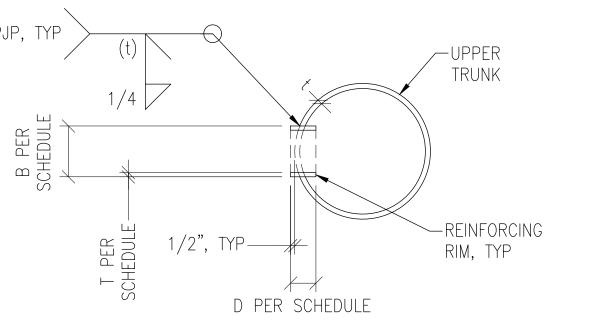







- SEE SCHEDULE FOR PORT QUANTITY & AZIMUTHS.
 SEE SHEET S1 FOR POLE SHAFT THICKNESS, t.
 SEE GENERAL NOTES FOR REINFORCED PORT MATERIAL GRADE.
 H REPRESENTS THE PORT HEIGHT OUT-TO-OUT.

B PER SCHEDULE T PFR	(t) 1/4 1/2", TYF	D PER SCHEDULE	REINFORCING RIM, TYP
	S	D PER SCHEDULE	



REINFORCED ACCESS PORTS

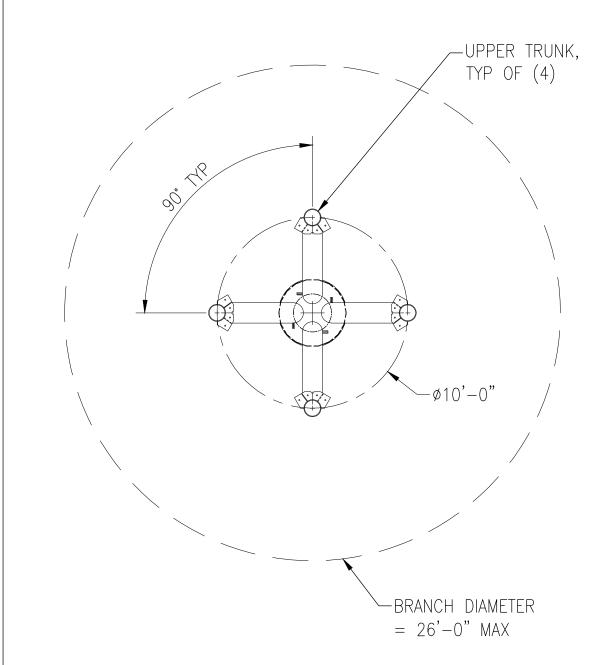



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PATENT # 7616170 & 803: 62'-0" QUAD-EUC 1700 NORTH TOWNE AVENUE CLAREMONT, CA 91711

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DETAILS

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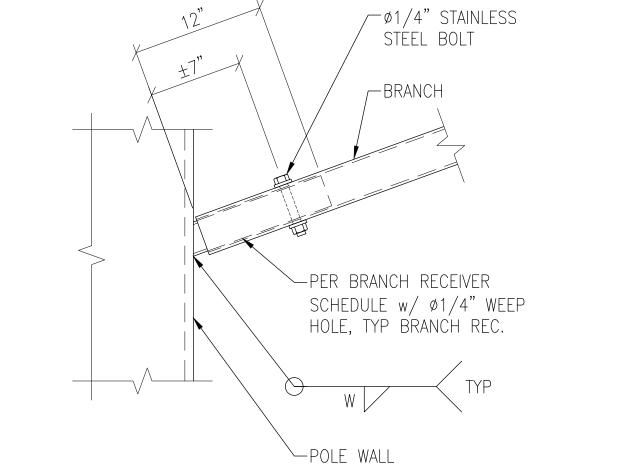
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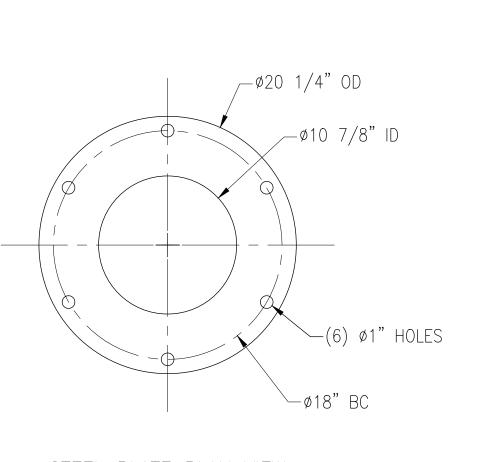
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BRANCH RECEIVER SCHEDULE			
RANCH ENGTH	YIELD STRENGTH (KSI)	SIZE	W
1'-0"	35	1 1/4" SCH 40	3/16
6'-0"	35	1 1/4" SCH 40	3/16
3'-0"	35	1 1/4" SCH 40	3/16
0'-0"	35	1 1/4" SCH 40	3/16




BRANCH	RECEPTACLE,	TYP
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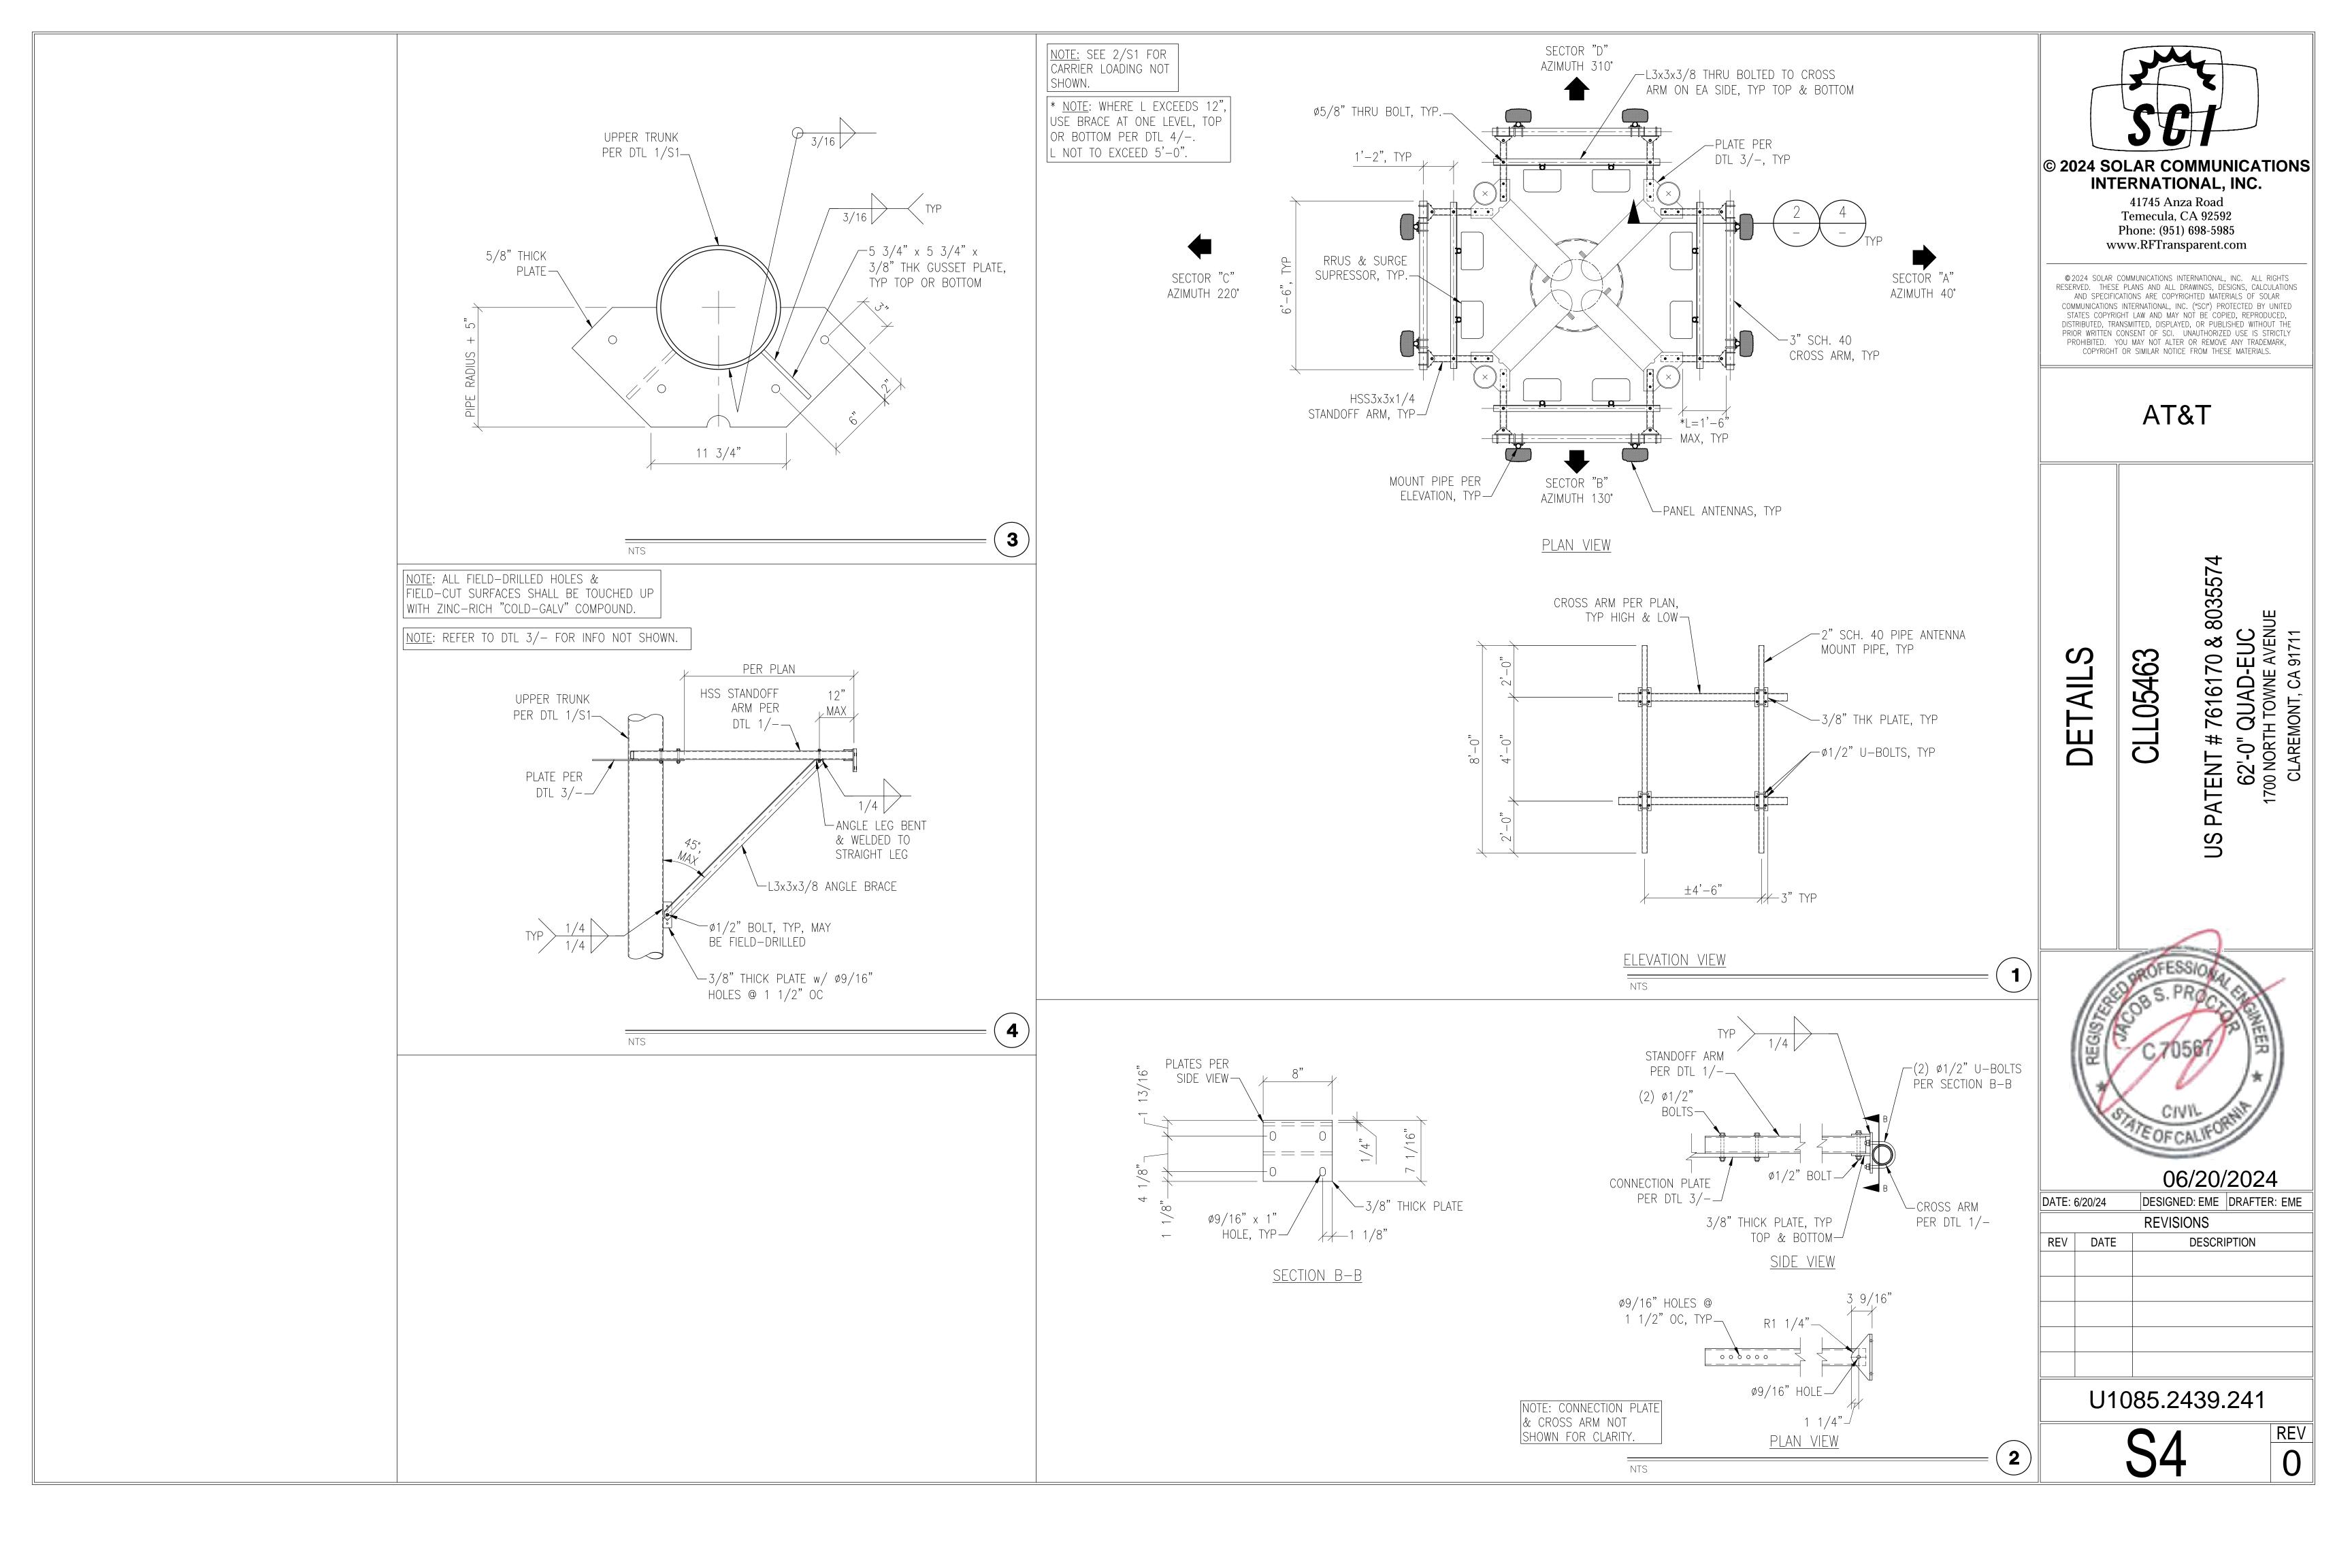



STEEL PLATE PLAN VIEW




ELEVATION VIEW

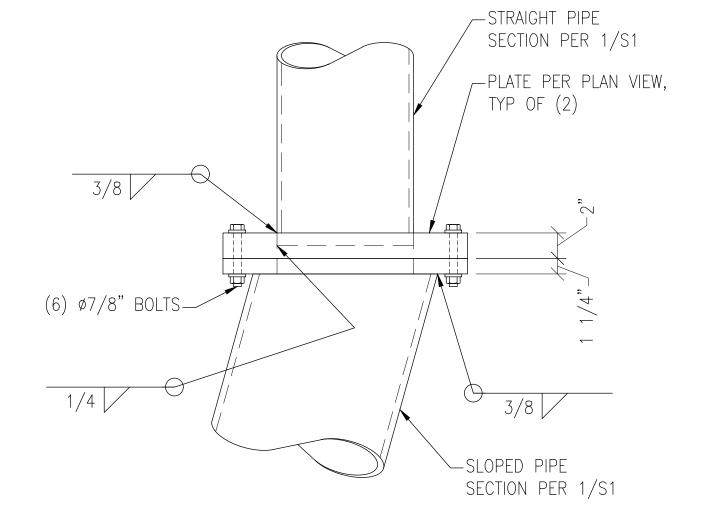NTS



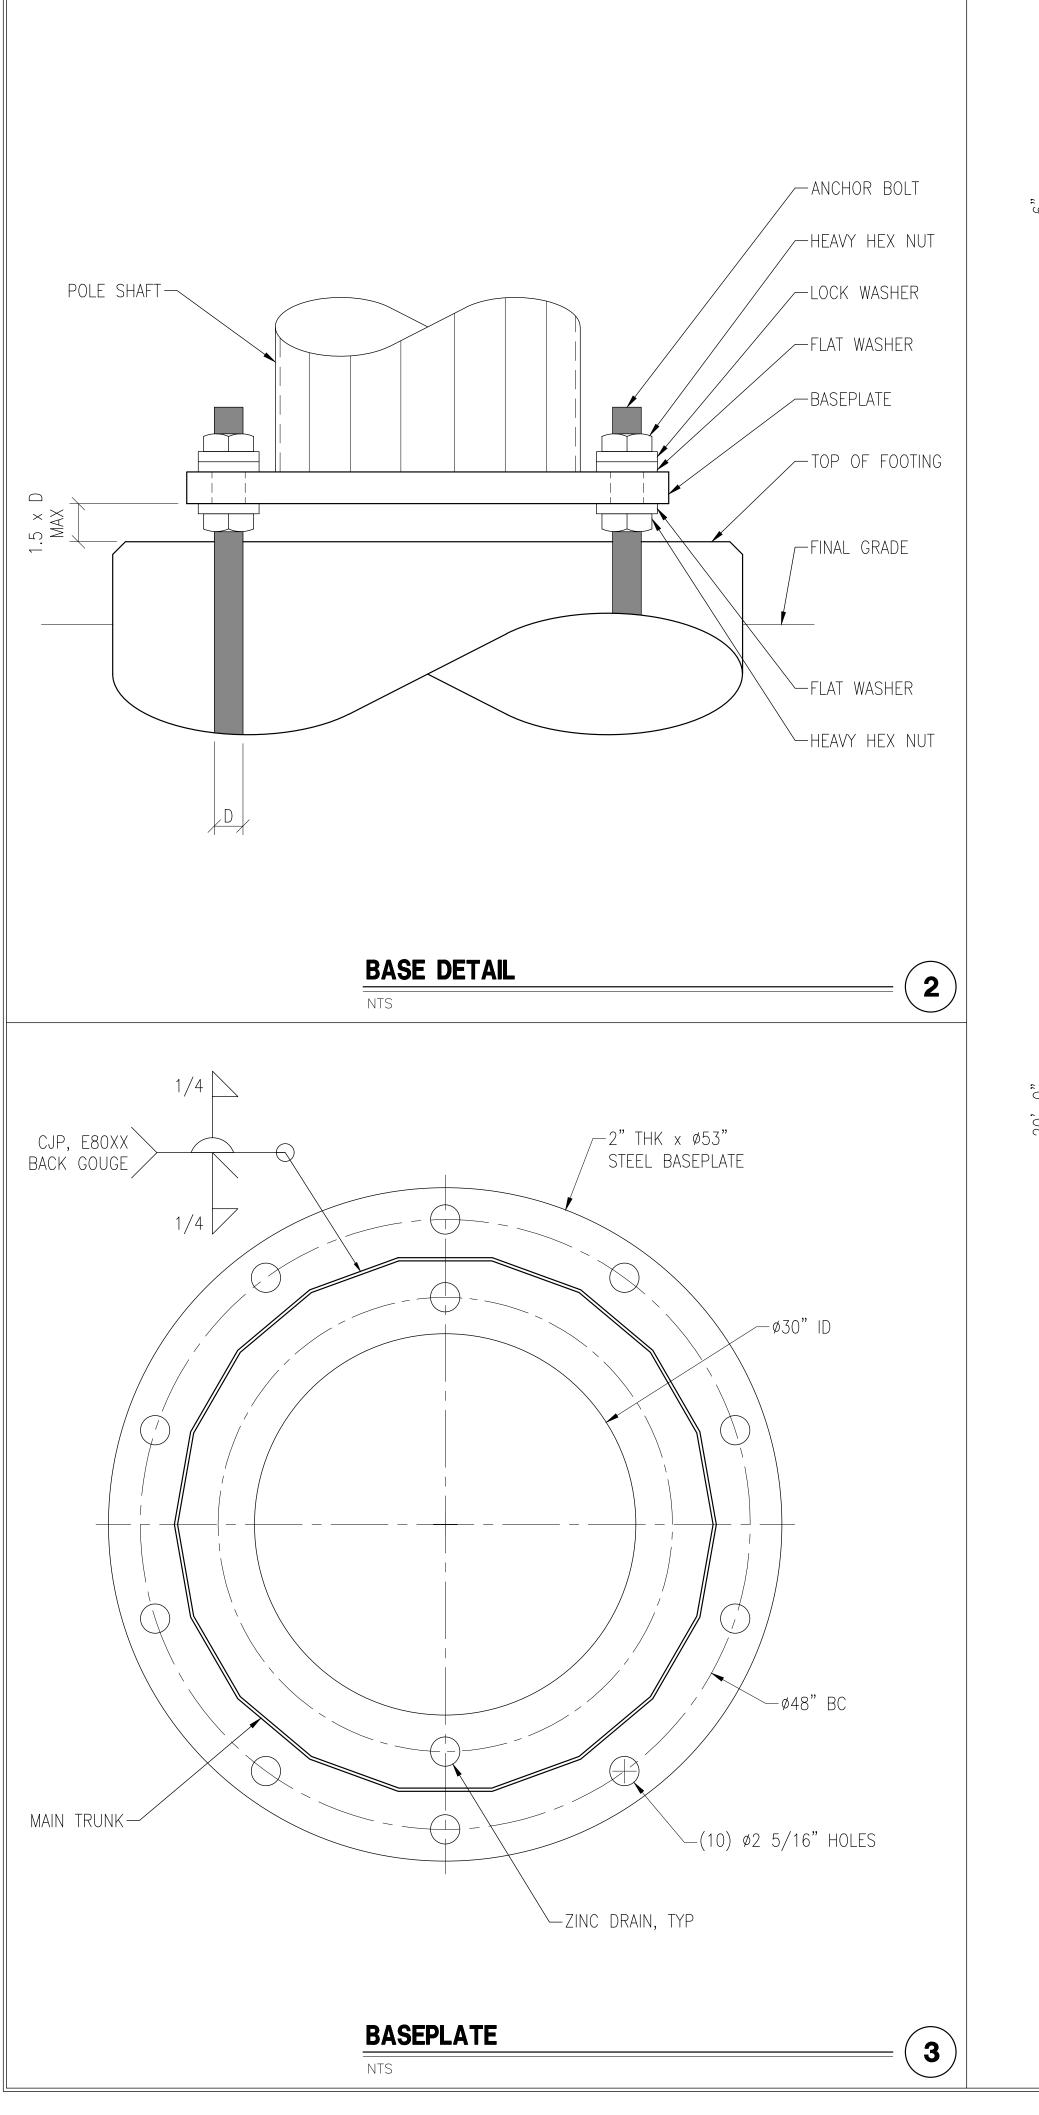


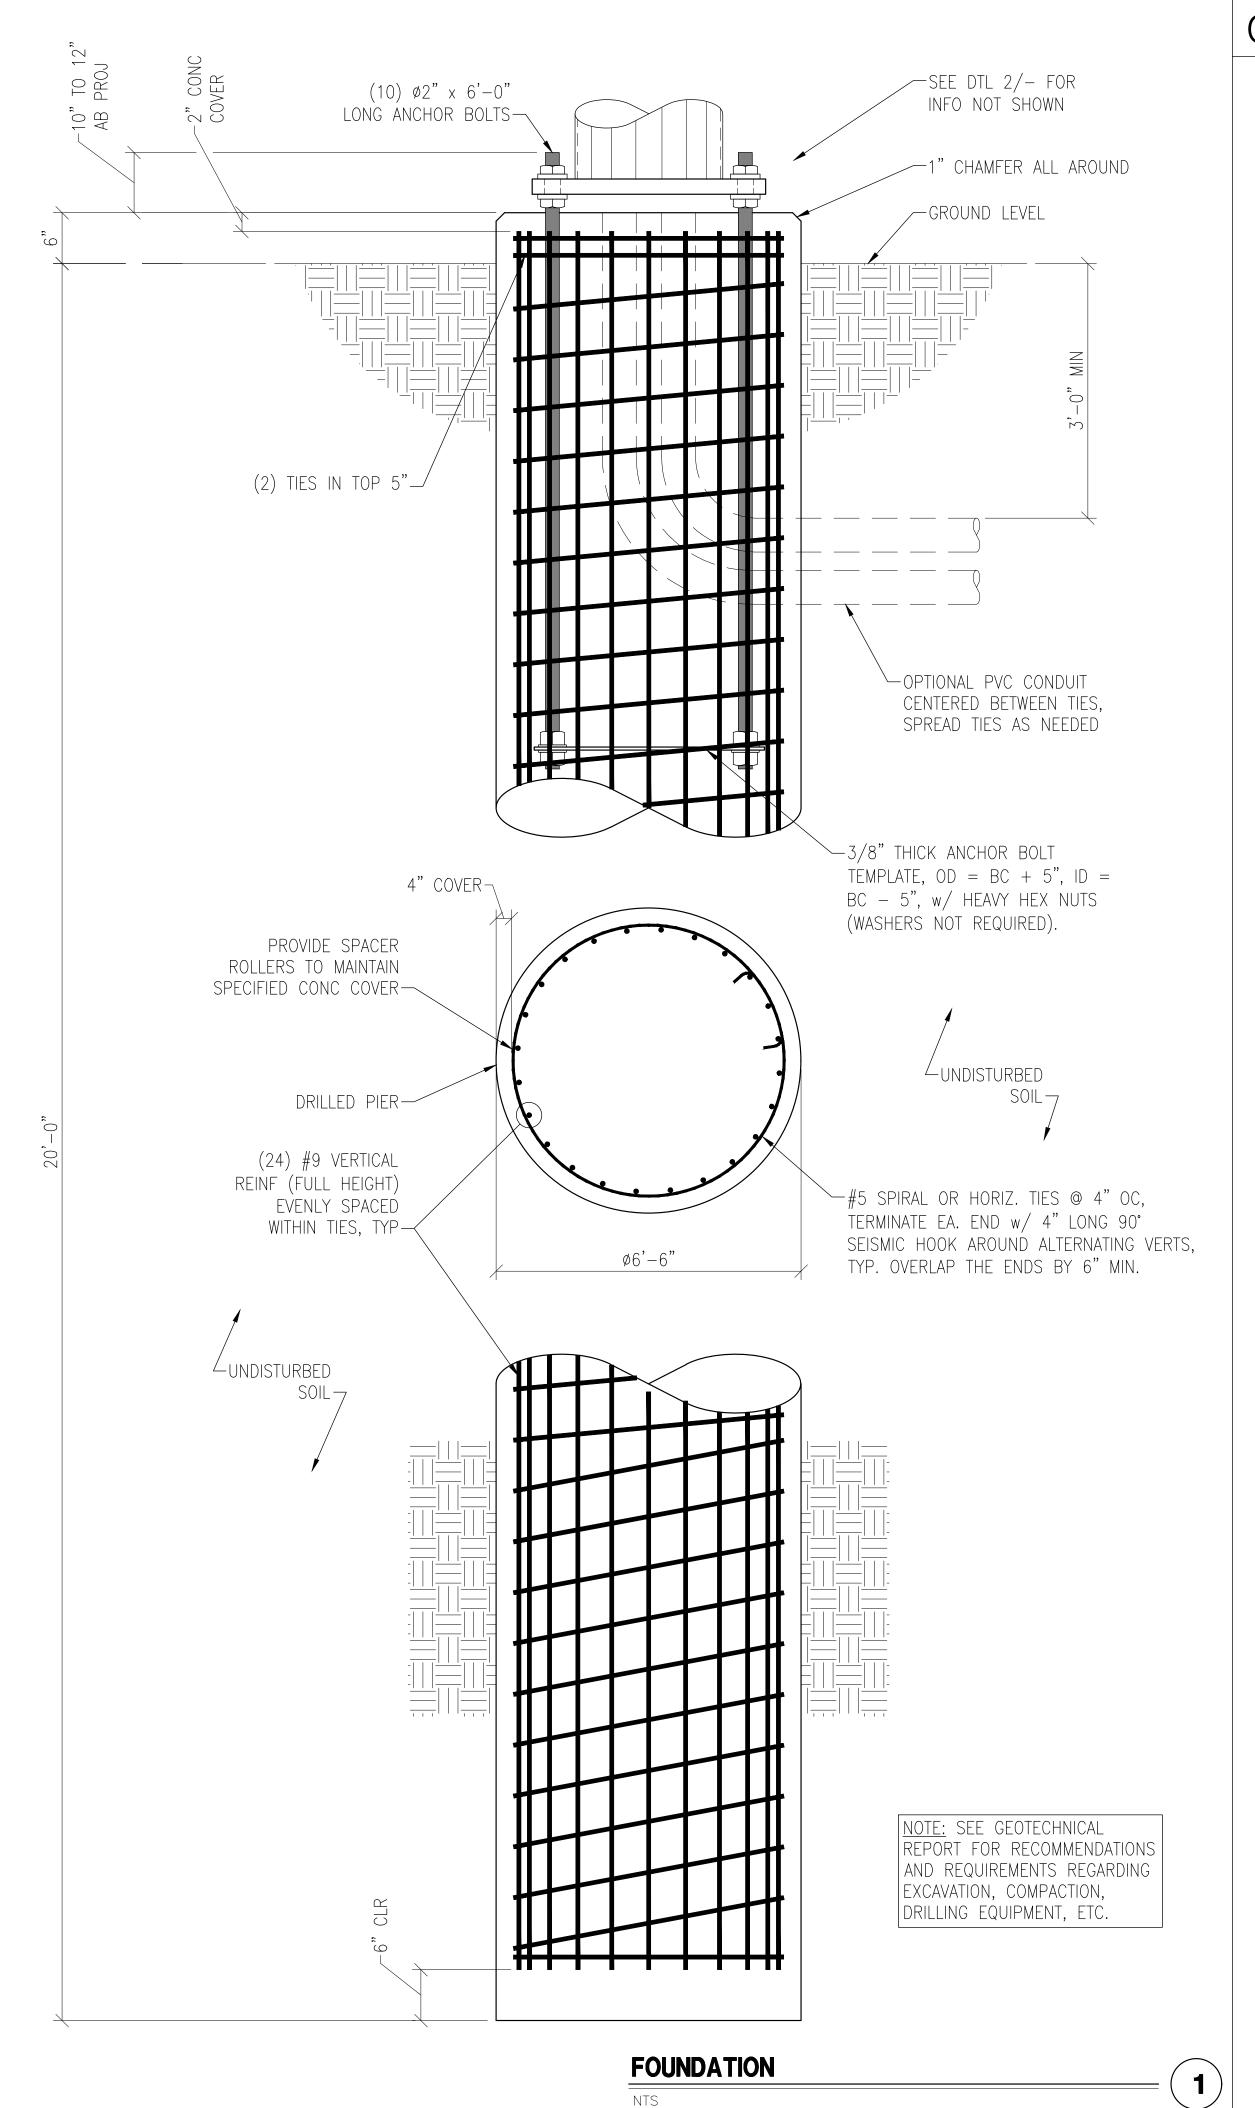

GENERAL NOTES

- 1. CONTRACTOR IS RESPONSIBLE FOR CHECKING AREA FOR UNDERGROUND FACILITIES PRIOR TO EXCAVATING ANY MATERIALS.
- 2. CONTRACTOR SHALL REFER TO SOILS REPORT FOR SITE CONDITIONS AND FURTHER CONSTRUCTION INFORMATION.
- 3. CONTRACTOR SHALL INSPECT AND REMOVE ALL DEBRIS FROM BOTTOM OF EXCAVATION.
- 4. CONTRACTOR SHALL VERIFY ANCHOR BOLT LAYOUT PRIOR TO AND IMMEDIATELY AFTER PLACING CONCRETE. ANCHOR BOLT LAYOUT IS CRITICAL FOR MONOPOLE INSTALLATION.
- 5. CONTRACTOR SHALL USE AND PROVIDE DEFORMED REINFORCING BARS CONFORMING TO ASTM A615 GR 60 (60,000 PSI MIN YIELD). CONTRACTOR SHALL USE STEEL WIRE TO HOLD REINFORCING BARS TOGETHER. IF WELDING REBAR IS PREFERRED, SUBSTITUTE A706 GR 60 DEFORMED BARS.
- 6. ALL CONCRETE SHALL USE TYPE II PORTLAND CEMENT AND HAVE A MINIMUM COMPRESSIVE STRENGTH OF 4000 PSI AT 28 DAYS. CONCRETE SHALL HAVE A MINIMUM OF 6% ENTRAINED AIR (WHERE FROST DEPTH > 0"). CONCRETE SHALL HAVE A MAXIMUM WATER/CEMENT RATIO OF 0.50. CONCRETE SHALL HAVE A SLUMP OF 5" (±1") UNLESS OTHERWISE SPECIFIED IN THE GEOTECHNICAL REPORT. ALL CONCRETE WORK SHALL BE IN ACCORDANCE WITH "THE BUILDING CODE REQUIREMENTS FOR REINFORCED CONCRETE," ACI 318-19.
- CONCRETE SHALL BE CONSOLIDATED USING VIBRATORY METHODS THROUGHOUT DEPTH OF FOUNDATION. VIBRATING LOWER DEPTHS MAY NOT BE ACCOMPLISHED BY TOUCHING REBAR CAGE WITH VIBRATOR.
- 8. CONTRACTOR SHOULD ANTICIPATE THE USE OF A FULL-LENGTH TEMPORARY CASING TO STABILIZE THE EXCAVATION. THE CASING SHALL BE WITHDRAWN DURING THE PLACEMENT OF CONCRETE IN THE EXCAVATED HOLE. CONCRETE SHALL NOT FREE FALL. CONCRETE MAY BE PLACED BELOW WATER USING TREMIE METHODS.
- CONCRETE SHALL BE PLACED TO THE DEPTH INDICATED AND THE ABOVE GRADE PORTION SHALL BE FORMED. THE REBAR CAGE, ANCHOR BOLTS, AND CONCRETE SHALL BE PLACED WITHIN 24 HOURS OF COMPLETING THE EXCAVATION. COLD JOINTS ARE NOT ALLOWED, UNO
- 10. THE CONTRACTOR IS RESPONSIBLE FOR VERIFYING ADEQUATE CONCRETE COVERAGE OVER REINFORCING BARS. UNLESS OTHERWISE NOTED, CONTRACTOR SHALL USE 3" CONCRETE COVER OVER REBAR. TOP OF FOOTING SHALL BE TROWEL LEVEL AND SMOOTH.
- 11. DRILLED PIER FOUNDATION BASED ON THE SOILS REPORT PREPARED BY:

GEOBODEN INC. PROJECT #: CLL05463-1-01 DATE: February 6, 2024

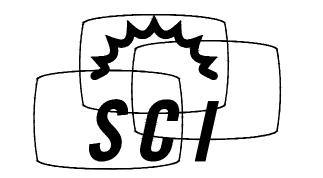

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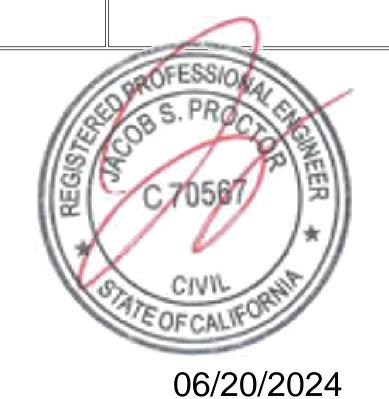
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FOUNDATION

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62'-0" QUAD-EUC 1700 NORTH TOWNE AVENUE CLAREMONT, CA 91711 76161 NS

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DESIGNED: EME | DRAFTER: EME DATE: 6/20/24 REVISIONS REV DATE DESCRIPTION

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